

HINCHINBROOK SHIRE COUNCIL DRFA PROGRAM BETTERMENT PROJECTS Name: Lute Partenbock Name: Lute Partenbock **QUABBAS ROAD**



SCALE 1:2500 (A1)

0 B.L 24.10.22 FOR CONSTRUCTION

HORIZ, DATUM

VERT. DATUM

DRG. FILE

GDA94 ZONE 55 CERTIFICATION

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brett@langtreeconsulting.com.au

DRAWING INDEX

DRAWING NUMBER	DRAWING NAME	REVISION
0794-C-300	COVER SHEET, LOCALITY & DRAWING SCHEDULE	0
0794-C-301	NOTES, TYPICAL SECTIONS AND DETAILS	0
0794-C-302	SETOUT PLAN & SETOUT TABLES	0
0794-C-303	GENERAL ARRANGEMENT AND LONGSECTION	0
0794-C-304	QUABBAS ROAD CROSS SECTIONS SHEET 1 OF 2	0
0794-C-305	QUABBAS ROAD CROSS SECTIONS SHEET 2 OF 2	0
0794-C-306	EROSION AND SEDIMENT CONTROL PLAN	0

SURVEY DATUM PSM 78048 F 409085 524 RL22.043 GDA 94 ZONE 55



DBYD Enquiry Date: 4/08/2022 DBYD Job Number: 32465493

FOR CONSTRUCTION

LOCALITY PLAN

CONFLICTS WITH SERVICES

Service location shall be confirmed on site with relevant Authorities prior to construction work commencing. During construction, no work shall be carried out within 3.0m of ny service without first contracting the relevant Authorit

HINCHINBROOK SHIRE COUNCIL	SCALE		AS	SHOV	WN	
DRFA PROGRAM BETTERMENT PROJECTS	SHEET		1	OF 7	7	
QUABBAS ROAD CH5 - CH298	REVISION	0				
COVER SHEET, LOCALITY & DRAWING SCHEDULE	DRG No.	0794-C-300				

1-11.22 Date: .. Name: Luke Panzenhock Signature: Ralac

7 0m FORMATION 6.0m VARIES BITUMEN SEAL VARIES - EXISTING SURFACE ROAD EDGE GUIDE POSTS DESIGN ALL BATTERS TO BE-(AS SPECIFIED) SURFACE TOPSOILED AND GRASS SEEDED (TYP.) NEW ROAD PAVEMENT AS SPECIFIED BELOW QU/ ROA DATUM R.L. 750mm DEEP x 150mm STABILISED BATTERS AND CUT OFF WALL CUTTOFF WALL TO BE 150mm THICK TYPE 2.3 @ 4% CEMENT

QUABBAS ROAD

TYPICAL ROAD CROSS SECTION SCALE 1 : 50 (A1)

GENERAL NOTES:

GENERAL:

- ALL WORKS AND MATERIALS MUST BE IN ACCORDANCE WITH CURRENT LOCAL AUTHORITY POLICIES, SPECIFICATIONS, STANDARD DRAWINGS AND AUSTRALIAN STANDARDS.

 THE CONTRACTOR MUST TAKE ALL NECESSARY MEASURES TO PROTECT NEARBY PROPERTY OWNERS FROM DUST POLLUTION DURING ALL PHASES OF WORKS. FINISHED AREAS OF EARTHWORKS MUST BE KEPT WATERED WHERE NECESSARY UNTIL A SATISFACTORY GRASS COVER IS ACHIEVED.

 ALL CONSTRUCTION WORKS ARE TO BE JOINED NEATLY TO EXISTING SHEALE.
- PUBLIC UTILITIES DESPITE THE POSITION OF PUBLIC UTILITIES, FITTINGS, PIPES, POLES, MANHOLES, ETC MAY BE INDICATED ON THE DRAWINGS, NO RESPONSIBILITY WILL BE ACCEPTED BY THE PRINCIPAL FOR THE ACCURACY OF THE REPRESENTATION OR THE
- 5. LOCATION AND LEVEL OF EXISTING SERVICES AND STRUCTURES HAS BEEN PLOTTED FROM AVAILABLE RECORDS AND IS TO BE CONSIDERED INDICATIVE ONLY. THE CONTRACTOR MUST ACCURATELY LOCATE THESE ON SITE PRIOR TO COMMENCING WORKS AND MUST PROTECT ALL EXISTING SERVICES DURING CONSTRUCTION. ANY DAMAGE TO EXISTING SERVICES MUST BE REPAIRED AT THE CONTRACTORS EXPENSE.

 VEGETATION OUTSIDE WORK AREAS MUST NOT BE DISTURBED UNLESS SPECIFICALLY AUTHORIZED BY THE SUPERINTENDENT.
- IT IS THE RESPONSIBILITY OF THE CONTRACTOR TO COMPLY WITH ALL RELEVANT LEGISLATION.
- IT IS THE RESPONSIBILITY OF THE CONTRACTOR TO MAINTAIN THE STABILITY OF ANY 1. THE RESPONSIBILITY OF THE CONTRACTOR TO MAINTAIN THE STABILITY OF ANY TEMPORARY WORKS ON THE SITE.

 1. THE CONTRACTOR MUST CONFIRM THE ACCURACY OF ALL SET OUT AND CONFIRM ALL LEVELS WITH THE SUPERINTENDENT PRIOR TO COMMENCING CONSTRUCTION.

 10. THE SURVEY LEVEL DATUM IS AHD AND THE CO-ORDINATE DATUM IS LOCAL AS PROVIDED BY HINCHINBROOK SHIRE COUNCIL.

 11. THESE DRAWINGS ARE TO BE READ IN CONJUNCTION WITH THE LOCAL AUTHORITY

- SPECIFICATIONS AND THE PROJECT SPECIFICATIONS. IN THE EVENT OF A DISCREPANCY, REFER TO THE SUPERINTENDENT FOR CLARIFICATION.
- REFER TO THE SUPERINTENDENT FOR CLARIFICATION.

 THESE DRAWINGS MUST BE READ IN CONJUNCTION WITH DRAWINGS PREPARED BY OTHER RELATED CONSULTANTS, ALL PROJECT SPECIFICATIONS AND WITH SUCH OTHER WRITTEN INSTRUCTIONS AS MAY BE ISSUED DURING THE COURSE OF THE WORK. ALL THE DISCREPANCIES MUST BE REFERRED TO THE SUPERINTENDENT FOR DECISION BEFORE PROCEEDING WITH THE WORK
- ALL DIMENSIONS RELEVANT TO SETTING OUT AND OFF-SITE WORK MUST BE AS INDICATED ALL DIMENSIONS RELEVANT TO SETTING OUT AND OFF-SIE WORK MUST BE AS INDICATED ON THESE DRAWINGS AND MUST BE VERIFIED BY THE CONTRACTOR BEFORE CONSTRUCTION AND/OR FABRICATION IS COMMENCED. THE ENGINEERS DRAWINGS MUST NOT BE SCALED, UNLESS SPECIFICALLY NOTED OTHERWISE.

 DURING CONSTRUCTION THE CONTRACTOR MUST BE RESPONSIBLE FOR MAINTAINING PROPOSED AND EXISTING WORKS IN A STABLE CONDITION AND ENSURING NO PART MUST
- BE OVER STRESSED UNDER CONSTRUCTION ACTIVITIES.

 SAFETY REQUIREMENTS MUST BE IN ACCORDANCE WITH THE REQUIREMENTS OF THE WORK PLACE, HEALTH AND SAFETY ACT.
 THE APPROVAL FOR A SUBSTITUTION MAY BE SOUGHT FROM THE SUPERINTENDENT BUT
- IS NOT AN AUTHORISATION FOR A VARIATION. ANY VARIATION MUST BE APPROVED BY THE SUPERINTENDENT BEFORE WORK COMMENCES.
- THE ACCESS FOR THE WORK SITE MUST BE AS INDICATED ON THE CONTRACT OR AS APPROVED BY THE SUPERINTENDENT AND THE LOCAL AUTHORITIES. THE CONTRACTOR MUST OBTAIN ALL NECESSARY AND RELEVENT PERMITS. IT IS THE CONTRACTORS RESPONSIBILITY TO CONSTRUCT AND MAINTAIN ACCESS AS REQUIRED TO ALL PARTS OF CONTRACTORS WORK AREA.
- THE CONTRACTORS COMPOUND MUST BE LOCATED AS APPROVED BY SUPERINTENDENT. CONTRACTOR MUST UNDERTAKE ALL WORKS IN PROXIMITY TO EXISTING SERVICES AND INFRASTRUCTURE IN ACCORDANCE WITH THE RELEVANT UTILITY / AUTHORITY POLICIES
- AND PROCEDURES.
- AND PROCEDURES.

 20. BEFORE PROCEEDING WITH THE WORK ANY DISCREPANCIES IN THE CONTRACT DOCUMENTS SHALL BE REFERRED FOR DECISION TO THE ENGINEER.

 21. ALL MATERIALS & WORKMANSHIP SHALL BE IN ACCORDANCE WITH THE SPECIFICATIONS AND THE LOCAL AUTHORITY'S BY-LAWS.
- 22. THE CONTRACTOR IS RESPONSIBLE TO OBTAIN ALL RELEVANT APPROVALS PRIOR TO

HORIZ, DATUM

VERT, DATUM DRG, FILE DESIGN

DRAWN

B.I ANGTRE

CJOY

SIGNAGE AND LINEMARKING:

- 1. PRIOR TO INSTALLATION OF SIGNS, THE CONTRACTOR SHALL CHECK FOR POSSIBLE SERVICE CONFLICTS, AND IF PRESENT, NOTIFY THE RELEVANT
- SERVICE AUTHORITY.

 ALL SETOUT TO BE CONFIRMED ON SITE.
- ALL EXISTING SIGNS NOT CONFLICTING WITH PROPOSED WORKS ARE TO REMAIN. EXISTING SIGNS CONFLICTING MUST BE RELOCATED TO SUIT NEW ROADWORKS.
- ALL PAVEMENT MARKING AND SIGNAGE IS TO BE CONSTRUCTED IN ACCORDANCE WITH THE CURRENT QUEENSLAND MANUAL OF UNIFORM
- TRAFFIC CONTROL DEVICES.

 5. NEW PAVEMENT MARKING SHALL JOIN SMOOTHLY TO EXISTING WHERE REQUIRED
- ALL PAVEMENT MARKINGS AND LINES TO BE SUPPLEMENTED WITH RETRO-REFLECTIVE RAISED PAVEMENT MARKERS IN ACCORDANCE WITH THE CURRENT "MANUAL OF UNIFORM TRAFFIC CONTROL DEVICES-PART 2".
- PLACEMENT TO BE IN ACCORDANCE WITH MUTCD.
 ALL EXISTING REDUNDANT SIGNS TO BE REMOVED/RELOCATED
- 8. PROVIDE ROAD EDGE POSTS IN ACCORDANCE WITH MANUAL OF UNIFORM

SCOUR PROTECTION AT PIPE OUTFALLS							
PIPE SIZE - DIA (mm)	D ₅₀ (mm)	THICKNESS (mm)					
375	200	300					
450	200	300					
525	300	300					
600	300	500					
675	300	500					
>750	300	500					

VEGETATION PROTECTION:


- 1. PRIOR TO CLEARANCE WORKS COMMENCING ON SITE, A JOINT INSPECTION MUST BE UNDERTAKEN TO IDENTIFY SELECTED TREES AND / OR SHRUBS WHICH ARE TO REMAIN UNDISTURBED. THESE MUST BE MARKED BY THE SUPERINTENDENT WITH COLOURED TAPE OR SIMILAR MARKS. THE CONTRACTOR MUST TAKE CARE NOT TO DAMAGE OR REMOVE ANY OF THESE TREES AND SHRUBS IN CARRYING OUT THE WORKS OF THE
- UNLESS DIRECTED BY A PROJECT ARBORIST / ECOLOGIST WHEN WORKING WITHIN 4m OF TREES, RUBBER OR HARDWOOD GIRDLES SHOULD BE CONSTRUCTED WITH 1.8m BATTENS CLOSELY SPACED AND ARRANGED VERTICALLY FROM GROUND LEVEL. GIRDLES MUST BE STRAPPED TO TREES PRIOR TO CONSTRUCTION AND REMAIN UNTIL COMPLETION.
- ANY TREE LOPPING REQUIRED SHOULD BE UNDERTAKEN BY A PROFESSIONAL ARBORIST.
- THE CONTRACTOR IS NOT TO DISTURB OR CUT VEGETATION WITHOUT THE SUPERINTENDENTS APPROVAL.

 THE CONTRACTOR MUST EMPLOY A PROFESSIONAL ARBORIST WHO MUST
- ASSIST WITH THE WORK TO PROTECT TREES (IF NECESSARY).

NOTE: QUABBAS ROAD PAVEMENT THICKNESS HAS BEEN DETERMINED FROM HSC SUPPLIED AADT = 28 AND THE RECOMMENDED DESIGN CBR OF 6.0%, REFER PGI GEOTECHNICAL REPORT PGC1821000_4. CONTRACTOR TO CONFIRM THE PAVEMENT AND SEAL DESIGN PRIOR TO PLACEMENT OF ANY PAVEMENT LAYERS OR SEALING.



FOR CONSTRUCTION 24 OCTOBER 202

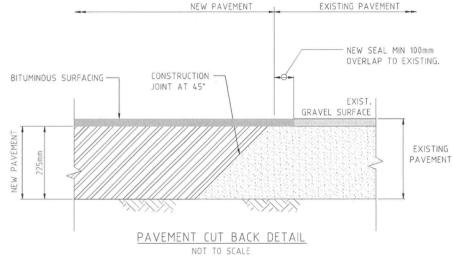


SPACING FOR GUIDE POSTS

	SPACIN	G (m)
CURVE RADIUS	ON OUTSIDE OF CURVE	ON INSIDE OF CURVE
<100	6	12
100-199	10	20
200-299	15	30
300-399	20	40
400-599	30	60
600-799	40	60

NOTE: APPLY 150m SPACING OF GUIDEPOSTS ON ALL STRAIGHTS. MAXIMUM SPACING OF 60m IN FOG PRONE AREAS.

1st COAT PRIMERSEAL AMC7 @ 2.0L/m2 & 14mm @ 100m2/m3 2nd COAT BITUMEN SEAL S35E/S10E @ 1.4L/m2 & 7mm @ 140m2/m3

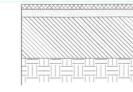

225mm BASE COURSE (TYPE 2.3 @ 4% CEMENT) COMPACTED TO 100% MAXIMUM DRY DENSITY (STANDARD) RECOMMENDED DESIGN SUBGRADE CBR 6.0%

COMPACTED SUBGRADE (TO BE PROOF ROLLED PRIOR TO LAYING ANY PAVEMENT) ASSUMED CBR = 6.0%

NEW ROAD PAVEMENT NOT TO SCALE

S				
REVISIONS				
SINS				
R.	0	B.L	24.10.22	FOR CONSTRUCTION

DESCRIPTION


No. BY DATE

GDA94 ZONE 55		CERTIFICATION BOKINGTON					
9	AHD	B. LANGTREE PPEQ 11932					
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m	0400 699 979

brett@langtreeconsulting.com.au

HINCHINBROOK SHIRE COUNCIL	SCALE		AS	SHO	WN	
DRFA PROGRAM BETTERMENT PROJECTS	SHEET		2	OF	7	
QUABBAS ROAD CH5 - CH298	REVISION	0				
TYPICAL SECTION AND DETAILS	DRG No.	0794-C-301				

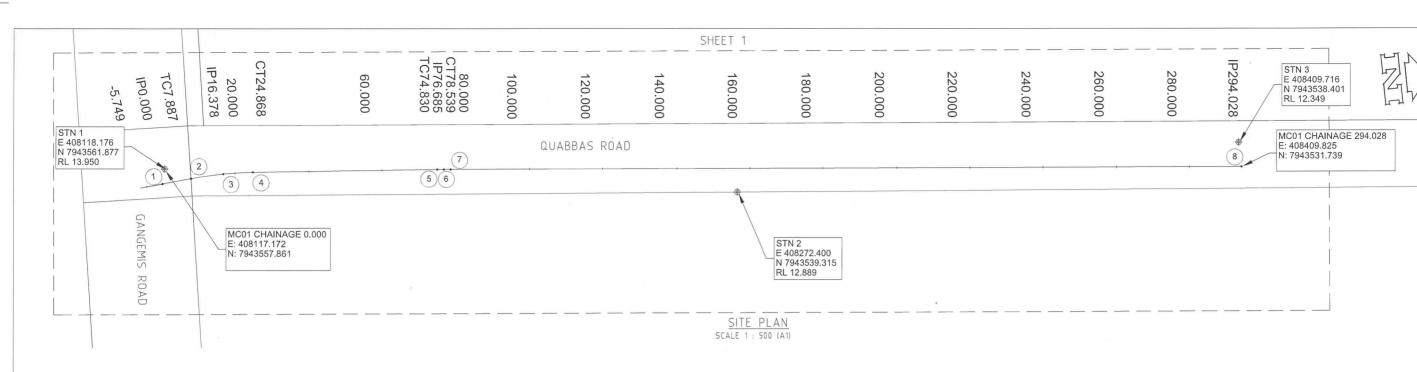

		_	ONTROL LIN	E MC01 SETO	JT TABLE	: =		
POINT NUMBER	CHAINAGE	TYPE	EASTING	NORTHING	LEVEL	Length	BEARING	RADIUS
1	0.000	IP	408117.172	7943557.861	13.922			
2	7.887	TC	408125.034	7943558.495	13.958		85'23'15.92"	
3	16.378	IP	408133.517	7943559.18	13.976	16.981		100
4	24.868	CT	408141.994	7943558.421	13.968		95*07'01.32"	
5	74.830	TC	408191.757	7943553.964	13.855		95'07'01.32"	197
6	76.685	IP	408193.604	7943553.799	13.857	3.709		300
7	78.539	CT	408195.449	7943553.611	13.859		95*49'31.65"	
8	294.028	IP "	408409.825	7943531.739	12.968		95°49'31.65"	

SURVEY CONTROL POINT TABLE									
Point #	Easting	Northing	Level	Code					
2259	411406.327	7942799.617	9.079	sm iron spike					
12002	408118.176	7943561.877	13.950	STN					
12003	408272.461	7943539.311	12.896	STN					
12004	408409.774	7943538.428	12.353	STN					
78084	409085.524	7945051.963	22.043	PSM					



Date: 1.11. 22

Name: Luke Panzenback Signature: Dall

FOR CONSTRUCTION 24 OCTOBER 2022


HINCHINBROOK SHIRE COUNCIL

0.05	0	0.05	0.1	0.15	0,2	0.25m
SCALE	1:1500 (@ A1		SCA	LE 1:3000)@ A3


					HORIZ. DA	TUM GDAS	94 ZONE 55	Bakingtree
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VISIC		_			DRG. FILE		DATE	COPYRIGHT © These designs and drawings are copyright and are not to be used or reproduced without the written permission of LANGTREE CONSULTING
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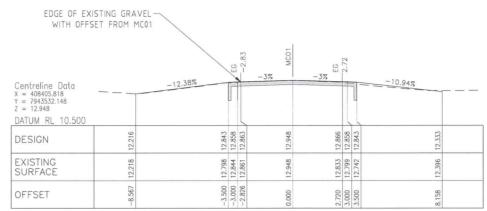


DRFA PROGRAM BETTERMENT PROJECTS
QUABBAS ROAD CH5 - CH298
SETOUT PLAN & SETOUT TABLES

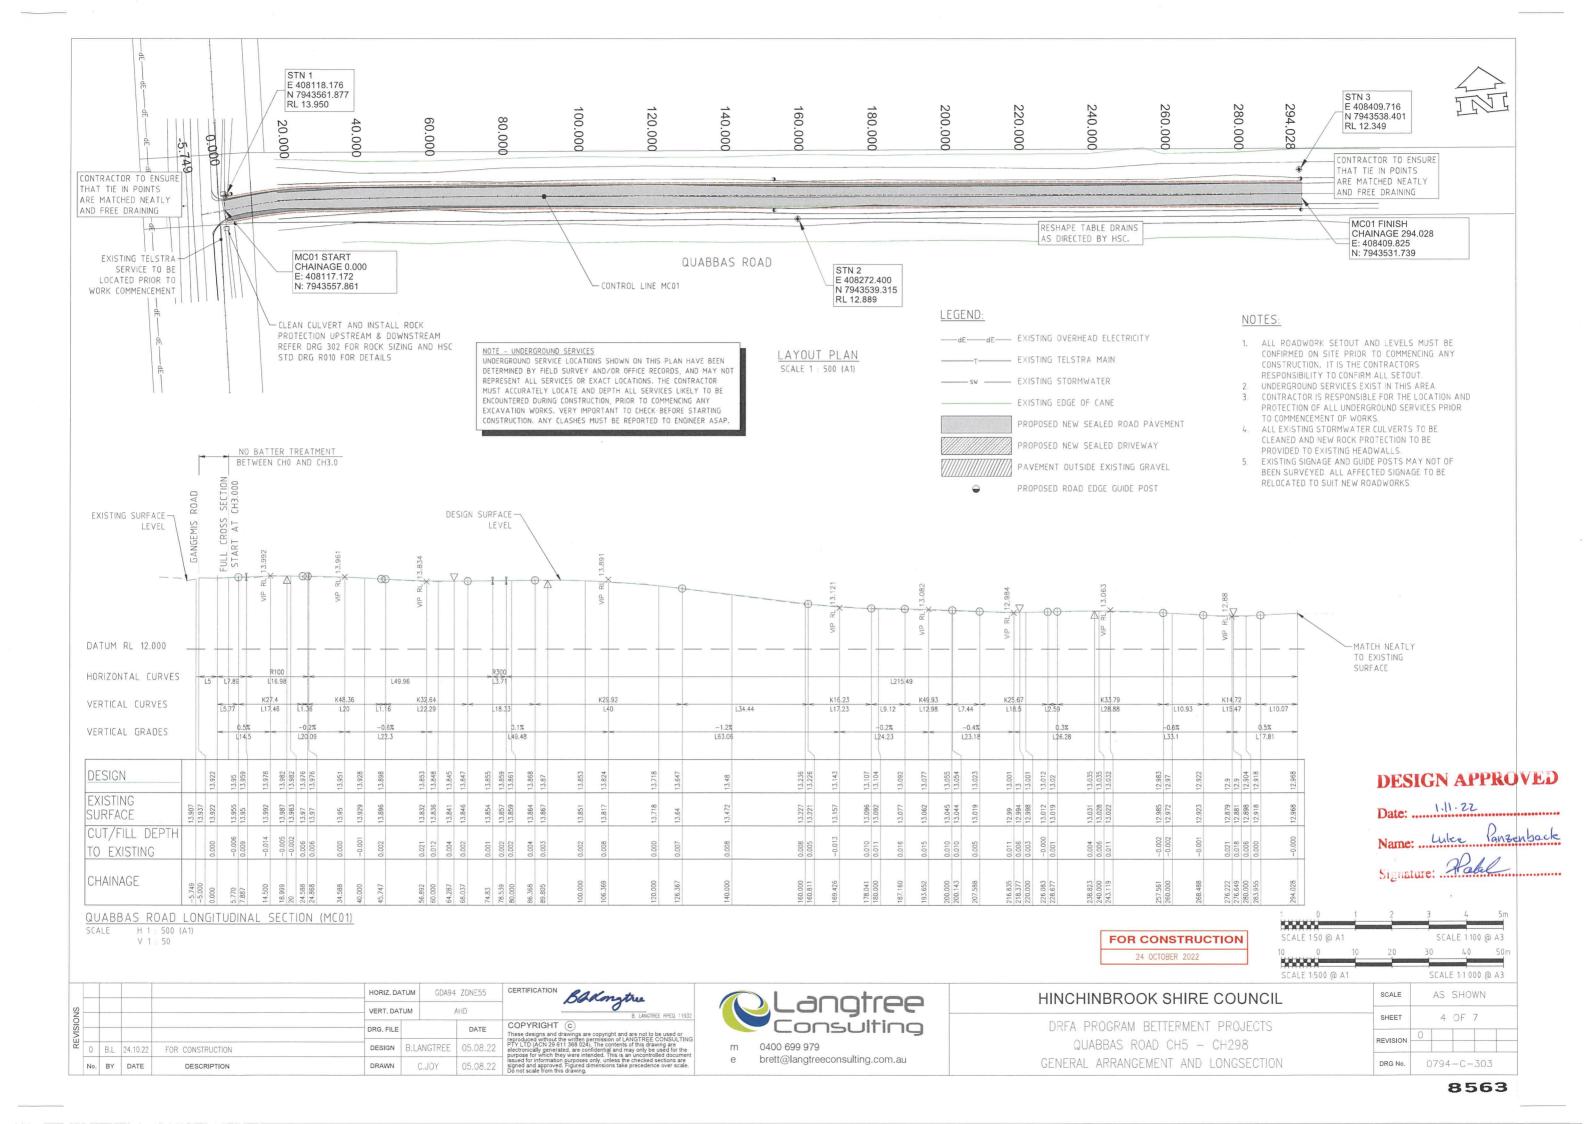


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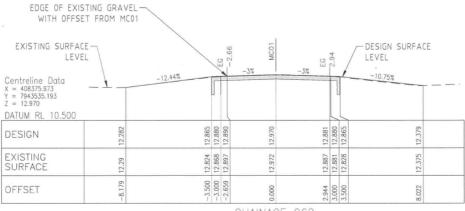


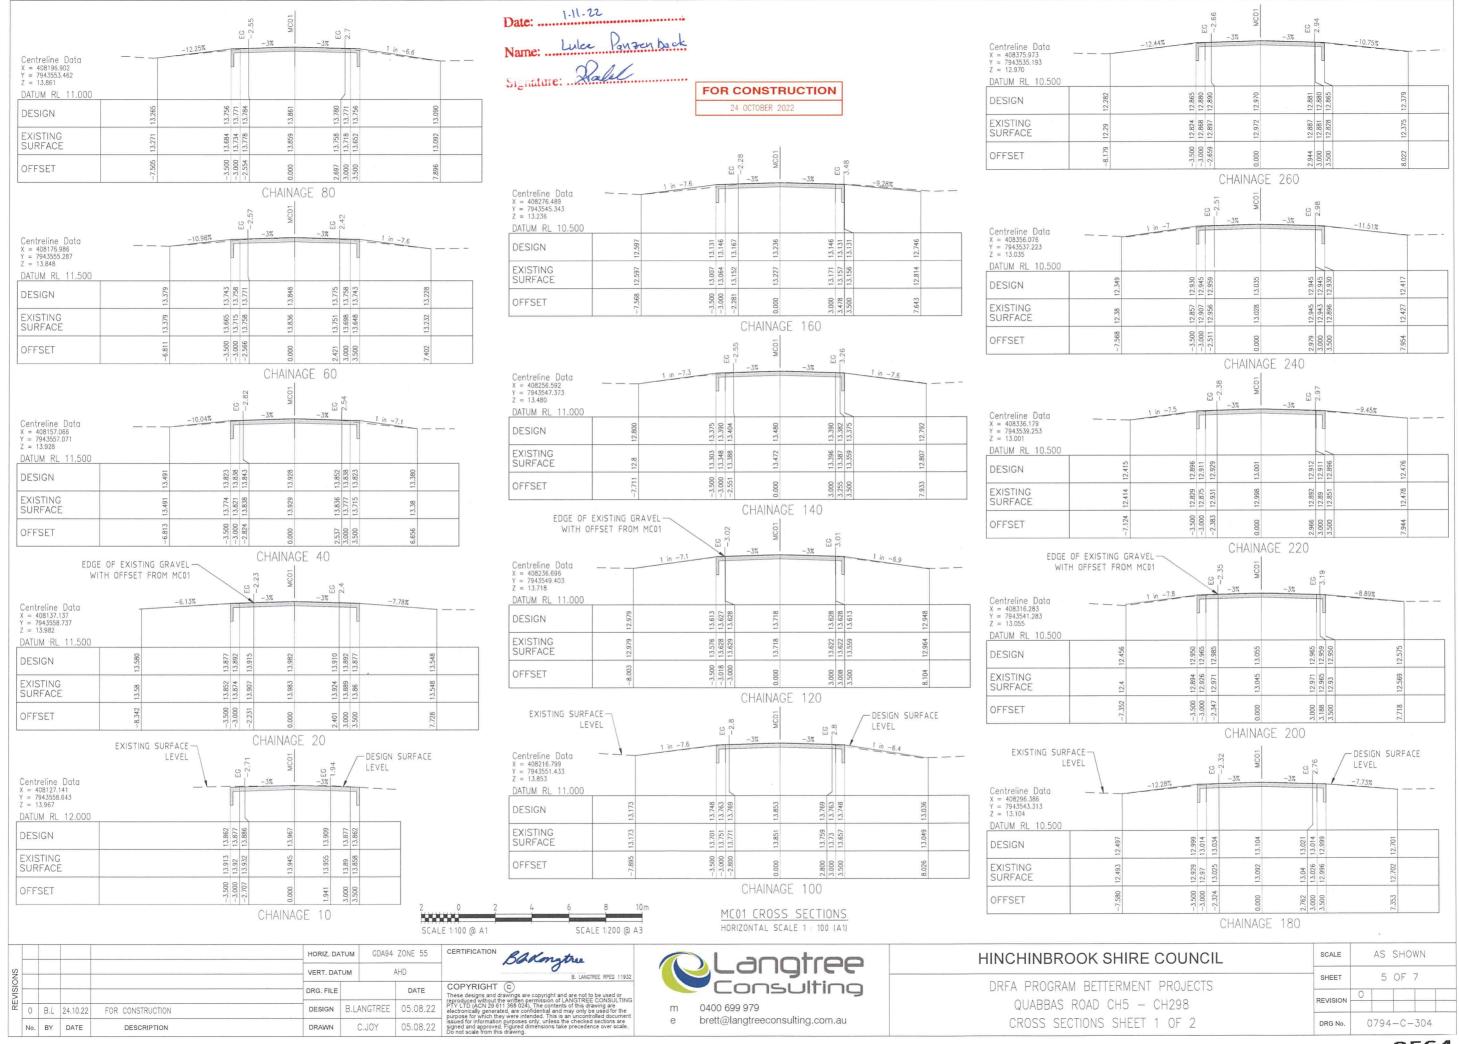

CHAINAGE 290

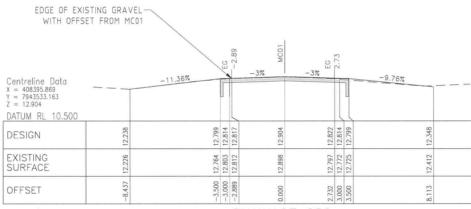

CHAINAGE 280



CHAINAGE 260



FOR CONSTRUCTION

MC01 CROSS SECTIONS HORIZONTAL SCALE 1 : 100 (A1)

					HORIZ, DA	TUM GDA94	ZONE 55	CERTIFICATION BOKONSTILL
SNO					VERT. DAT	UM	AHD	B. LANGTREE RPEQ 11932
VISION					DRG. FILE		DATE	COPYRIGHT © These designs and drawings are copyright and are not to be used or reproduced without the written permission of LANGTREE CONSULTING
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0400 699 979 brett@langtreeconsulting.com.au

HINCHINBROOK SHIRE COUNCIL	SCALE	AS	SHOWN
DRFA PROGRAM BETTERMENT PROJECTS	PROJECTS		5 OF 7
QUABBAS ROAD CH5 - CH298	REVISION	0	
CROSS SECTIONS SHEET 2 OF 2	DRG No.	0794-C-305	

8565

DESIGN	APPROVED
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Deter	1.11-22
Date	1 11

Name: Luke Panzenbock

Signature: Ralle



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EROSION AND SEDIMENT

CONROL PLAN

SCALE 1: 500 (A1)

EROSION AND SEDIMENT CONTROL NOTES:

ROAD

- DETAILS SHOWN ON THESE DRAWINGS REPRESENT PROPOSED MINIMUM REQUIREMENTS FOR ONE POSSIBLE METHOD TO ACHIEVE COMPLIANCE WITH LEGISLATION TO PREVENT ENVIRONMENTAL HARM FROM EROSION AND SEDIMENT TRANSFER OFF THE CONSTRUCTION SITE
- 2. IT IS THE CONTRACTOR'S RESPONSIBILITY TO MONITOR SITE AND WEATHER CONDITIONS AND WATER QUALITY LEAVING THE SITE AND IMPLEMENT APPROPRIATE MEASURES TO COMPLY WITH THE STATUTORY REQUIREMENTS.
- 3. SHOULD THIS REQUIRE ADDITIONAL MEASURES OR ALTERATIONS TO THE DETAILS SHOWN ON THESE DRAWINGS THE CONTRACTOR IS TO PROVIDE WORK METHOD STATEMENTS AND/OR REVISED DRAWINGS TO THE ENGINEER CLEARLY DETAILING THE PROPOSED CHANGES AND PRIOR TO IMPLEMENTING THEM.
- 4. FOR STANDARD SEDIMENT CONTROL DEVICE DETAILS REFER TO IECA STANDARD DRAWINGS REFER TO TABLE BELOW.
- 5. MAINTAIN EROSION CONTROL MECHANISMS IN WORKING ORDER DURING ENTIRE CONSTRUCTION.
 6. SEDIMENT LOSS FROM THE WORK SITE MUST BE MANAGED IN ACCORDANCE WITH CURRENT RELEVANT ENVIRONMENTAL GUIDELINES LEGISLATION. THIS WILL NECESSITATE THE USE OF APPROPRIATE EROSION AND SEDIMENT CONTROLS. THESE MUST BE IMPLEMENTED AT THE SITE ESTABLISHMENT PHASE AND MAINTAINED THROUGHOUT THE CONSTRUCTION PERIOD.
- 7. PRE-DISTURBANCE SOIL PROFILES AND COMPACTION LEVELS MUST BE REINSTATED.
- 8. ALL VEHICLES EXITING FROM THE SITE ARE TO BE WASHED DOWN, CLEANED AND TREATED SO AS TO PREVENT MATERIAL BEING TRACKED OR DEPOSITED ON PUBLIC ROADS. INSTALL MEASURES FOR CONTROL OF WASH DOWN.
- MEASURES FOR CONTROL OF WASH DOWN.

 9. ALL DISTURBED AREAS MUST BE LEFT IN A STABLE CONDITION. REFER TO ROADWORKS
 AND DRAINAGE LAYOUTS AND TYPICAL SECTIONS AND DETAILS FOR BATTER TREATMENTS.
- 10. ALL VEGETATION WITHIN 4m OF GENERAL MACHINE OPERATION MUST BE PROTECTED WITH A STAR PICKET AND ROPE FENCE CONSTRUCTED AT LEAST 1m CLEAR OF THE VEGETATION;
- 11. EROSION AND SEDIMENT CONTROL IS THE RESPONSIBILITY OF THE CONTRACTOR WHO MUST COMPLY WITH COUNCIL REQUIREMENTS.
- 12. PROGRESSIVELY CLEAN UP ALL LITTER AND OIL LEAKS, AND PREVENT WASH OFF OF CEMENT SLURRY AND AC PRIME.
- 13. SUITABLE DUST CONTROL MEASURES TO BE IMPLEMENTED AT ALL TIMES.
- 14. THE CONTRACTOR MUST ADVISE THE SUPERINTENDENT ONCE THE EROSION AND SEDIMENT CONTROL MEASURES HAVE BEEN INSTALLED.
- 15. EROSION AND SEDIMENT CONTROL MEASURES MUST REMAIN IN PLACE UNTIL REHABILITATION MEASURES HAVE ESTABLISHED.

	IECA STANDARD DRAWINGS	
SHEET NUMBER	SHEET TITLE	
RCD 01	CHECK DAMS	
CFB-01	COMPOST FILTER BERM	

LEGEND:

0 B.L 24.10.22

FOR CONSTRUCTION

800

CHECK DAMS OR APPROVED EQUIVALENT
SWALE DRAIN PROTECTION (AS DIRECTED BY HSC.)

HORIZ, DATUM

VERT. DATUM

DRG. FILE

DESIGN

GDA94 ZONE 55

DATE

05.08.22

05.08.22

11032	

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DESIGN APPROVED

Date: 1.11.22
Name: Luke Panzenbock

Signature: Dalel

 FOR CONSTRUCTION
 0.05
 0.05
 0.105
 0.1
 0.15
 0.2
 0.25m

 24 OCTOBER 2022
 SCALE 1.1500 @ A1
 SCALE 1.3000 @ A3

HINCHINBROOK SHIRE COUNCIL SCALE				AS SHOWN			
DRFA PROGRAM BETTERMENT PROJECTS	SHEET		7	OF	7		
QUABBAS ROAD CH5 - CH298	REVISION	0					
EROSION AND SEDIMENT CONTROL PLAN	DRG No.	0794-C-306					