

#### THE CITY OF NEWCASTLE

This plan/document is referred to in

# **Development Application No: DA2023/00420**

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#### <u>LEGEND</u>

EXISTING KERB INLET PIT EXISTING STORMWATER PIT BOLLARD ROLLER DOOR / ROLLER SHUTTER EXISTING SEWER INSPECTION SHAFT MS EXISTING SEWER MAINTENANCE SHAFT -----s -- EXISTING SEWER MAIN

> 8 04.05.23 DA REVIEW / AMENDMENTS 7 11.04.23 CLIENT AMENDMENTS 6 31.03.23 DEVELOPMENT APPLICATION ISSUE MC 5 08.03.23 CLIENT AMENDMENTS 4 06.03.23 BUILDING DESIGN REVISIONS 3 30.11.22 CLIENT AMENDMENTS DRAWN

REV. DATE DESCRIPTION

design • construction • management

**ENGINEERING SOLUTIONS** 

GCA Engineering Solutions
1 Hartley Drive (PO Box 3337), Thornton NSW 2322 Ph 02 4964 1811 www.gca.net.au

Project Title

PROPOSED INDUSTRIAL DEVELOPMENT Project Address 11E & 11D COBBANS CLOSE BERESFIELD

BALLEN PTY LTD

Project Status DEVELOPMENT APPLICATION


Drawing Title SITE PLAN

20.8 ( EX LOADING ZONES)


26.8


Project No. Drawing No. 별 22098A DA01

Drawings scaled to an A1 sheet 22098A DAr8.pln Last saved on 28/04/2023 by Mark **0** 

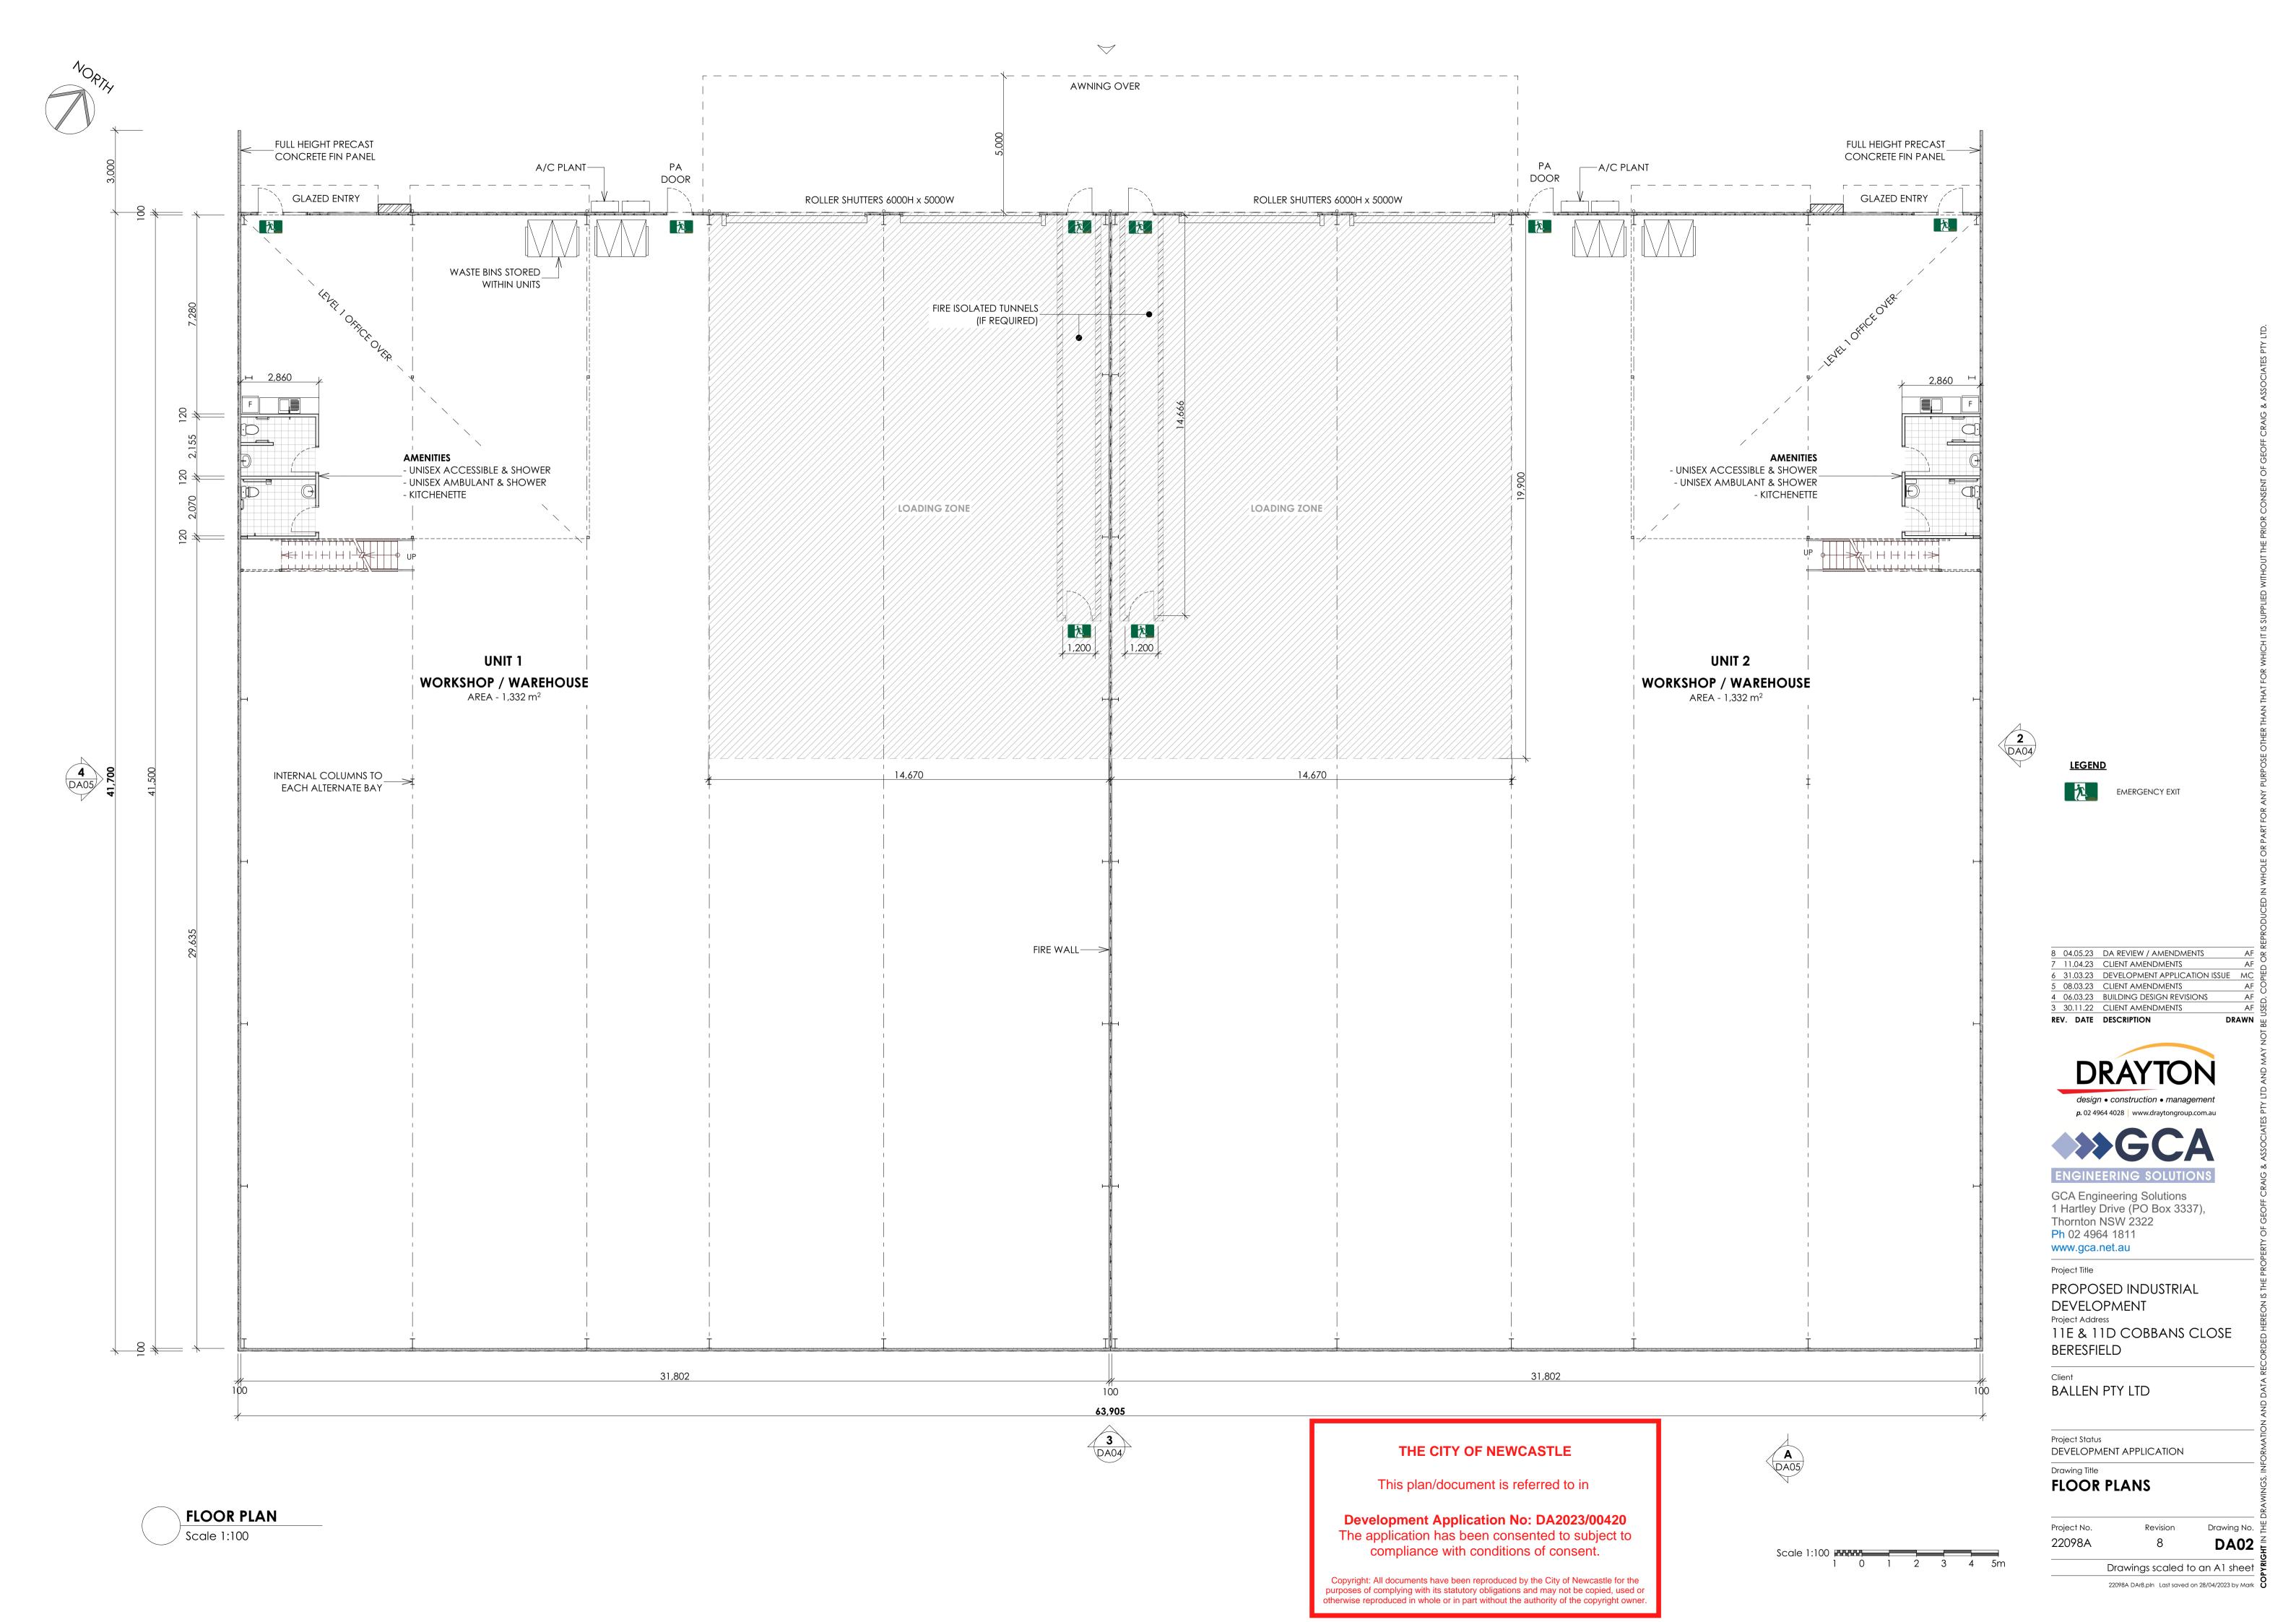



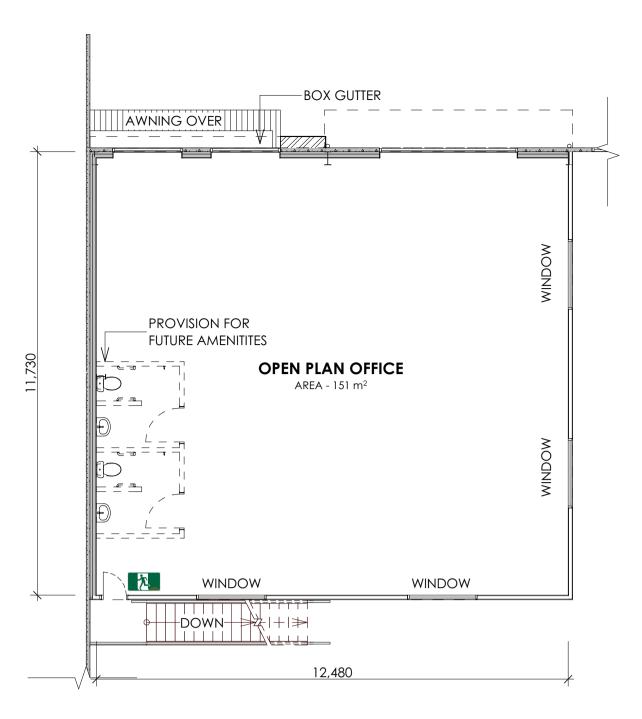

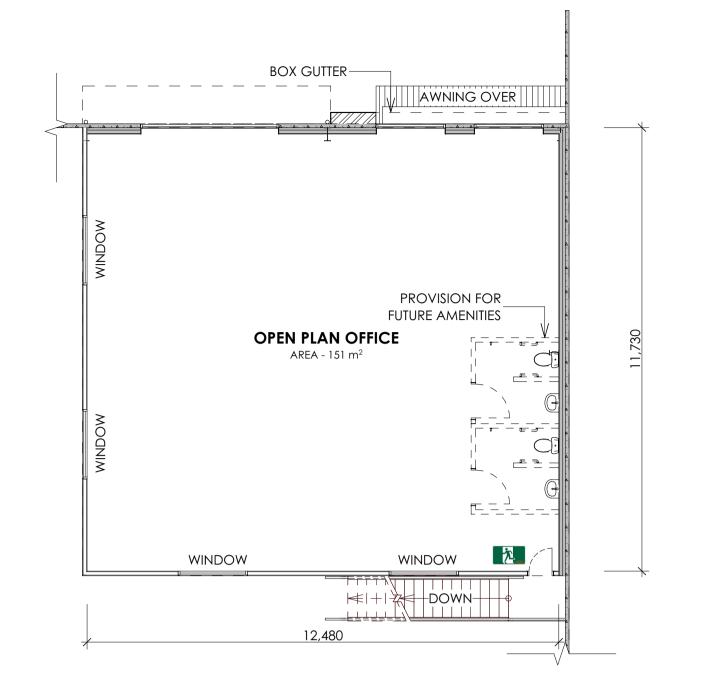


<u>LEGEND</u>

EMERGENCY EXIT

MEZZANINE FLOOR PLAN

Scale 1:100

MEZZANINE FLOOR PLAN Scale 1:100

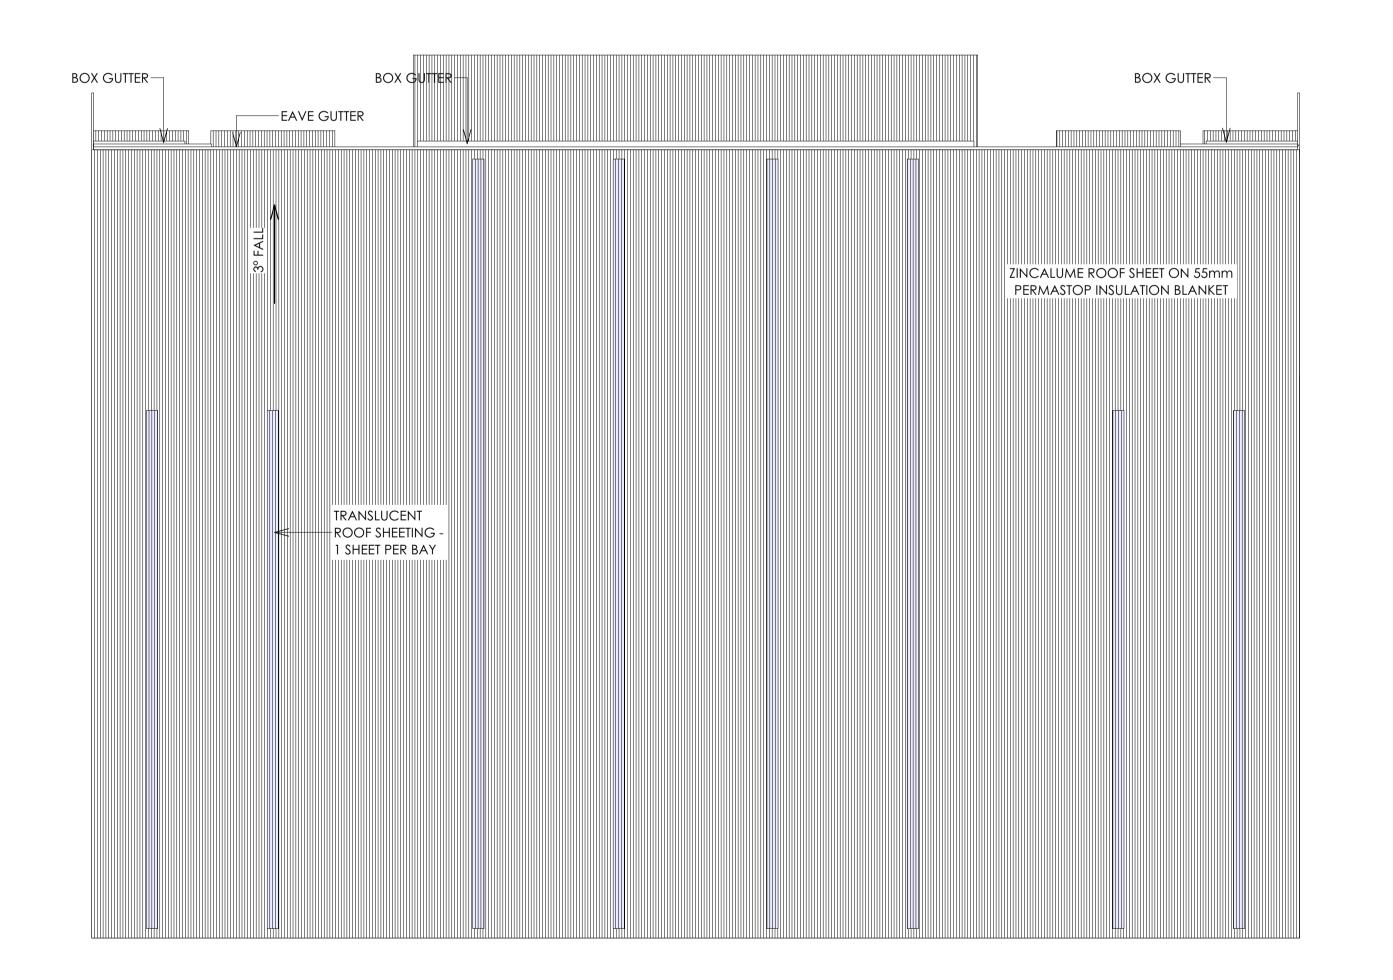

Scale 1:200 2 0 2 4 6 8 10m Scale 1:100 1 2 3 4 5m

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BALLEN PTY LTD

Project Status DEVELOPMENT APPLICATION

Drawing Title **MEZZANINE FLOOR & ROOF** 

PLAN Project No. Revision 22098A


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Drawing No. 별

**DA03** 


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# 1 NORTH ELEVATION

DA02 Scale 1:100

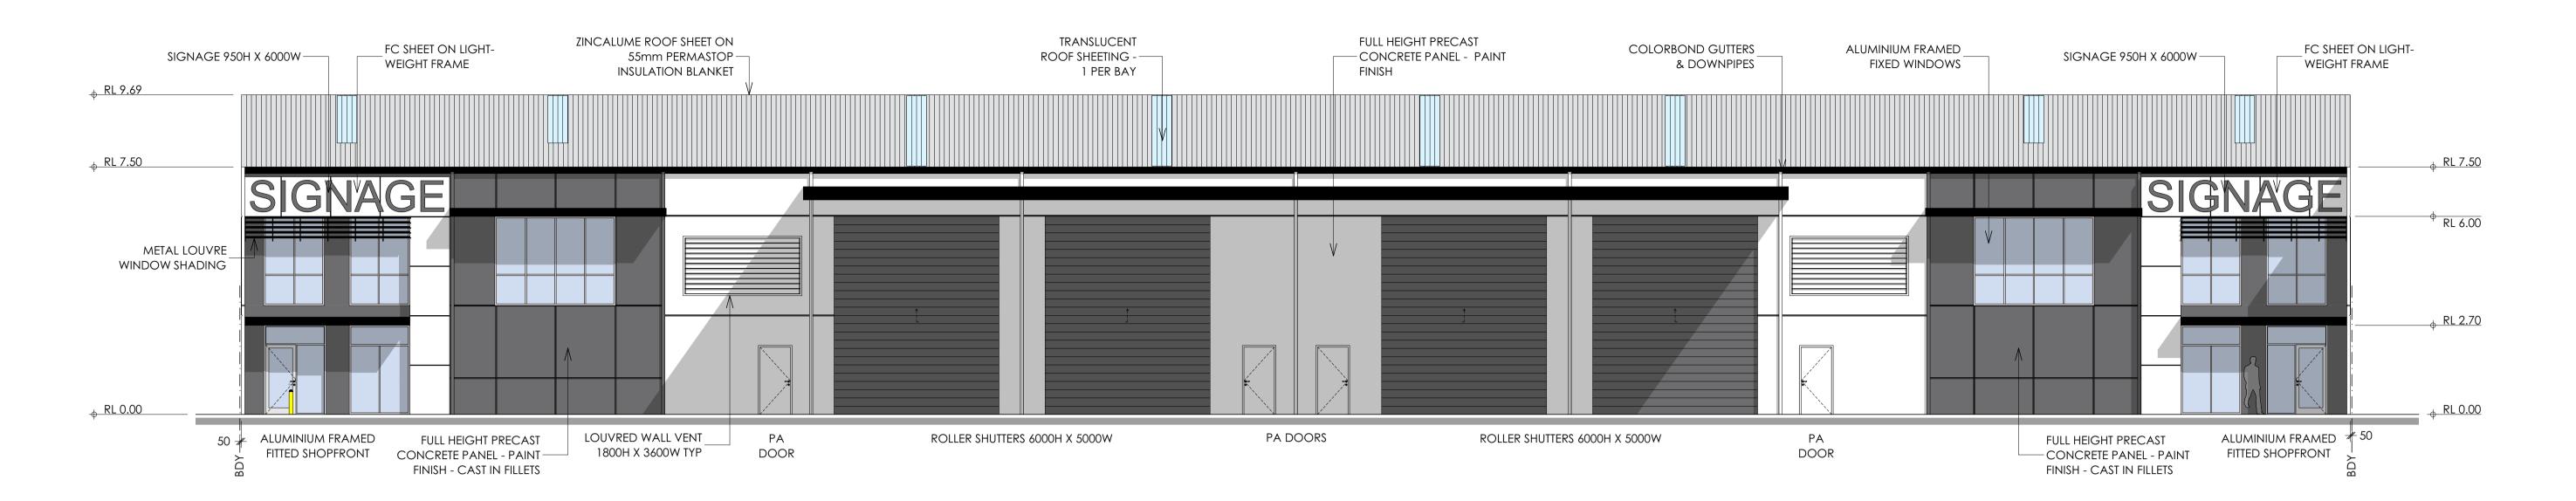


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Project Title

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DEVELOPMENT
Project Address
11E & 11D COBBANS CLOSE
BERESFIELD

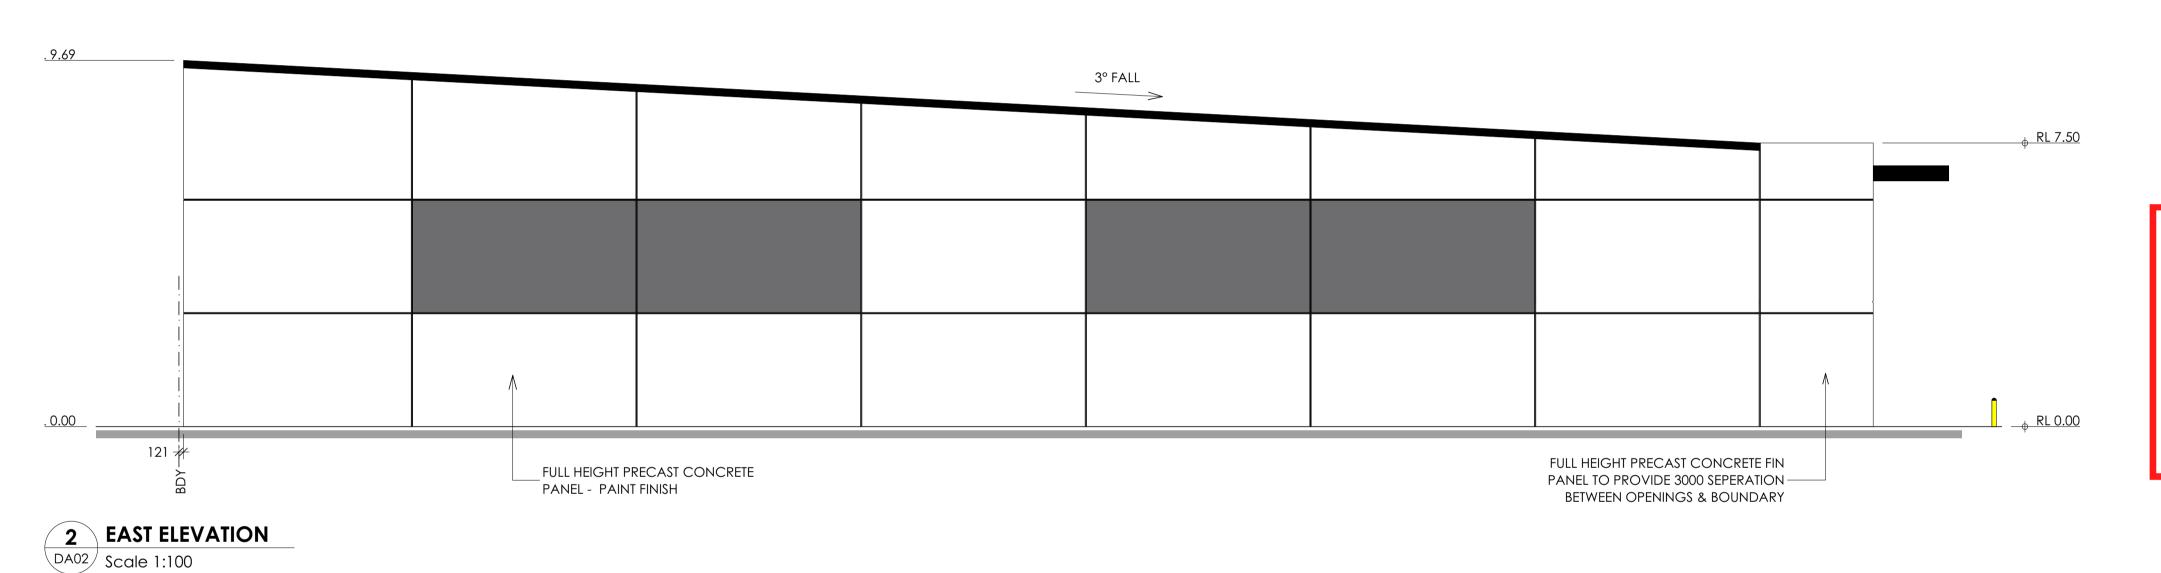Client
BALLEN PTY LTD

Project Status

DEVELOPMENT APPLICATION

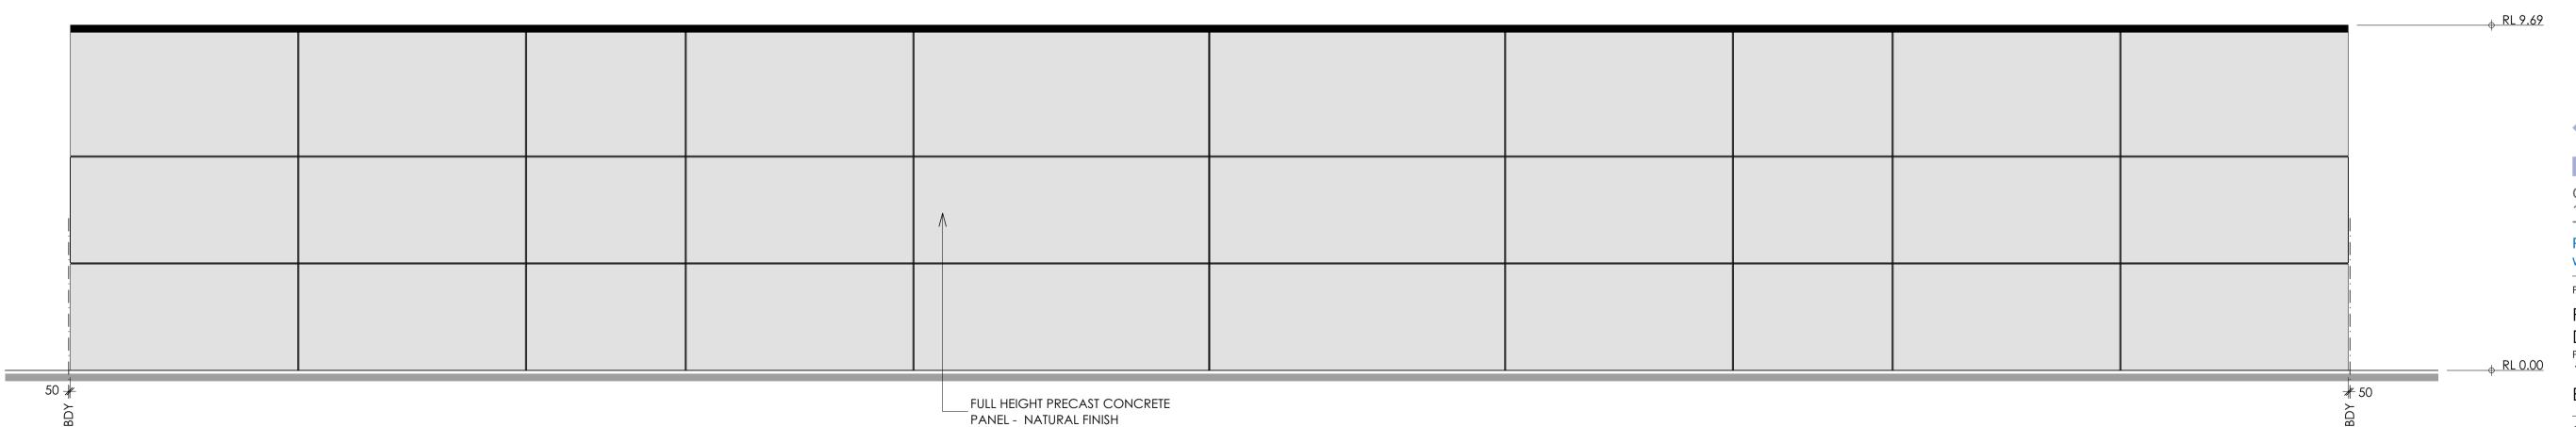Drawing Title **ELEVATIONS** 


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Drawings scaled to an A1 sheet

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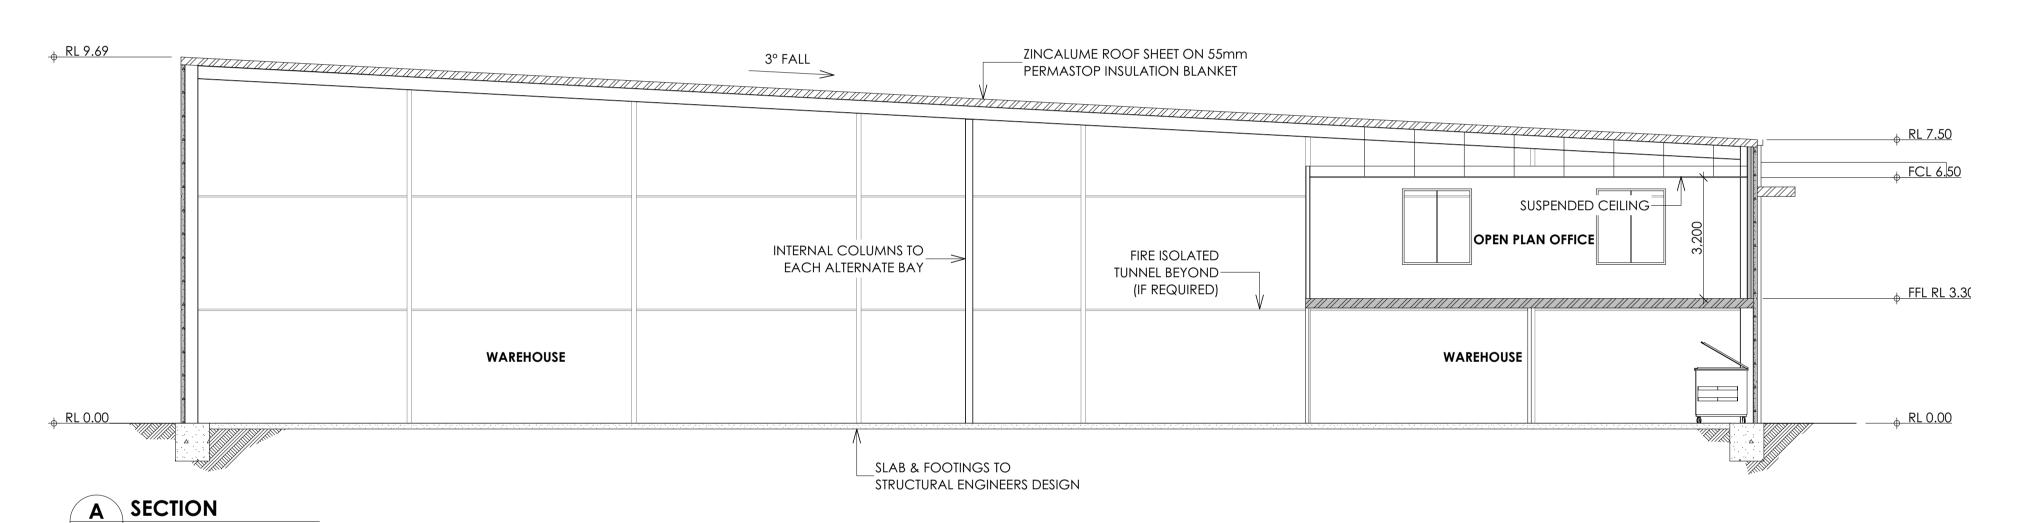
Scale 1:100 1 2 3 4 5m

3 SOUTH ELEVATION
DA02 Scale 1:100



WEST ELEVATION

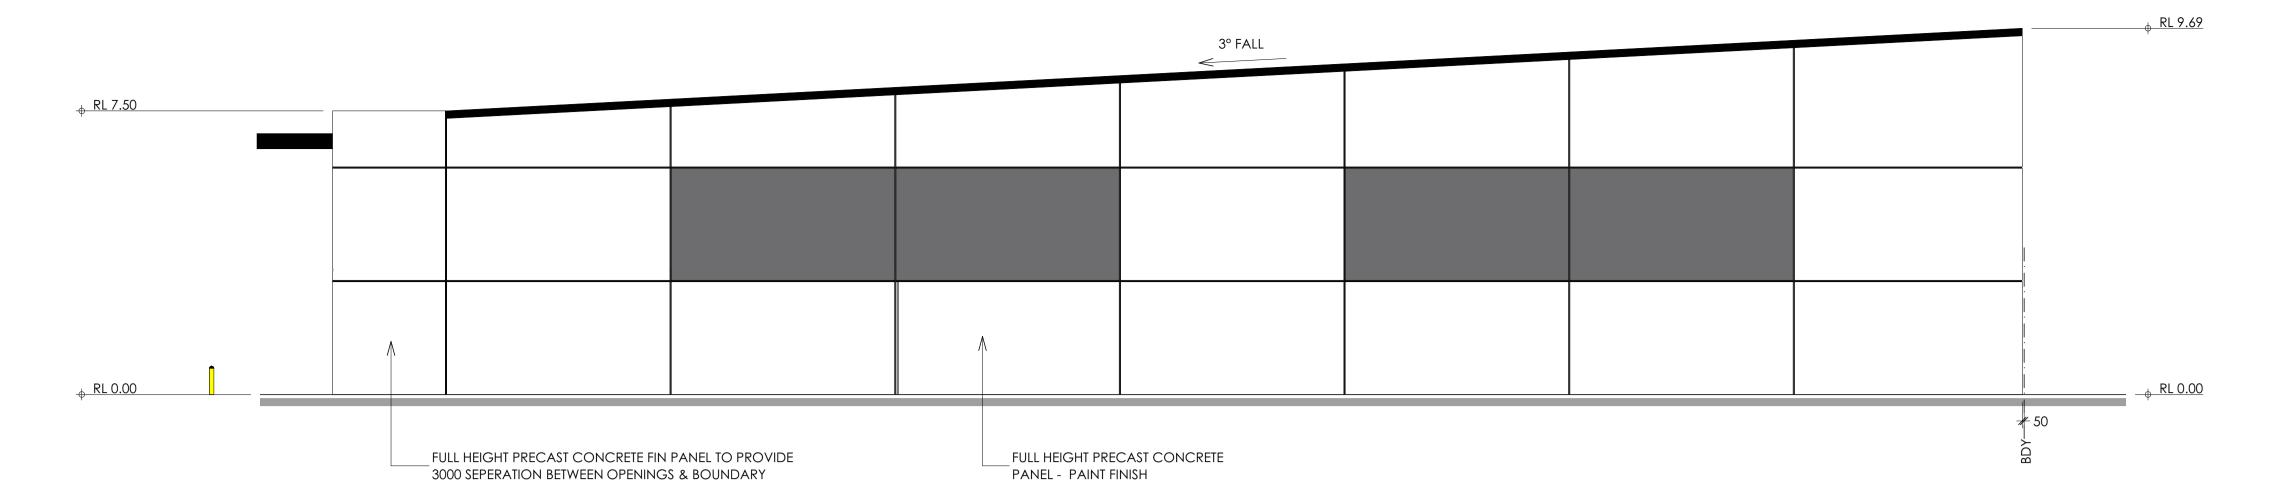DA02 Scale 1:100



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Drawing Title

1 0 1 2 3 4 5m

ELEVATION, SECTION & PERSPECTIVES


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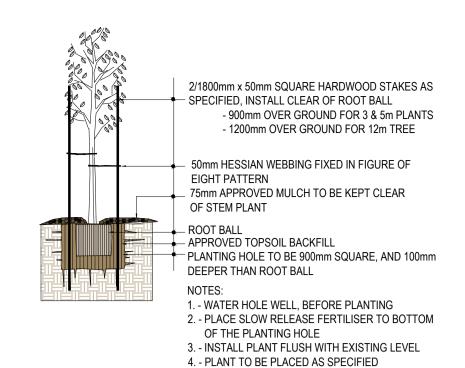
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LANDSCAPING PLAN

Scale 1:250






NOT TO SCALE

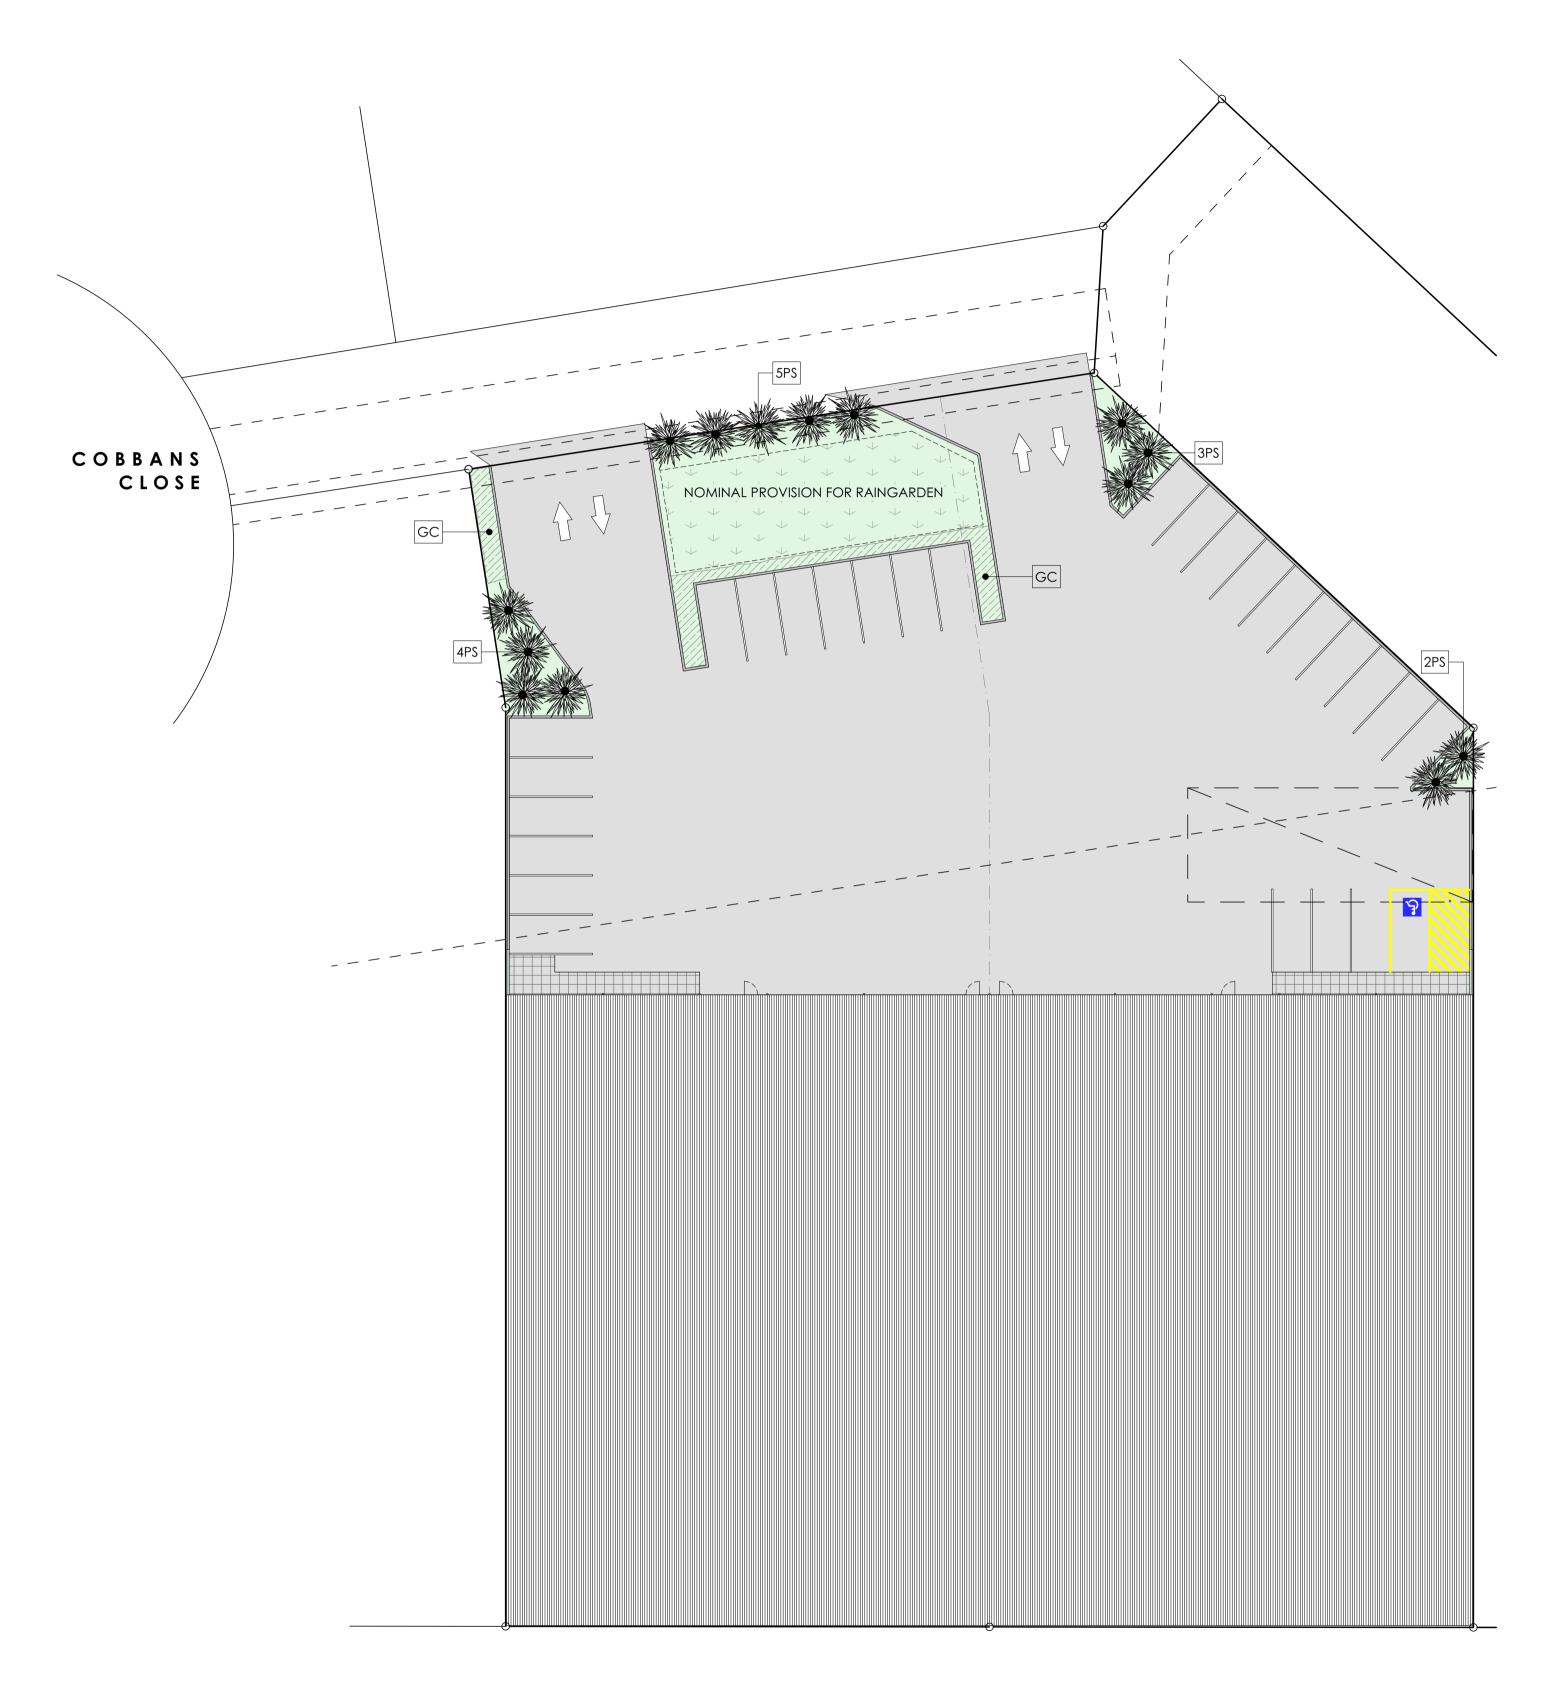STAKING & TYING PLANTS WITH GRATE

SPREAD MULCH TO A DEPTH OF 75mm REDUCE DEPTH AT BASE OF PLANT SOIL MIX A 300mm EXCAVATE TO 1000mm (min) BELOW FINISHED LEVELS SOIL MIX B BACKFILL AND CONSOLIDATE WITH TOPSOIL MIXTURE AND 700mm FERTILISER AS SPECIFIED. -CULTIVATE SUBGRADE TO 150mm

MASS PLANTING DETAIL NOT TO SCALE

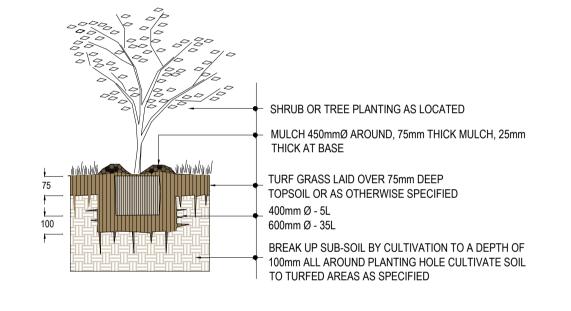

TYPICAL TREE OR SHRUB IN TURF

NOT TO SCALE

#### LANDSCAPING

- L1. ALL EXISTING TREES MARKED FOR RETENTION SHALL BE PROTECTED FOR THE DURATION OF BUILDING WORKS. REMOVE FROM SITE ALL PERENNIAL WEEDS SUCH AS OXALIS, ONION WEED AND THE LIKE.
- L2. NO REGRADING IS TO BE CARRIED OUT WITHIN THE DRIP LINE OF THE TREES TO BE RETAINED. WHERE EXCAVATION IS NECESSARY USE HAND METHODS TO AVOID DAMAGE TO THE ROOT SYSTEM. DO NOT CUT ROOTS GREATER THAN 50MM, CUT ROOTS CLEANLY WITH A SAW AND DO NOT SEAL THE WOUND.
- L3. DO NOT STORE, STOCKPILE, DUMP OR OTHERWISE REPLACE UNDER OR NEAR TREES, BULK MATERIALS AND HARMFUL MATERIALS INCLUDING OIL, PAINT, WASTE CONCRETE, CLEARINGS, BOULDERS AND THE LIKE. DO NOT PLACE SPOIL FROM EXCAVATIONS AGAINST TREE TRUCKS, EVEN FOR SHORT PERIODS. PREVENT WIND-BLOWN MATERIALS SUCH AS CEMENT FROM HARMING TREES & PLANTS.
- L4. PREVENT DAMAGE TO TREE BARK. DO NOT ATTACH STAYS, GUYS AND THE LIKE TO TREES.
- L5. DO NOT REMOVE TOPSOIL FROM WITHIN THE DRIP LINE OF TREES UNLESS OTHERWISE SPECIFIED. IF IT IS NECESSARY TO EXCAVATE WITH IN THE DRIP LINE USE HAND METHODS SUCH THAT ROOT SYSTEMS ARE PRESERVED, INTACT AND UNDAMAGED.
- L6. AVOID COMPACTION OF THE GROUND UNDER TREES. IF THE GROUND UNDER TREES HAS BEEN UNDULY COMPACTED DURING THE WORK. LOOSEN THE SOIL BY CORING.
- DO NOT CUT TREE ROOTS EXCEEDING 50MM DIAMETER UNLESS PERMITTED BY THE SUPERINTENDENT. WHERE IT IS NECESSARY TO CUT TREE ROOTS, USE A CHAINSAW OR SIMILAR MEANS SUCH THAT THE CUTTING DOES NOT UNDULY DISTURB OR ROCK THE REMAINING ROOT SYSTEMS. IMMEDIATELY AFTER CUTTING, APPLY AN APPROVED BITUMINOUS FUNGICIDAL SEALANT TO THE CUT SURFACE TO PREVENT THE INCURSION OF ROT OR DISEASE.
- L8. THOROUGHLY CULTIVATE THE SUBSOIL TO THE DEPTHS SPECIFIED.
- L9. TREE PLANTING AREAS TO BE MOUNDED 300MM ABOVE EXISTING GROUND LINE TO IMPROVE DRAINAGE FROM PLANTING HOLES. TREE HOLES TO BE EXCAVATED 2 TIMES LARGER THAN THE ROOTBALL AND BACKFILLED.
- L10. SUPPLY AND PLACE 75MM LAYER OF HARDWOOD HORTICULTURAL GRADE MULCH (GRADED IN SIZE 15MM x 15MM x 15MM. FREE FROM WOOD SLIVERS.) SET DOWN 25MM FROM ADJACENT PAVING.
- L11. APPLY SHIRLEYS NO17 LAWN FERTILISER OR SIMILAR TO SOIL. APPLIED IN ACCORDANCE WITH THE MANUFACTURERS INSTRUCTIONS.
- L12. ALL PLANTS SHALL BE TRUE TO TYPE OF HEALTHY GROWTH DISEASE FREE NURSERY STOCK AND NOT DISPLAYING RESTRICTED GROWTH PATTERNS. SHOULD THERE BE A REQUIREMENT FOR SUBSTITUTIONS THEY SHALL NOT BE CHANGED WITHOUT PRIOR APPROVAL. NO VARIEGATED STRAIN SHALL BE USED. ALLOW FOR SLOW RELEASE FERTILISER TO ALL PLANTINGS APPLIED AT THE MANUFACTURES RECOMMENDED RATE TO BE SAME OR SIMILAR TO OSMOCOTE.

**PLANT SCHEDULE MATURE SIZE** QUANTITY POT SIZE **TYPE** COMMON NAME SYMBOL BOTANICAL NAME HEIGHT (m) SPREAD (m) **SHRUBS** PURPLE FOUNTAIN GRASS Pennisetum setaceum 200mm GROUND COVERS NATIVE SARSAPARILLA 0.5 Hardenbergia violacea MASS PLANTING -Dianella hybrid SILVER STREAK 0.6 SELECT FROM: 0.5 1 PLANT TUBE Lomandra confertifolia DWARF MAT RUSH PER m<sup>2</sup> STOCK Dianella caerulea BLUE FLAX LILY Lomandra longifolia SPINY-HEAD MAT-RUSH 1.5 Isolepis nodosa KNOBBY CLUB RUSH

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2 0 4 8 12 16 20m





GC

PURPLE FOUNTAIN GRASS

GROUND COVER MASS

PLANTING



Project Status

Drawing Title

Project No. Drawing No. รู้ Revision 22098A **DA07** 

8 04.05.23 DA REVIEW / AMENDMENTS 7 11.04.23 CLIENT AMENDMENTS

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DRAWN

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#### GENERAL

- G1. ALL EXISTING UNDERGROUND SERVICES MUST BE LOCATED AND EXPOSED PRIOR TO EARTHWORKS COMMENCING AND IT IS THE RESPONSIBILITY OF THOSE PERSONS USING THIS PLAN TO CONFIRM BOTH POSITION & LEVEL OF THESE UTILITIES IN CONJUNCTION WITH THE APPROPRIATE AUTHORITY.
- G2. THE BUILDER SHALL CHECK AND VERIFY ALL DIMENSIONS AND VERIFY ALL ERRORS AND OMISSIONS TO THE DESIGNER. DO NOT SCALE THE DRAWINGS. DRAWINGS SHALL NOT BE USED FOR CONSTRUCTION PURPOSES UNTIL ISSUED BY THE DESIGNER FOR CONSTRUCTION.
- G3. WRITTEN DIMENSIONS TO TAKE PRECEDENCE OVER SCALED MEASUREMENTS. IF IN DOUBT REFER TO DESIGNER.
- G4. EMERGENCY LIGHTING & EXIT / EXIT DIRECTION SIGNAGE TO BE INSTALLED TO ALL EGRESS PATHS & INTERNAL STAIRWAYS IN ACCORDANCE WITH AS2293.1-2018 & BCA CLAUSES E4.2, E4.4, E4.5, E4.6 & E4.8.
- G5. AMENITIES TO BE MECHANICALLY VENTILATED.
- G6. ALL GLAZED ASSEMBLIES TO COMPLY WITH AS1288-2006 AND AS2047-2014 (AS APPLICABLE).
- G7. ALL NEW FLOOR LININGS, FLOOR COVERINGS, WALL LININGS & CEILING LININGS TO COMPLY WITH BCA CLAUSE C1.10.
- G8. EXIT TRAVEL DISTANCES TO BE IN ACCORDANCE WITH BCA CLAUSE D1.4.
- G9. THE MINIMIUM UNOBSTRUCTED HEIGHT OF ANY REQUIRED EXIT OR PATH OF TRAVEL TO BE 2000mm THROUGHOUT EXCEPT DOORWAYS (MIN 1980mm) IN ACCORDANCE WITH BCA PART D1.6
- G10. WHERE APPLICABLE TACTILE INDICATORS TO BE PROVIDED TO INTERNAL STAIRWAYS (TOP & BOTTOM LANDINGS).
- G11. WHERE APPLICABLE LIFTS TO COMPLY WITH CLAUSES 3.1, 3.3, TABLES E3.6a & E3.6b OF THE BCA AND AS 1735.12. MINIMUM DIMENSIONS 1100mm WIDE x 1400mm DEEP WITH 900mm CLEAR OPENING.
- G12. WET AREAS TO BE WATERPROOFED IN ACCORDANCE WITH BCA TABLE F1.7 & AS3740-2010.
- G13. WINDOWS & EXTERNAL SLIDING FRAMED GLAZED DOORS TO COMPLY WITH AS2047-2014.
- G14. ARTIFICIAL LIGHTING TO BE PROVIDED IN ACCORDANCE WITH BCA PART F4.4 & TO COMPLY WITH AS/NZS1680.0-2009
- G15. MECHANICAL VENTILATION TO COMPLY WITH AS1668.2-2012.
- G16. WHERE APPLICABLE ALL BALUSTRADES TO MEZZANINE FLOOR & STAIRWAYS TO COMPLY WITH BCA CLAUSES D2.16-D2.18, AS1170.1, AS1657 & AS1428.1.
- G17. STAIRWAYS TO COMPLY WITH BCA CLAUSE D2.13, TABLE D2.13, CLAUSE D2.14 AND TABLE D2.14
- G18 DOORS IN A REQUIRED EXIT, FORMING PART OF A REQUIRED EXIT OR IN THE PATH OF A REQUIRED EXIT TO COMPLY WITH BCA CLAUSE D2.21 OPERATION OF LATCH
- G19. DAMP-PROOFING TO BE IN ACCORDANCE WITH AS2904 DAMP-PROOF COURSES AND FLASHINGS OR AS3660.1 TERMITE MANAGEMENT - NEW BUILDING WORK.
- G20 CAR PARKING & DRIVEWAY LAYOUT TO COMPLY WITH AS2890.1-2004.
- G21. CONSTRUCTION OF SANITARY COMPARTMENTS TO COMPLY WITH BCA CLAUSE F2.5.
- G22. OUTDOOR LIGHTING TO COMPLY WITH AS 4282-1997
- G23. TERMITE RISK MANAGEMENT SYSTEM TO BE PLACED IN ACCORDANCE WITH BCA CLAUSE BI.4 & AS 3660.1
- G24. PORTABLE FIRE EXTINGUISHERS ARE TO BE PROVIDED IN ACCORDANCE WITH BCA CLAUSE E1.6

#### **ENERGY EFFICIENCY**

- E1. THERMAL CONSTRUCTION TO AIR CONDITIONED SPACE INSULATION MUST BE INSTALLED IN ACCORDANCE WITH BCA CLAUSE 1.2 & COMPLY WITH AS4859.1.
- E2. ROOF & CEILING TO ACHIEVE THE MINIMUM TOTAL "R" VALUE OUTLINED IN TABLE BCA J1.3. CONSTRUCTION OF ROOF TO COMPLY WITH BCA CLAUSE J3.6 (TYPICALLY R3.2) – REFER DETAILS.
- E3. GLAZING TO COMPLY WITH BCA CLAUSE J2.3 & J2.4. REFER GLAZING CALCULATED DATA SHEET (AIR CONDITIONED SPACE ONLY) & AS1288-2006.
- E4. EXTERNAL DOORS TO AIR CONDITIONED SPACE BE SELF CLOSING & SEALED IN ACCORDANCE WITH BCA CLAUSE J3.4.
- E5. AIR CONDITIONING TO COMPLY WITH BCA PART J5.
- E6. NATURAL LIGHTING TO COMPLY WITH BCA CLAUSES F4.2, 4.3 & 4.4.
- ARTIFICIAL INTERIOR LIGHTING TO COMPLY WITH AS 1680 & BCA CLAUSES J6.2-
- E8. ARTIFICIAL EXTERIOR LIGHTING TO COMPLY WITH BCA CLAUSE J6.5.
- E9. VENTILATION TO COMPLY WITH BCA CLAUSES J4.5-4.7.
- E10. HOT WATER SYSTEM TO BE INSTALLED IN ACCORDANCE WITH SECTION 8 AS3500.4 & BCA PART J7.
- E11. EXTERNAL WALLS TO ACHIEVE MINIMUM TOTAL "R" VALUE OUTLINED IN TABLE BCA J1.5b - REFER DETAILS.

#### **ACCESSIBILITY**

- A1. DISABLED ACCESS TO BE PROVIDED IN ACCORDANCE WITH BCA PART D3 & AS1428.1.
- A2. STAIRWAYS TO COMPLY WITH A\$1428.1 INCLUDING COMPLIANT RISERS, CONTRASTING NOSE STRIP & TACTILE INDICATORS AT TOP & BOTTOM
- DOORWAYS TO HAVE MINIMUM CLEAR WIDTH OF 850mm (MINIMUM 920 LEAF A3. DOOR).
- A4. DOOR HANDLES TO BE:
  - D-TYPE LEVER HANDLES LOCATED BETWEEN 900-1100mm HEIGHT. CLEARANCE BETWEEN GRIP AND DOOR FACE TO BE 35-45mm IN
  - ACCORDANCE WITH BCA PART D2.22 - OPENABLE FROM THE SIDE FACING A PERSON SEEKING EGRESS WITHOUT A KEY
- A5. MINIMUM CLEAR WIDTH OF ACCESS WAYS TO BE 1000mm.
- A6. DOORWAYS INTO & WITHIN THE BUILDING TO HAVE MINIMUM LUMINANCE CONTRAST OF 30% PROVIDED BETWEEN DOOR & JAMB/WALL - MINIMUM WIDTH 50mm IN ACCORDANCE WITH AS1428.1 CLAUSE 13.1.
- A7. FLOOR & GROUND SURFACES TO COMPLY WITH AS1428.1 CLAUSE 7.
- A8. CARPET AS1428.1 DOES NOT APPLY. CARPET PILE/BACKING THICKNESS AND HEIGHT TO BE IN ACCORDANCE WITH BCA PART D3.3 (g) & (h).
- A9. TACTILE INDICATORS TO BE PROVIDED & INSTALLED IN ACCORDANCE WITH AS1428.4.
- A10 ALL GLAZING ON ACCESSWAYS TO BE CLEARLY MARKED WITH A MIN 75mm WIDE VISION STRIP IN ACCORDANCE WITH BCA PART D3.12 & AS1428.1 CLAUSE 6.6
- A11. DISABLED TOILET TO BE CONSTRUCTED IN ACCORDANCE WITH AS1428.1.

FIXTURES TO WC	
<u>GRAB RAILS</u>	
DIAMETER	Ø30-40mn
HEIGHT	800-810mn
HAND BASIN	LIP 770-800mn
TOILET ROLL HOLDER	700mm MAX
MIRROR	900-1850mn
SOAP DISPENSER	1000-1100mn
SHOWER	
BASE OF ADJUSTMENT	1000-1100mn
TOP	1880-1900mn
FLUSH CONTROL	1100 MAX
DOOR LOCK	ONE HAND UNLOCI
	900-1100mn
DOOR SWING	OUTWARD/SLIDE
FLOOR SURFACE	SLIP RESISTAN
GRADIENT	
SHOWER	1:50-1:60
CIRC. AREA	1:70-1:80
ELECTRICAL OUTLET	900-1100mn
HEIGHT	
SIGN	DISABLED BRAILLE AS PEI
	AS1428.1 14.4/
LUMINANCE CONTRAST	MIN DIFFERENTIAL 309
	AS PER AS1428.1 CLAUS
	15.2.3
FINISHED FLOOR	MAX 3mm AS PEI
DIFFERENTIAL SURFACES	AS1428.1 Section
TACTILE INDICATORS	AS PER BCA PART D3.
CIRCULATION SPACE	2300 x 1900mm M II

MIN 2,400 MIN 2,400

- ACCORDANCE WITH

AS2890.6 SECTION 3.2

- BOLLARD

SYMBOL IN ACCORDANCE WITH

AS2890.6 SECTION 3.1

DEDICATED


PARKING SPACE

1,200 MAX

SHARED ZONE

Scale 1:100


TYPICAL ACCESSIBLE CARPARK

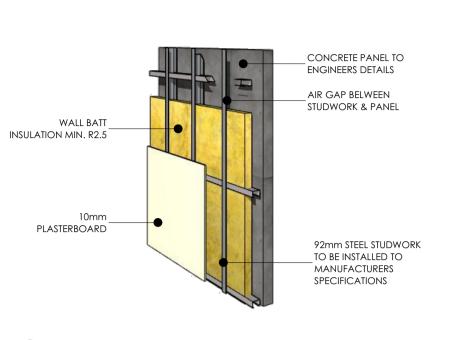


#### TYPICAL WARNING INDICATOR PATTERNS.

TACTILE GROUND SURFACE INDICATORS TO COMPLY, AND BE PLACED, IN ACCORDANCE WITH AS1428.4 'DESIGN FOR ACCESS AND MOBILITY PART 4: TACTILE INDICATORS'.

REFER PLANS FOR INDICATIVE LOCATIONS

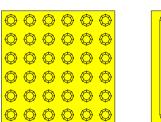


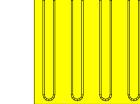


TYPICAL TACTILE INDICATOR Scale 1:10

TYPICAL EXTERNAL WALL (AIR CONDITIONED SPACE) PRECAST CONCRETE PANEL WALL

- REFER NOTES PAGE - 'ENERGY EFFICIENCY'

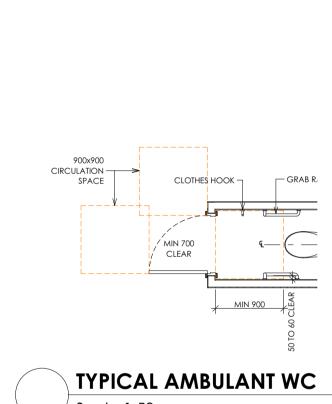

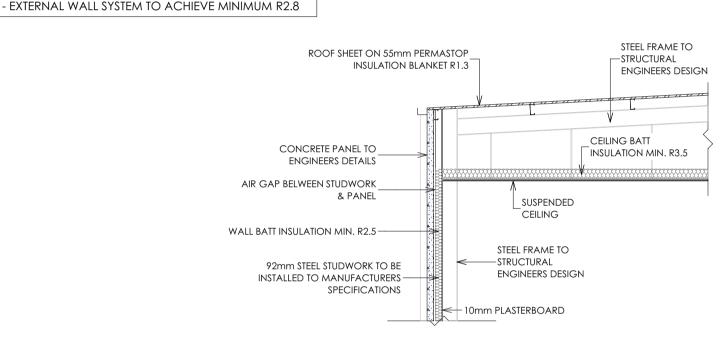

TYPICAL ROOF SECTION (AIR CONDITIONED SPACE)

Scale 1:50


CIRCULATION + CLOTHES HOOK —


> PLANS OF TYPICAL AMENITIES SHOWING MINIMUM CIRCULATION SPACE, OFFSETS & REQUIRED CLEARANCES. REFER FLOOR PLANS FOR PROJECT AMENITIES DIMENSIONS AND LAYOUT.

PAN CIRCULATION (L) MIN 1,900

TYPICAL ACCESSIBLE WC Scale 1:50

PAN CIRCULATION

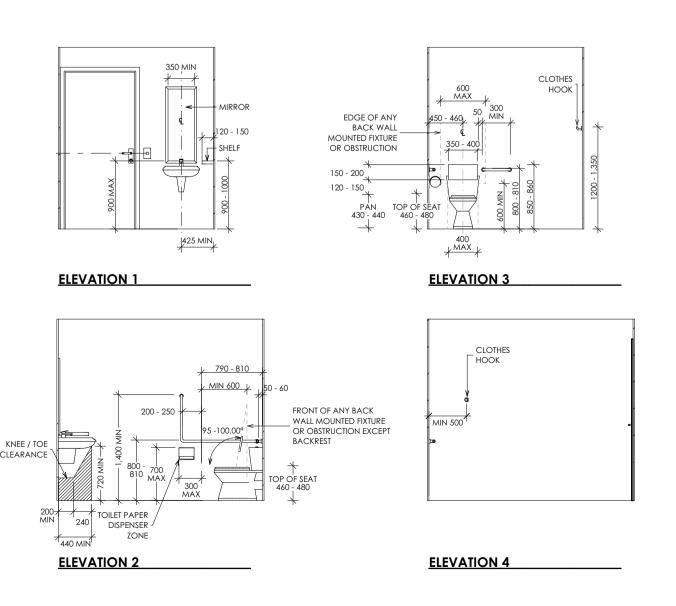

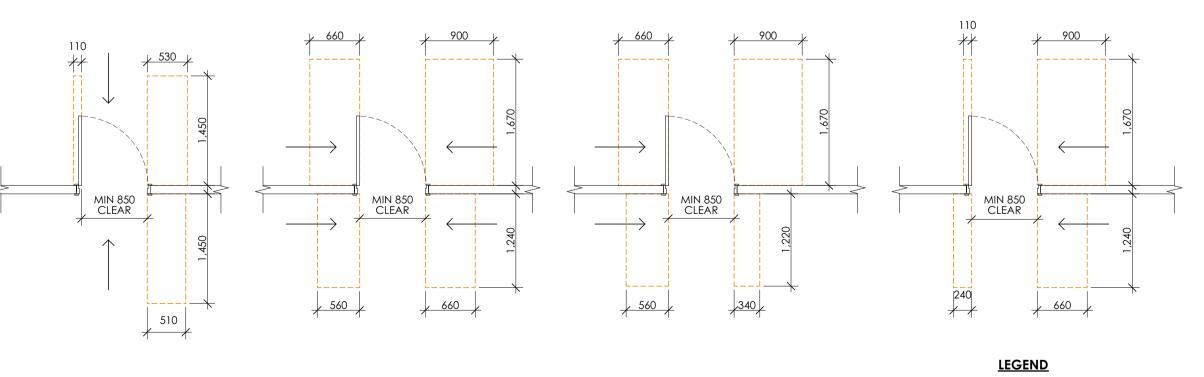





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**NOTES & DETAILS** 

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Drawing No.

**DA08**