

11 September 2025

Xcommercial

Level 3, 17 Randle Street, Surry Hills NSW 2010

Justin Ross

justin@xcommercial.com.au

Dear Justin,

Re: NABERS exemption of Educational Facility - 29-37 Bellevue Street, Surry Hills

Credwell has been engaged to provide a supporting NABERS energy office rating exemption statement for the above-mentioned address.

This building had strictly operated as Class 9(b) under the BCA since the *change of use* as per DA notice of determination for application number U00-00272, determined 13th June 2000. Refer to *Annexure – DA notice of determination*.

This proposed development, which is an educational establishment class 9(b) is considered an educational building, and as per the *NABERS Rules - Energy and Water for Offices v5.2* section 3.2.1, is not considered as an educational office facility. The attached drawings in *Annexure – Floorplans* detail building contains classrooms and lecture theaters and therefore the building is not assessable for a NABERS energy for offices rating.

Credwell have conducted a site visit to verify these floor plans and the operational Class 9(b) use case of the building.

If you have any queries, please feel free to contact the undersigned.

Regards,

Padraig Healy
Director | NABERS | GSAP | NATHERS
Credwell Energy Pty Ltd

Pariksheth Elete

Senior ESD Consultant | NABERS | GSAP Credwell Energy Pty Ltd

ANNEXURE – DA NOTICE OF DETERMINATION

13/06 '00 15:58 FAX 81 2 92585992

SSCC P&B DEPT

2001

Snem Paul Canterbury Business College Pty Ltd PO Box 220 Bankstown NSW 1885

> Notice of Determination of a Development Application

issued under the Environmental Planning and Assessment Act 1979 Section 81 (1) (a)

Ref: U00-00272/AOW/FLW/104676

Development Application Number

Development Application

Applicant name

Applicant address

Address of land to be Developed

Proposed development

Building Code of Australia building classification

Determination Date

Determination

Details of conditions or reasons for refusal U00-00272

Canterbury Business College Pty Ltd

PO Box 220, Bankstown

29-35 Bellevue Street, Surry Hills

Change of use to educational establishment

Class 9(b)

1 3 JUN 2000

Consent granted subject to conditions

See attached schedule

Note: (1) If approved, this consent becomes effective from the date of this notice to you.

This consent will lapse 5 years after the date of the effective consent date, unless a specific condition of the consent stipulates a lesser period or the consent is subject to a "deferred commencement" consent.



SSCC PAB DEPT

2002

Other approvals list Local Government Act 1993 approvals granted under s78A (5)

general terms of other approvals integrated as part of the consent (list approvals)

Right of appeal

Nil

NH

If you are dissatisfied with this decision section 97 of the Environmental Planning and Assessment Act 1979 gives you the right to appeal to the Land and Environment Court within 12 months after the date on which you receive this notice

Section 97 of the Environmental Planning and Assessment Act 1979 does not apply to the determination of a development application for State significant development or local designated development that has been the subject of a Commission of Inquiry

For any further information regarding this matter, please contact Ms Aolfe Wynter, on 9288 5267.

Signed

on behalf of South Sydney City Council


16

Nancy Godfrey Area Planning Manager



ANNEXURE - FLOOR PLANS




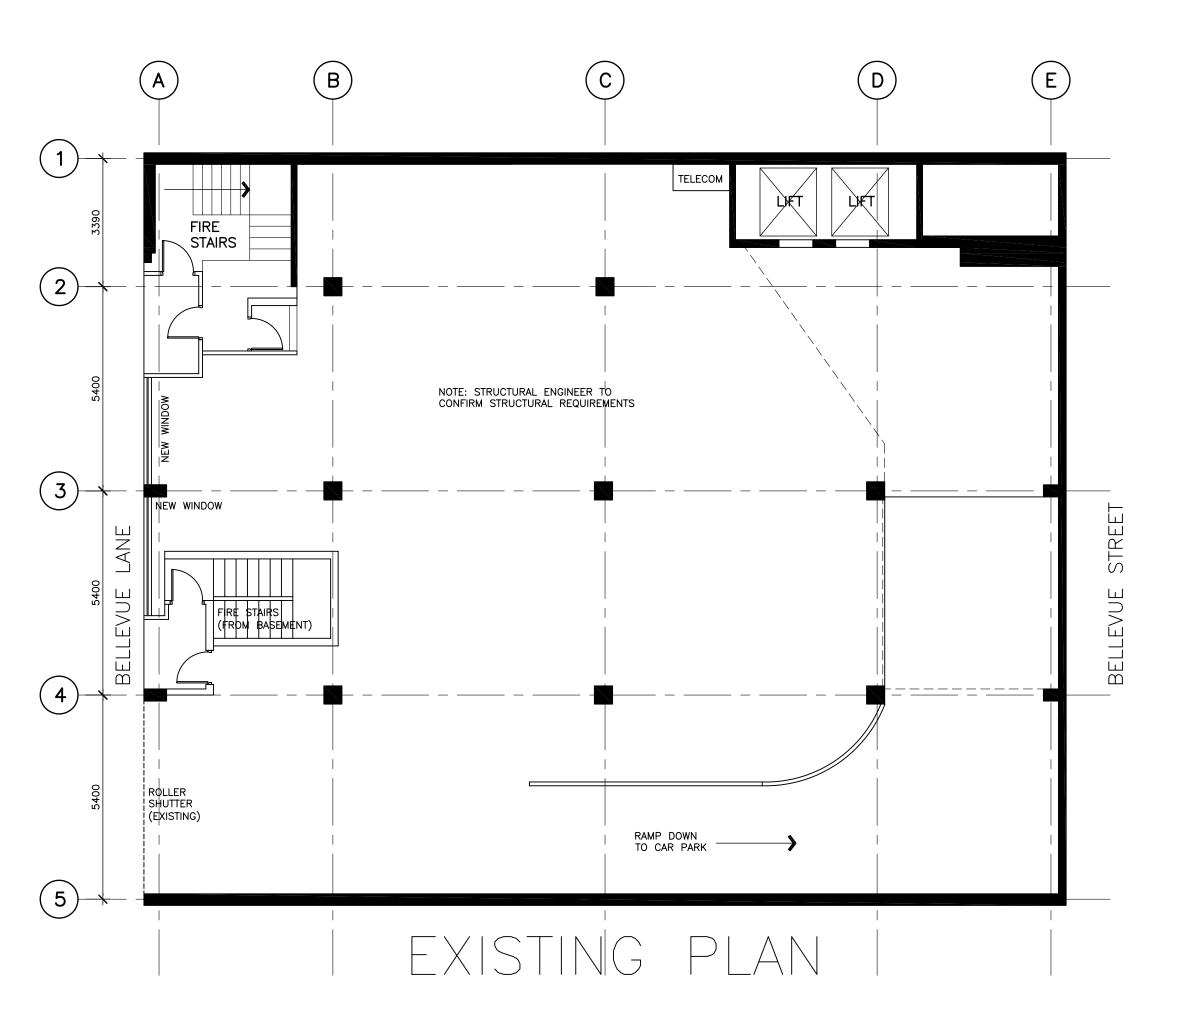

PLASTERBOARD PARTITIONS,
FULL HEIGHT TO CEILING

FULL HEIGHT GLAZING

----- EXISTING A/C DUCTWORK, TO
----- BE EXTENDED ACCORDING TO
MECH. ENGR. DETAILS.

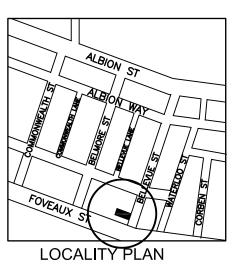

Notes: Use figured dimensions in preference to scale. All dimensions to be verified and checked on site.

ROSALIND FREEMAN "PARKVIEW" 2/1B INNES ROAD GREENWICH, NSW, 2065 PHONE: (02) 9390 7441

Project

UNIVERSITY OF SOUTHERN QUEENSLAND

Address

LEVEL 3, 29-37 BELLEVUE STREET SURRY HILLS

Drawing Title

BASEMENT 1 EXISTING FLOOR PLAN


Scale:

1:100

Date: AUGUST, 2006

Drawn By: ROS



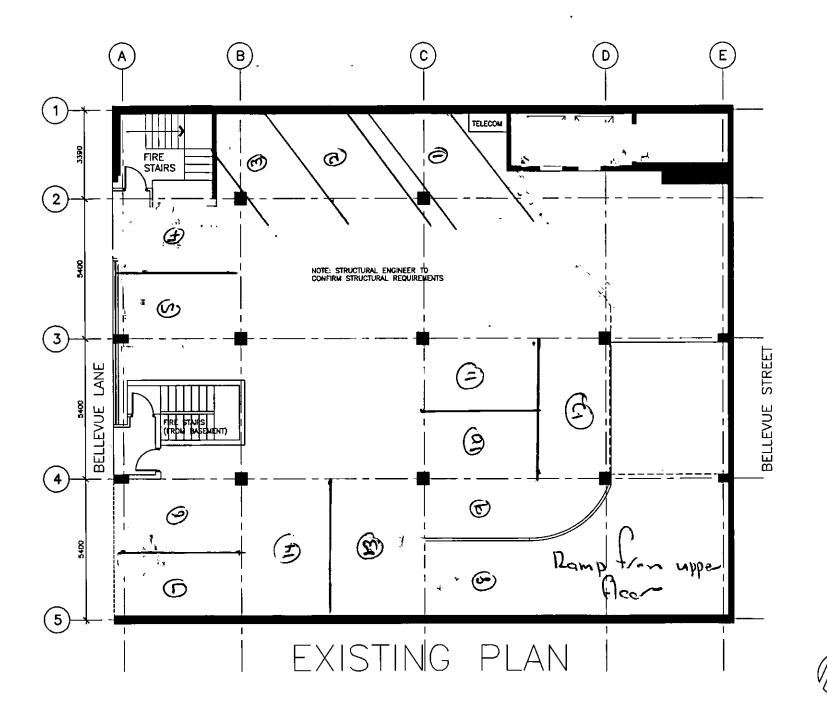




PLASTERBOARD PARTITIONS, FULL HEIGHT TO CEILING

- FULL HEIGHT GLAZING

- EXISTING A/C DUCTWORK, TO BE EXTENDED ACCORDING TO MECH, ENGR. DETAILS.

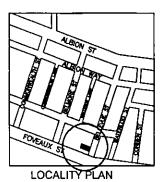

ROSALIND FREEMAN
"PARKVIEW"
2/1B INNES ROAD
GREENWICH, NSW, 2065
PHONE: (02) 9390 7441

UNIVERSITY OF SOUTHERN QUEENSLAND

Address

LEVEL 3, 29-37 BELLEVUE STREET SURRY HILLS


Drawing Title

BASEMENT 1 EXISTING FLOOR PLAN

1:100


AUGUST, 2006

RO\$

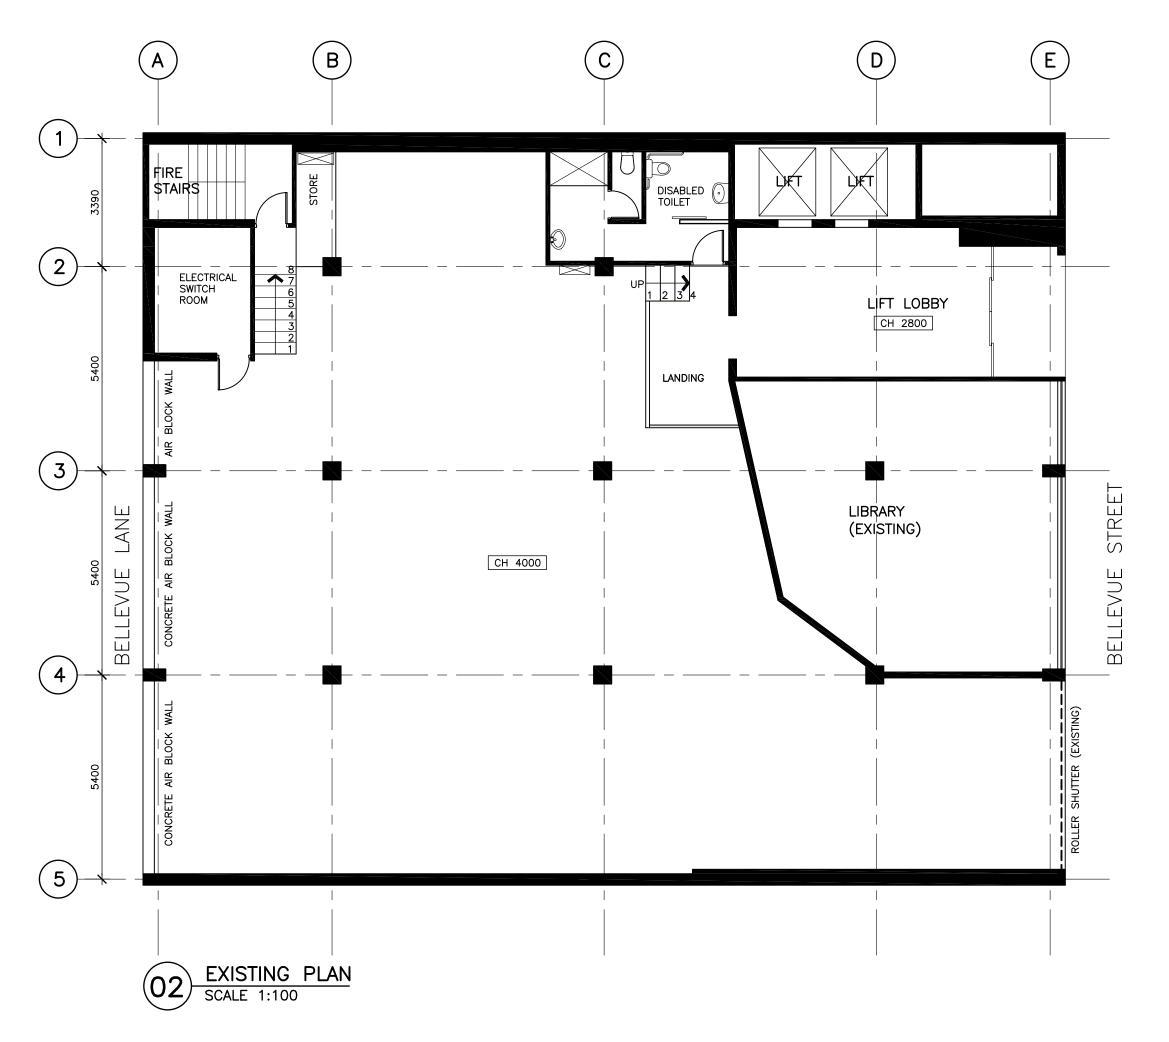

X 7300 SURVEY

CH 4000 CEILING HEIGHT

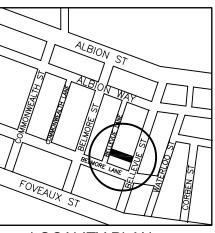

LOCALITY PLAN

Notes: Use figured dimensions in preference to scale. All dimensions to be verified and checked on site.

ROSALIND FREEMAN 31 WARK AVENUE PAGEWOOD NEW 2035

PHONE: (02) 9390 7441

Project

CANTERBURY POLYTECHNIC INSTITUTE

Address

29-37 BELLEVUE STREET SURRY HILLS

Drawing Title


GROUND LEVEL EXISTING FLOOR PLAN

Scale: 1:100 @ A3

Date: AUGUST, 2006

Drawn By: ROS




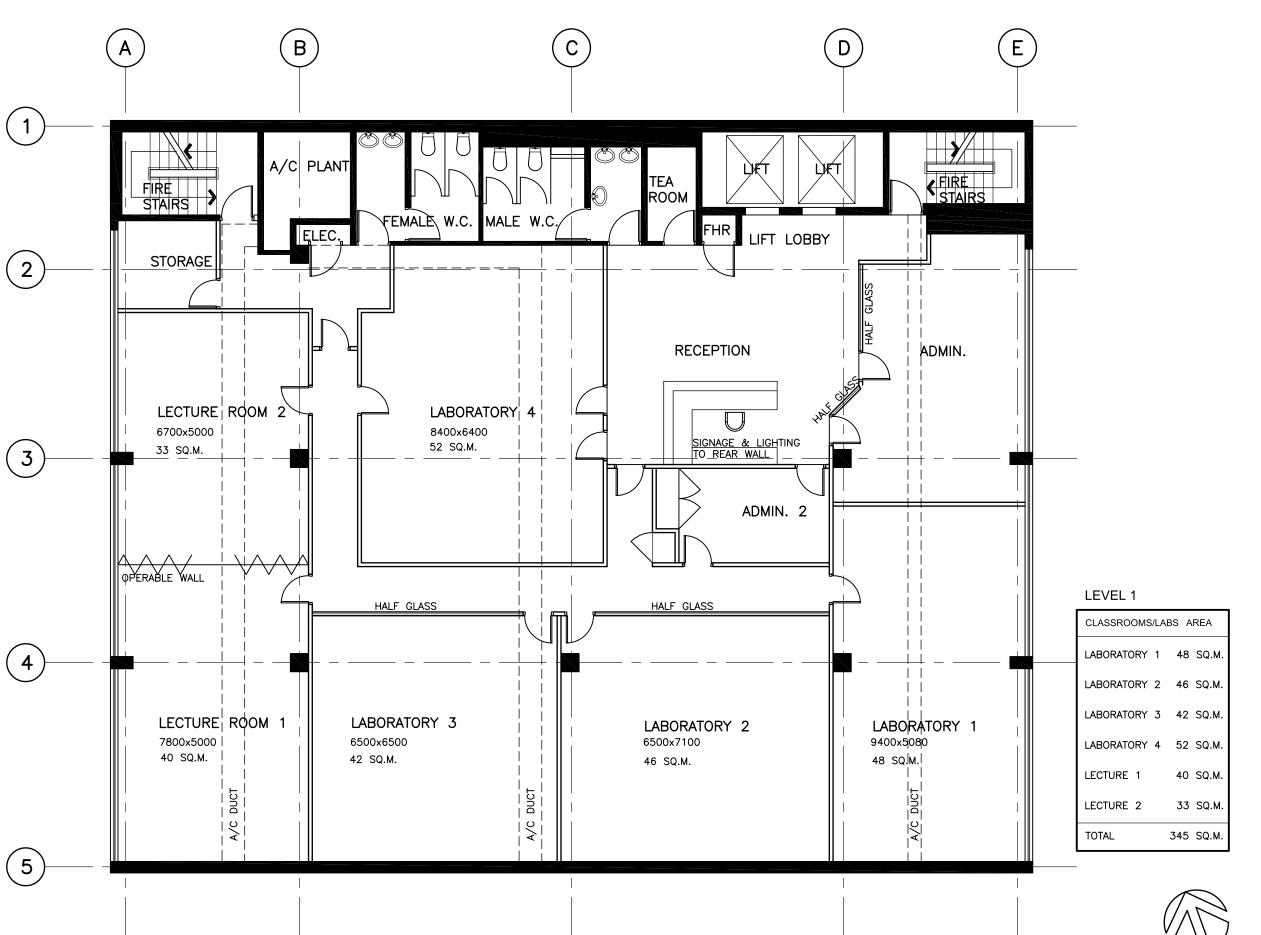

— PLASTERBOARD PARTITIONS, FULL HEIGHT TO CEILING

= PLASTERBOARD PARTITION TO 1200mm AFFL, WITH GLASS OVER TO CEILING.

----- EXISTING A/C DUCTWORK, TO
----- BE EXTENDED ACCORDING TO
MECH. ENGR. DETAILS.

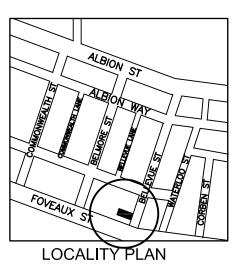

Notes: Use figured dimensions in preference to scale. All dimensions to be verified and checked on site.

ROSALIND FREEMAN "PARKVIEW" 2/1B INNES ROAD GREENWICH, NSW, 2065 PHONE: (02) 9390 7441

Project

UNIVERSITY OF SOUTHERN QUEENSLAND

Address

LEVEL 3, 29-37 BELLEVUE STREET SURRY HILLS


Drawing Title

LEVEL 1 EXISTING FLOOR PLAN

Scale: 1:100


Date: NOVEMBER, 2004

Drawn By: RO

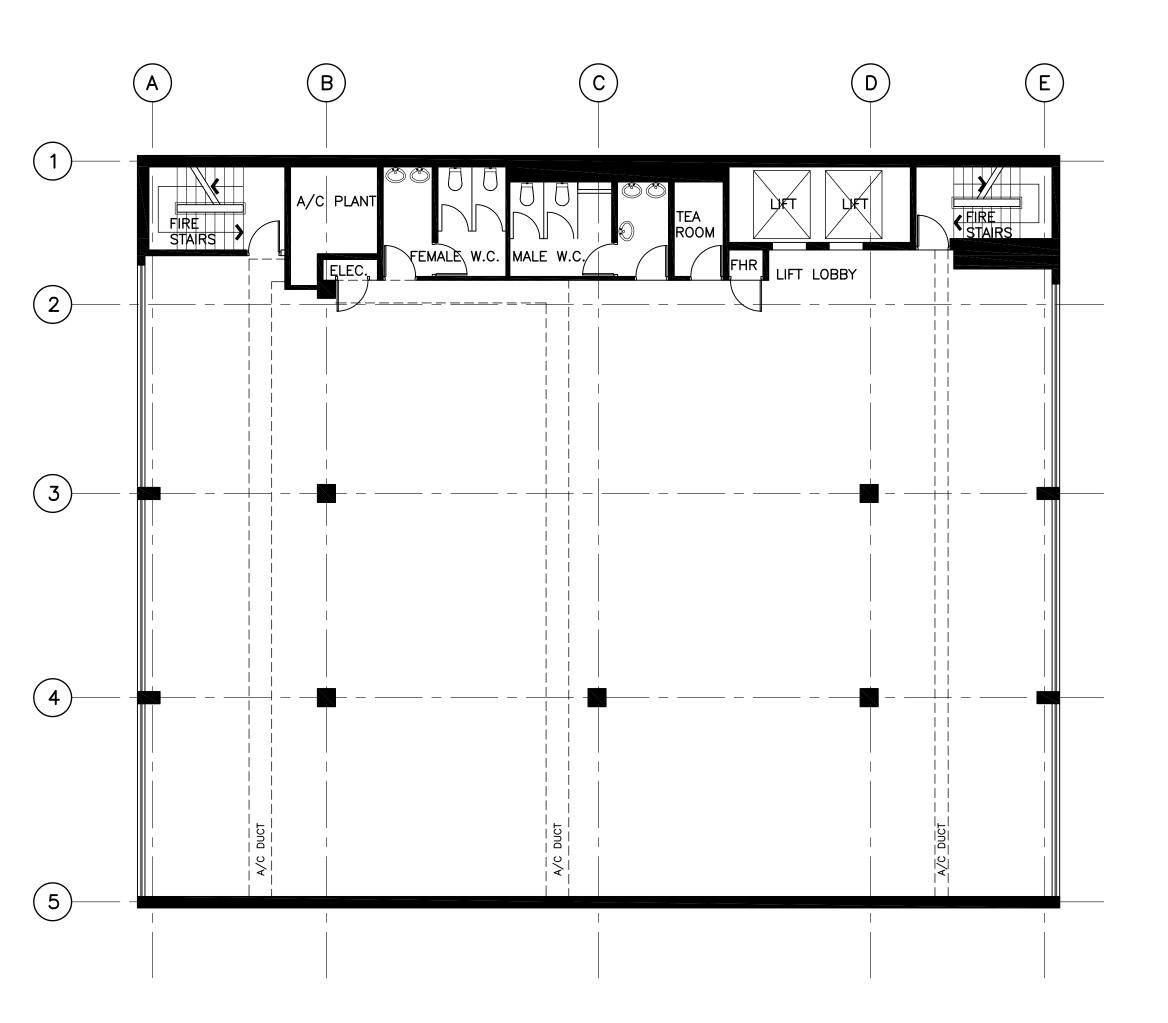

PLASTERBOARD PARTITIONS,
FULL HEIGHT TO CEILING

PLASTERBOARD PARTITION TO
1200mm AFFL, WITH GLASS
OVER TO CEILING.

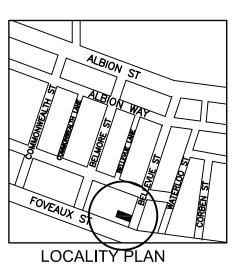

Notes: Use figured dimensions in preference to scale. All dimensions to be verified and checked on site.

ROSALIND FREEMAN 31 WARK AVENUE PAGEWOOD NSW 2035 PHONE: (02) 9390 7441

Project

UNIVERSITY OF SOUTHERN QUEENSLAND

Address

LEVEL 3, 29-37 BELLEVUE STREET SURRY HILLS

Drawing Title

LEVEL 2 EXISTING FLOOR PLAN


Scale:

1:100

Date: NOVEMBER, 2004

Drawn By: ROS



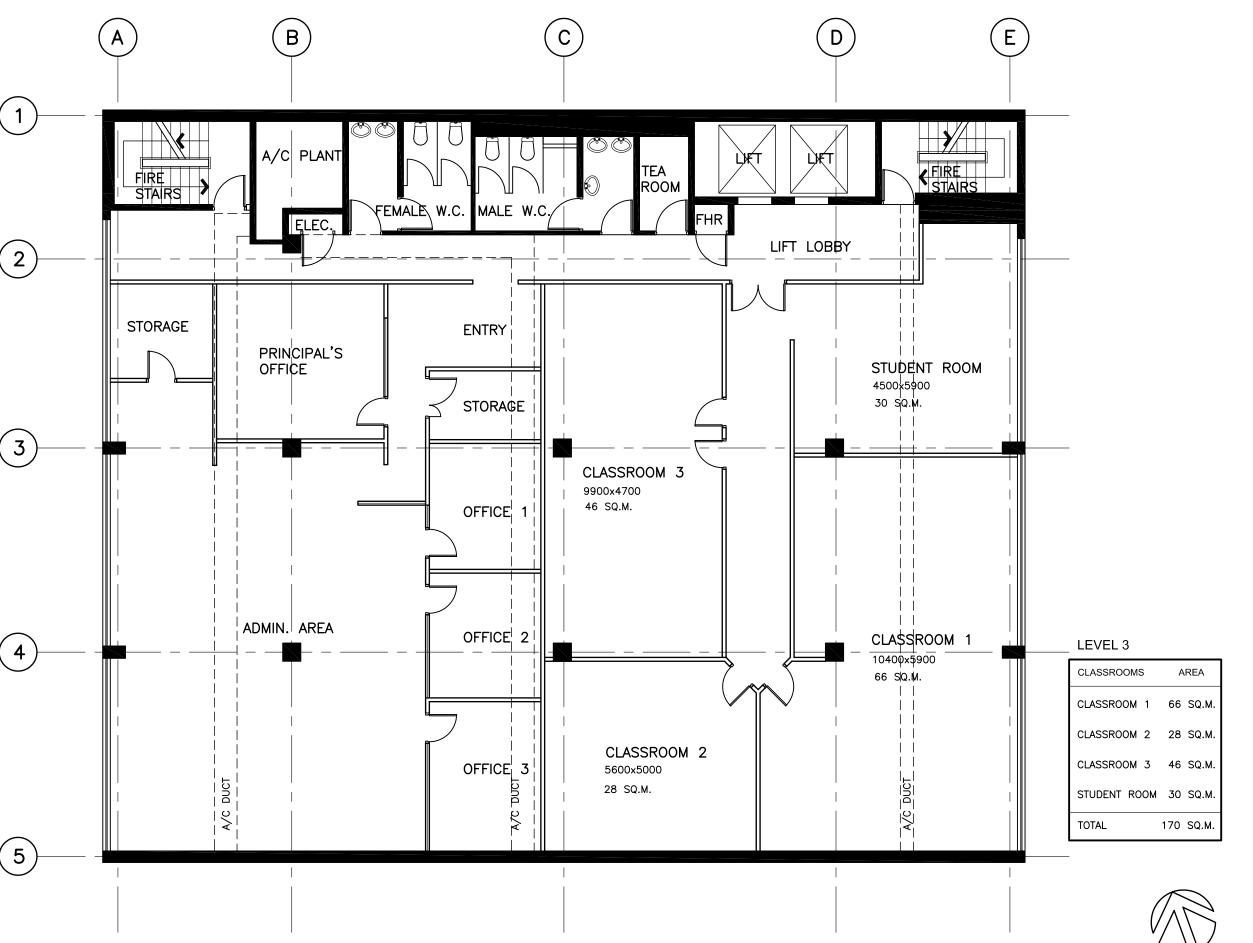


PLASTERBOARD PARTITIONS, FULL HEIGHT TO CEILING

FULL HEIGHT GLAZING.

— — EXISTING A/C DUCTWORK, TO

— BE EXTENDED ACCORDING TO MECH. ENGR. DETAILS.

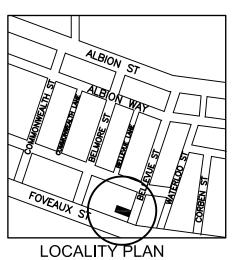

Notes: Use figured dimensions in preference to scale. All dimensions to be verified and checked on site.

ROSALIND FREEMAN "PARKVIEW" 2/1B INNES ROAD GREENWICH, NSW, 2065 PHONE: (02) 9390 7441

Project

UNIVERSITY OF SOUTHERN QUEENSLAND

Address

LEVEL 3, 29-37 BELLEVUE STREET **SURRY HILLS**


Drawing Title

LEVEL 3 **EXISTING FLOOR PLAN**


Scale: 1:100

Date: NOVEMBER, 2004

Drawn By:

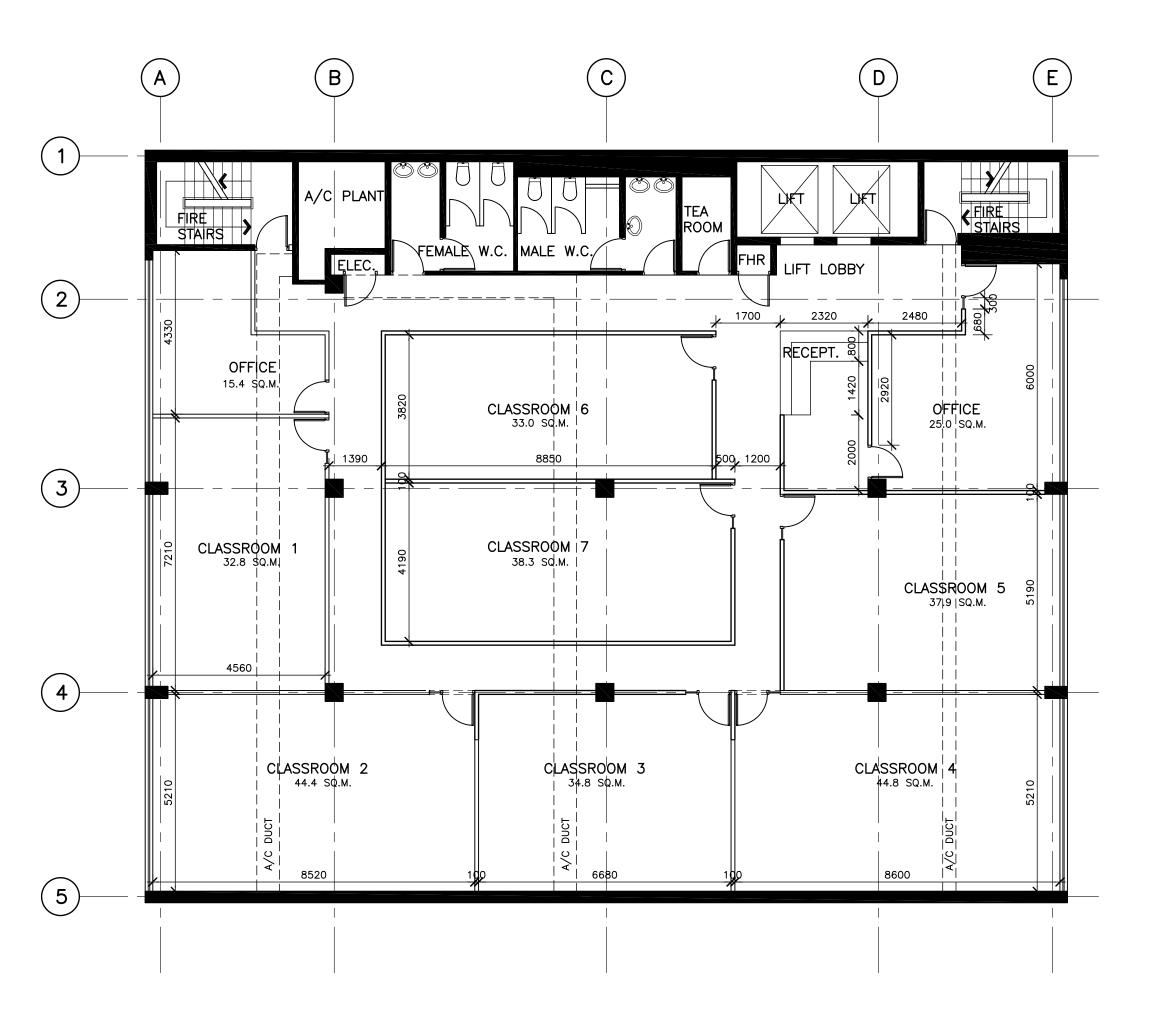

FULL HEIGHT GLAZING

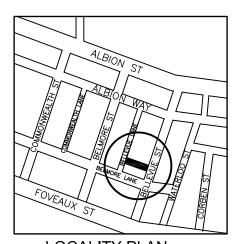

LOCALITY PLAN

Notes: Use figured dimensions in preference to scale. All dimensions to be verified and checked on site.

ROSALIND FREEMAN 31 WARK AVENUE PAGEWOOD 2035

PHONE: (02) 9390 7441

Project

CANTERBURY POLYTECHNIC INSTITUTE

Address

29-37 BELLEVUE STREET SURRY HILLS

Drawing Title


LEVEL 4 FPROPOSED LOOR PLAN



Scale: 1:100


Date: AUGUST, 2006

Drawn By: ROS

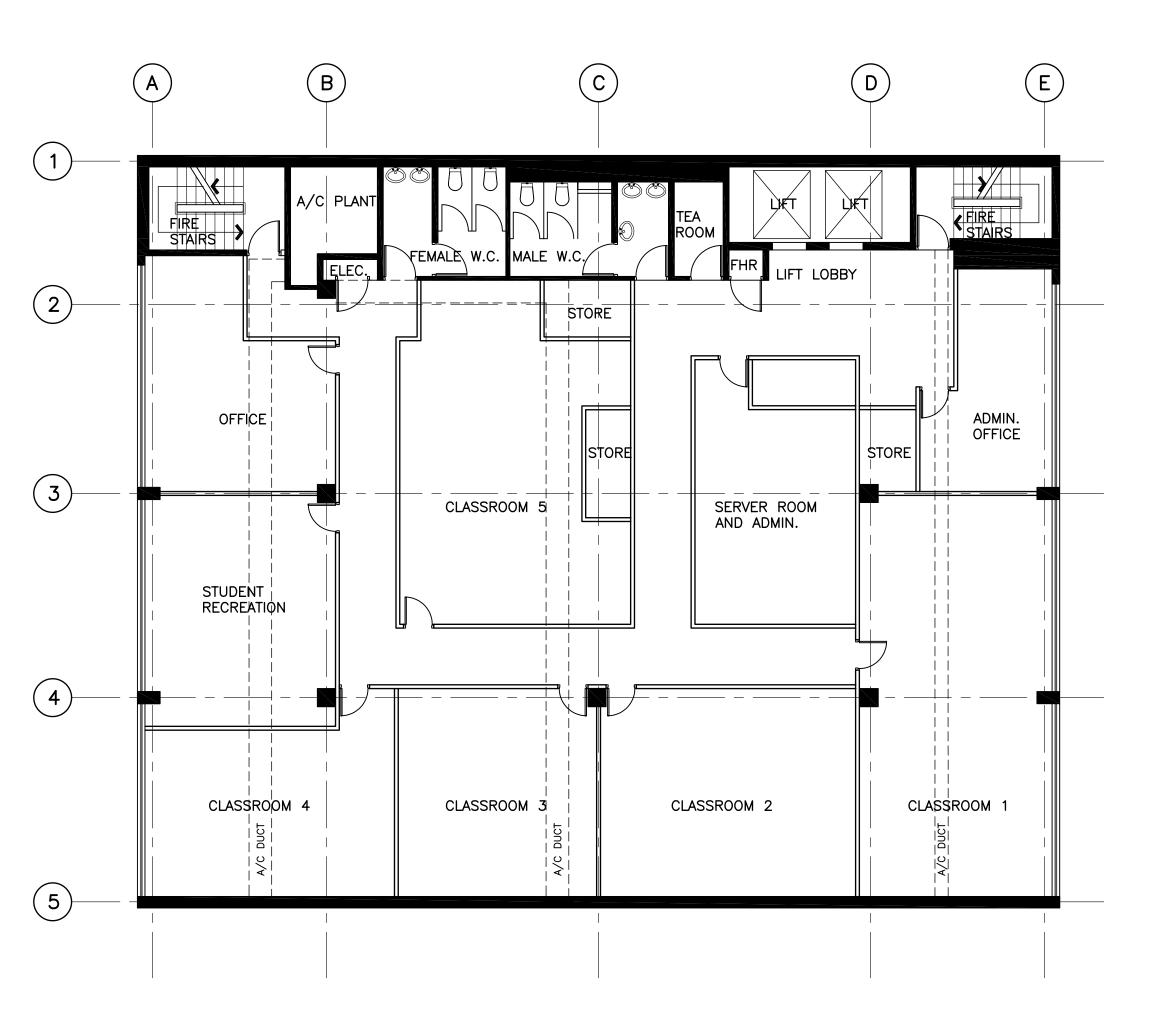

PLASTERBOARD PARTITIONS, FULL HEIGHT TO CEILING PLASTERBOARD PARTITION TO 1200mm AFFL, WITH GLASS OVER TO CEILING.

EXISTING A/C DUCTWORK, TO BE EXTENDED ACCORDING TO MECH. ENGR. DETAILS.

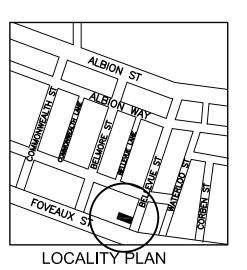

Notes: Use figured dimensions in preference to scale. All dimensions to be verified and checked on site.

ROSALIND FREEMAN 31 WARK AVENUE PAGEWOOD NSW 2035 PHONE: (02) 9390 7441

Project

UNIVERSITY OF SOUTHERN QUEENSLAND

Address


LEVEL 3, 29-37 BELLEVUE STREET **SURRY HILLS**

Drawing Title

LEVEL 6 **EXISTING FLOOR PLAN**




Scale: 1:100 Date: JULY, 2008 Drawn By:

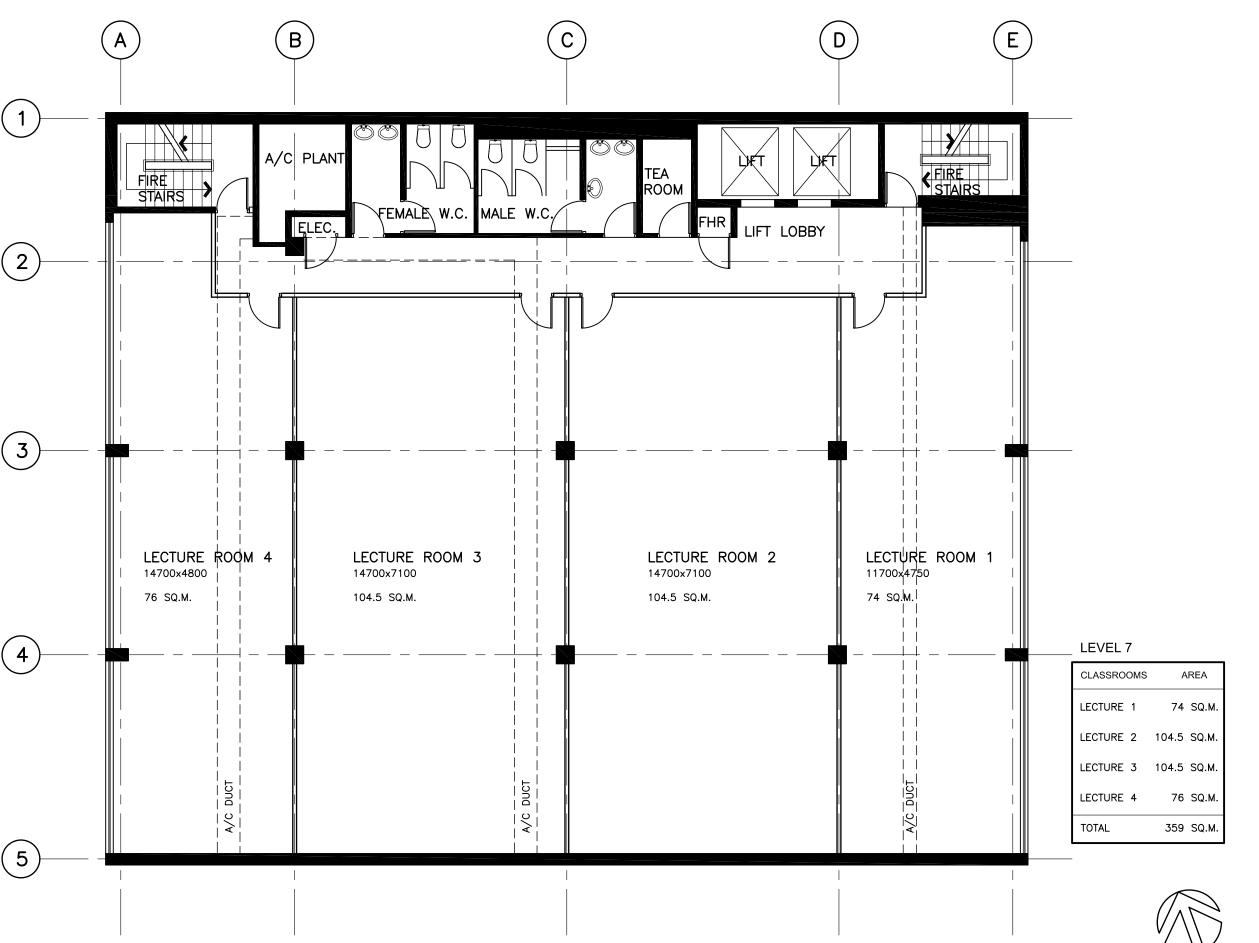

— PLASTERBOARD PARTITIONS, FULL HEIGHT TO CEILING

= PLASTERBOARD PARTITION TO 1200mm AFFL, WITH GLASS OVER TO CEILING.

---- EXISTING A/C DUCTWORK, TO
---- BE EXTENDED ACCORDING TO
MECH. ENGR. DETAILS.

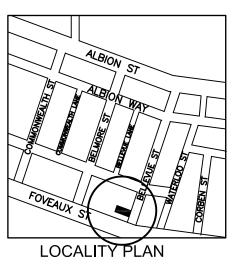

Notes: Use figured dimensions in preference to scale. All dimensions to be verified and checked on site.

ROSALIND FREEMAN
"PARKVIEW"
2/1B INNES ROAD
GREENWICH, NSW, 2065
PHONE: (02) 9390 7441

Project

UNIVERSITY OF SOUTHERN QUEENSLAND

Address

LEVEL 3, 29-37 BELLEVUE STREET SURRY HILLS


Drawing Title

LEVEL 7 EXISTING FLOOR PLAN

Scale: 1:100


Date: NOVEMBER, 2001

Drawn By: RO

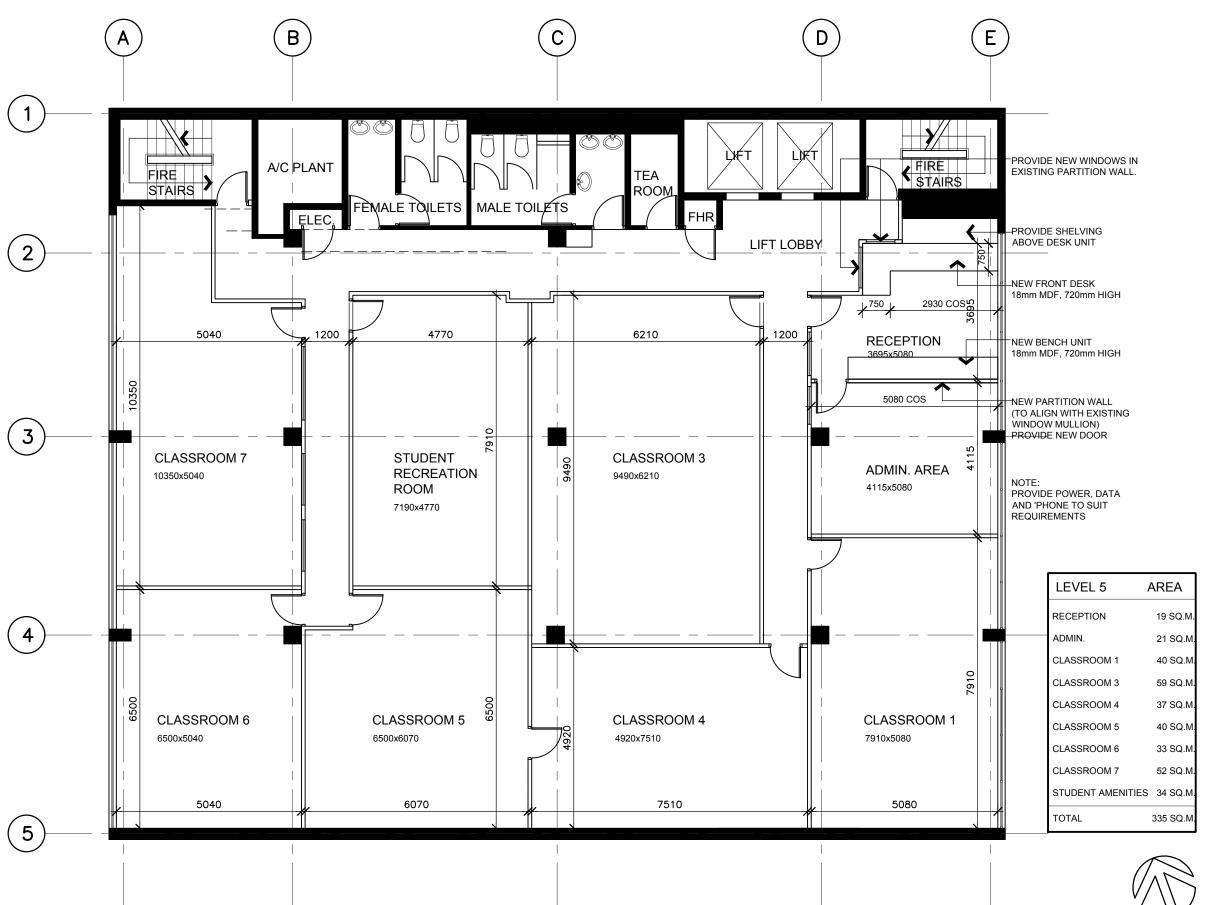

PLASTERBOARD PARTITIONS, FULL HEIGHT TO CEILING

PLASTERBOARD PARTITION TO
1200mm AFFL, WITH GLASS OVER
TO CEILING.

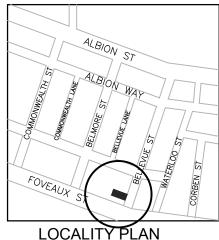

Notes: Use figured dimensions in preference to scale. All dimensions to be verified and checked on site.

ROSALIND FREEMAN 31 WARK AVENUE PAGEWOOD NSW 2035

PHONE: (02) 9390 7441

Project

UNIVERSITY OF SOUTHERN QUEENSLAND

Address

LEVEL 5, 29-37 BELLEVUE STREET SURRY HILLS

Drawing Title

LEVEL 5 FLOOR PLAN

Scale: 1:100

Date: DECEMBER, 2015

wing No. CA-05

Revision