


DOHERTY'S ROAD

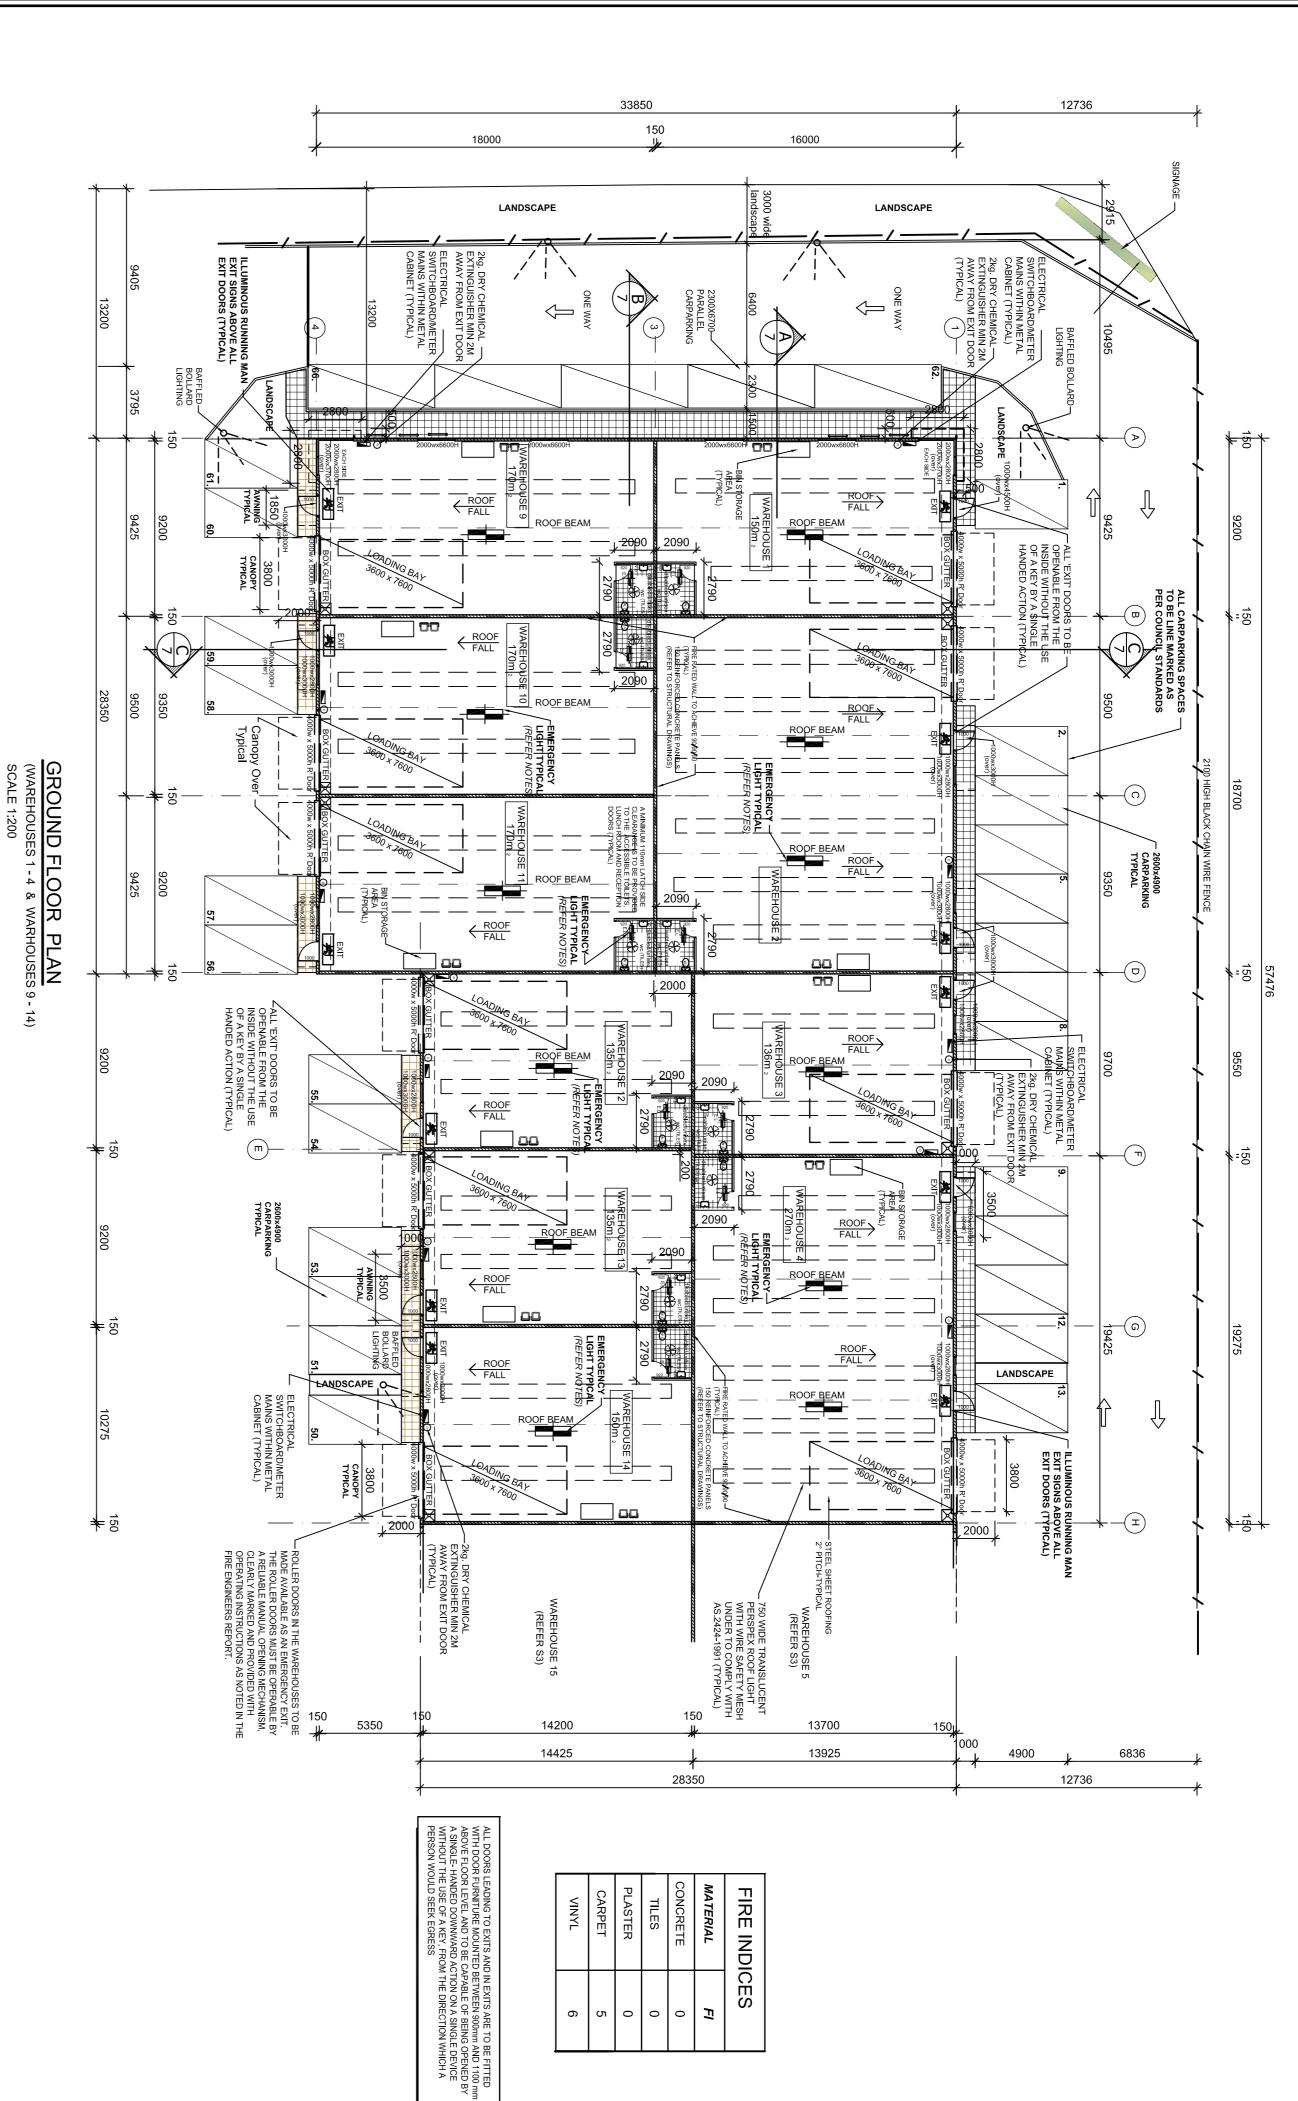

ENERGY EFFICIENCY REQUIREMENTS FOR INDUSTRIAL BUILDINGS

BCA SECTION 'J' COMPLIANCE

J1. BUILDING FABRIC*
2.1 ROOF / CEILING INSULATED TO R 3.2
2.2 WALLS - EXTERNAL CONCRETE WALLS BATTENED OUT (20-35 LINED WITH PLASTER AND INSULATED TO R 1.0
2.3 WALLS - INTERNAL 2.4 FIRST FLOOR (OPEN TO UNDERSIDE) INSULATED TO R.1.5
2.5 FIRST FLOOR (ENCLOSED UNDERNEATH) -INSULATED TO R.1.5

J2. EXTERNAL GLAZING*

J3. BUILDING SEALING ALL WINDOWS TO COMPLY WITH AS. 2047*

ALL EXHAUST FANS SHALL BE FITTED WITH SELF CLOSING DAMPER OR SIMILAR APPROVED. PROVIDE RUBBER COMPRESSIBLE STRIP SEALS OR SIMILAR TO ENTIRE PERIMETER OF DOOR FRAMES EXCLUDING FIRE OR SMOKE DOORS. SELF CLOSING DEVICE TO MAIN ENTRANCE DOORS IF MANUALLY OPERATED

J4. AIR MOVEMENT

J5. AIR CONDITIONING*

J6. ARTIFICIAL LIGHTING AND POWER*

J7. HOT WATER SUPPLY*

J8. ACCESS FOR MAINTENANCE ALL SERVICES LOCATED IN THE ROOF MUST BE

WITH SUITABLE

3. FINISHES INTERNALLY:
CERAMIC FLOOR TILES TO IMPERVIOUS FLOOR OVER APF-SUBBASE
· CERAMIC WALL TILES TO 300mm ABOVE VANITY BASINS.
SHOWERS TILED TO 1800 HIGH.

ROVED

ALL AIR LOCKS AND W.C DOORS TO HAVE SELF (REMOVABLE HINGES TO STANDARD WC).

CLOSER

CERTIFICATE OF COMPLIANCE REQUIRED
WITH PART J OF THE BCA 2013

FIRE FIGHTING / EMERGENCY EQUIPMENT:

NOTES:
GENERAL:
DO NOT SCALE DRAWING, FIGURED DIMENSIONS TO TAK
1. PRECEDENCE OVER SCALED DRAWING.

BUILDER TO VARIFY ALL DIMENSIONS, LEVELS & SOIL CLA 2. PRIOR TO COMMENCEMENT OF ANY WORK.

ASS ON SITE

- ALL MATERIALS AND METHODS OF CONSTRUCTION SHAL WITH RELEVANT S.A.A CODES, BUILDING REGULATIONS A LL COMPLY AND B.C.A
- ALL DOWNPIPES (dp) TO BE 150Ø P.V.C GUTTERS TO BE 600w X 250d. ZINCALUME FINISH SHEET STEEL FLASH AND CAP OVER. ROOF:
- NATURAL ACRYLIC ROOFLIGHTING TO MATCH STEEL DECAND TO BE KEPT 750 CLEAR OF GUTTERS AND SIDE BOUI PROVIDE WIRE MESH UNDER 3mm THICKNESS, 300 X 150

ROOF DECKING TO BE L.B.I TRIMDECK OR APPROVED SIMILAR ZINCALUME FINISH SHEET STEEL SET AT 3° MIN PITCH. SARKING TO

- AMENITIES:

- CONSTRUCTION: 90 x 45 F7 TREATED PINE FRAMING @450cts. 200 X 50 F7 OREGON CEILING JOISTS @ 450 cts TERMITE TREATMENT MUST BE APPLIED
 - CK IN PROFILE JNDARIES.) GRID.

3A 40 B (E) DRYEXTINGUISHERS ARE REQUIRED AT A MIN 2 METERS AND MAX 20 METERS FROM ANY SWITCHBOARD CHEMICAL EXTINGUISHER PLACED ADJACENT TO ELECTRICAL 40 B (E) EXTINGUISHER, PLACED NEAR REQUIRED EXIT DOOR COMPLYING TO AS2293-2005

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'ALU' SINGLE SIDED EMERGENCY RUNNING MAN EXIT SIGN COMPLYING TO AS2293 AND CLAUSE E4.5 OF THE BCA EMERGENCY SIGN PICTOGRAM AND EMERGENCY LIGHTING TO AS2293.1The minimum pictorial element height in the exit signs shall be no less than 200mm

EMERGENCY LIGHTS "FAMCO" F990284 MOUNTING HEIGHT 6.0m (Co21m C90 18m) COMPLYING TO AS2293-2005 ANDCLAUSE E 4.2 OF THE BCA

PORTABLE FIRE EXTINGUISHERSARE TO BE PROVIDED AS PER BCA TABLE E1.6 AND AS 2444-2001 MOUNTING HEIGHT NOT MORE THAN 1200mm ABOVE FFL WINDOWS / DOORS: ALL GLAZING TO COMPLY WITH AS1288. WINDOW MANUFACTURER TO PROVIDE SPECIFICATIONS PRIOR TO INSTALLATION FOR BUILDING SURVEYOR. ALL WINDOWS TO BE ALUMINIUM FRAMED "COMMERCIAL" TYPE SECTIONS POWDER COATED TO OWNERS SELECTION. FABRICATOE TO PROVIDE ALL ANGLES & COVER PLATES IN SAME COLOUR. ALL EXIT DOORS TO BE OPENABLE FROM THE INSIDE WITHOUT THE USE OF A KEY BY A SINGLE HANDED ACTION.

ALL DOORS LEADING TO EXITS AND IN EXITS ARE TO BE FITTED WITH DOOR FURNITURE MOUNTED BETWEEN 900mm AND 1100 mm ABOVE FLOOR LEVEL AND TO BE CAPABLE OF BEING OPENED BY A SINGLE-HANDED DOWNWARD ACTION ON A SINGLE DEVICE WITHOUT THE USE OF A KEY, FROM THE DIRECTION WHICH A PERSON WOULD SEEK

5. VISUAL INDICATORS ON GLAZING-ALL FRAMELESS OR FULLY GLAZED DOORS, SIDELIGHTS, INCLUDING ANY GLAZING CAPABLE OF BEING MISTAKEN FOR A DOORWAY OR OPENING SHALL BE CLEARLY MARKED FOR THEIR FULL WIDTH WITH A SOLID CONTRASTING LINE.

THE CONTRASTING LINE MUST BE NOT LESS THAN 75mm WIDE AND SHALL EXTEND THE FULL WIDTH THE GLAZING PANEL. THE LOWER EDGE OF THE CONTRASTING LINESHALL BE LOCATED BETWEEN 900mm AND1000mm ABOVE FFL

NO. OF EMPLOYEES each building

WRITTEN STATEMENT

This application is for the appu oval to build 24 co will be for the storage 으

The building has the provisions of a loading bay as required by clause 52.07 of the planning scheme The hours of operation will be 6am-10pm Monday to Sunday.
The number of staff will be assumed 4 full time persons.

The Town planning drawings ent is in an are where there is predominantly commercial and industrial buildings. The proposal is in keeping with nearby and mbered 16016F clearly show the industrial guidelines have been followed.

be built in existing business activity center where all adjoining buildings are commercial or industrial buildings. The is and will not impact on surrounding developments with adequate on site car parking available for the building. The 3 and the proposed landscape buffers to the front of the property will positively add to the street scape. I evelopment will contribute positively to the local street scape and the layout of this development enhances personal

to cc

not near any residential areas and the design and scale of the opment will not detrimentally effect this area. nt is in kee eping with

bility Disc

tion Act 1992.

any hazardous goods so no dange

LIGHT AND	VENTIL	ATION SC	HEDULE	EACH W	LIGHT AND VENTILATION SCHEDULE EACH WAREHOUSE
MOOR		%01 THDIT	%	NENTILATION 5%	TION 5%
700]	REQUIRED	AVAILABLE	REQUIRED	AVAILABLE
WAREHOUSE 1	150m ²	15m²	77.5m ²	7.5m ²	22.1m ²
WC/AL	1	Artificial Lig	ht & Mechan	Artificial Light & Mechanical Ventilation Required	Required
WAREHOUSE 2	300m ²	30m²	74.4m ²	15m ²	24.2 ²
WC/AL	-	Artificial Lig	ht & Mechan	Artificial Light & Mechan cal Ventilation Required	n Required
WAREHOUSE 3	136m ²	13.6m ²	28m²	6.8m ²	22.1m ²
WC/AL	-	Artificial Lig	ht & Mechan	Artificial Light & Mechan cal Ventilation	Required
WAREHOUSE 4	270m ²	27m ²	74.4m ²	13.5m ²	24.2 2
WC/AL	1	Artificial Lig	Artificial Light & Mechan	cal Ventilation	Required
WAREHOUSE 9	170m ²	17m ²	77.5m ²	8.5m ²	22.1m ²
WC/AL	ı	Artificial Lig	nt & Mechan	Artificial Light & Mechan cal Ventilation	Required
WAREHOUSE 10	170m ²	17m ²	35m ²	8.5m ²	22.1m ²
WC/AL	ı	Artificial Lig	Artificial Light & Mechan	cal Ventilation	Required
WAREHOUSE 11	170m ²	17m ²	35m ²	8.5m ²	22.1m ²
WC/AL	ı	Artificial Lig	Artificial Light & Mechan	cal Ventilation	Required
WAREHOUSE 12	135m ²	13.5m ²	29.8m ²	6.75m ²	22.1m ²
WC/AL	ı	Artificial Lig	Artificial Light & Mechan	cal Ventilation	Required
WAREHOUSE 13	135m ²	13.5m ²	29.8m ²	6.75m ²	22.1m ²
WC/AL	ı	Artificial Lig	nt & Mechan	Artificial Light & Mechan cal Ventilation Required	Required
WAREHOUSE 14	150m ²	15m ²	29.8m ²	7.5m ²	22.1m ²
WC/AL	1	Artificial Lig	ht & Mechan	Artificial Light & Mechan cal Ventilation Required	Required

MECHANICAL VENTILATION TO BE DUCTED TO EXTERNAL AIR AND TO PROVIDE 2L/S CHANGES OF AIR TO EACH W.C & A.L A HABITABLE ROOM, OFFICE, SHOP,FACTORY,WORKROOM,SANITARY COMPARTMENT,BATHROOM,SHOWER ROOM,LAUNDRY AND ANY OTHER ROOM OCCUPIED BY A PERSON FOR ANY PURPOSE MUST HAVE NATURAL VENTILATION COMPLYING WITH F4.6 OF THE BCA OR ALTERNATIVELY INSTALL A MECHANICAL VENTILATION AND OR AIR CONDITIONING SYSTEM COMPLYING WITH AS1668.2 AND AS/NZS 3666.1

NOTES σ 4 ω Δ Δ PROVIDE SIMPLE LEVER HANDLE TO ALL EXIT DOORS.
LIFT OFF HINGES TO ALL WC DOORS.
NO STORAGE UNDER STAIRS.
FANS DUCTED TO OUTSIDE FOR WC's.
FANS / LIGHT SWITCH COMBINED.

FIGURED DIMENSIONS TO TAKE PRECEDENCE OVER SCALED DIMENSIONS.


PROPOSED: WAREHOUSE/OFFICE
DEVELOPMENT
AT: LOT 20 DOHERTYS ROA
TRUGANINA PROJECT: ROAD

DRAWING TITLE ANDREWS COMPLETE
DRAFTING SERVICE
ANDREW FARRUGIA
Ph/fax: 9 421 3655
Mobile: 0414 543 702
Email:acds@linet.net.au

FOR: KMERCIAL P/L

ARCHITECTURAL

THESE DRAWINGS ARE TO BE READ IN CONJUNCTION WITH RELEVANT STRUCTURAL DRAWINGS, ROOF TRUSS MANUFACTURER AND RELEVANT DOCUMENTATION.

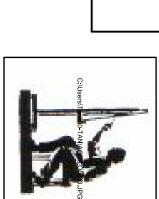

BUILDER TO VERIFY ALL DIMENSIONS, LEVELS & SOIL CLASSIFICATION PRIOR TO COMMENCING ANY WORK.

2 OF 7

DRAWN:

A.FARRUGIA

16016F

SCALE:

1:200@A1

SHEET:

DATE:

PROJECT NO

FOR PROFESSIONAL DRAWING AND SERVICE

26-09-2016

28350 000 14425 13925 4900 14200 13700 STEEL SHEET RO VAREHOUSE 14 (REFER S2) 2kg. DRY CHEMICAL — EXTINGUISHER MIN 2M AWAY FROM EXIT DOOR (TYPICAL) CHBOARD/METER S WITHIN METAL NET (TYPICAL) 2000 4 \triangle 10275 10425 ← ROOF FALL LANDSCAPE ROOF LANDSCAPE 10425 2kg. DRY CHEMICAL — EXTINGUISHER MIN 2M AWAY FROM EXIT DOOR (TYPICAL) | -(c) 00 GROUND FLOOR PLAN (WAREHOUSES 5-8 & WARHOUSES SCALE 1:200 10425 - ILLUMINOUS RUNNING N EXIT SIGNS ABOVE ALL EXIT DOORS (TYPICAL) ← ROOF FALL LANDSCAPE LANDSCAPE_O 10245 10425 OPENABLE FROM THE INSIDE WITHOUT THE LOF A KEY BY A SINGLE HANDED ACTION (TYPIC 2kg. DRY CHEMICAL CONTROL 2M EXTINGUISHER MIN 2M AWAY FROM EXIT DOOR ROOF BEAM___ 9 16775 17000 \int ROOF BEAM_ ROOF BEAM Î ROOF FALL EXIT $\sqrt{|\phi\rangle}$ SLIDING GATE ENTRY TRESHHOLD SHALL NOT EXCEED 5mm - ALL CARPARKING SPACES TO BE LINE MARKED AS PER COUNCIL STANDARDS CARRAGEWAY EASEMENT (ŋ) 28350 \leftarrow 26000 4600 10213

MATERIAL PLASTER FIRE INDICES VINYL 5 0 0 0 7 6

MENS/W

RENCLOSED SPACES WITH A ROOM ASPECT RATIO OF LESS THAN 1.5 THE MAX ILLUMINATION POWER DENSITY BE INCREASED BY DIVIDING IT BY AN ADJUSTMENT FACTOR FOR ROOM ASPECT WHICH IS:0.5+(ROOM ASPECT O/3)

AL CONSTRUCTION CODE (N.C.C)TABLE J6.2a ,3 PACES WITH A ROOM ASPECT RATIO OF LESS THAN 1.5 THE MAX ILLUMINATION POWER DENSITY D BY DIVIDING IT BY AN ADJUSTMENT FACTOR FOR ROOM ASPECT WHICH IS : 0.5+(ROOM ASPECT

SPACE

AREA_{M²}

ARTIFICIALLY LIT TO AN AMBIENT LEVEL OF 200 IX
OR MORE
ARTIFICIALLY LIT TO AN AMBIENT LEVEL OF LESS
THAN 200 IX

1212m ²

7 W/m²

6 W/m² 6 W/m²

MAXIMU

M ILLUMINATION POWER DENSITY

DOHERTY'S

ROAD

ALL DOORS LEADING TO EXITS AND IN EXITS ARE TO BE FITTED WITH DOOR FURNITURE MOUNTED BETWEEN 900nm AND 1100 mm ABOVE FLOOR LEVEL AND TO BE CAPABLE OF BEING OPENED BY A SINGLE-HANDED DOWNWARD ACTION ON A SINGLE DEVICE WITHOUT THE USE OF A KEY, FROM THE DIRECTION WHICH A PERSON WOULD SEEK EGRESS

IN ADDITION TO AB ILLUMINATION POW THE CONTROL DEV

AL CONSTRUCTION CODE tABLE J6.2a .3 BOVE THE MAX ILLUMINATION POWER DENSITY MAY BE INCREASED BY DIVIDING IT BY THE VER DENSITY ADJUSTMENT FACTOR IN TABLE J6.2b OF THE N.C.C WHERE APPLICABE AND WHERE VICE IS NOT INSTALLED TO COMPLY WITH J6.3 OF N.C.C

)/3) R TO NATION/

LIGHT AI

NP VENTILATION SCHEDULEFEACH WAREHOUSE

ROOM AREHOUSE 16 AREA_{M²} 246m ² 300m² 150m² 150m² 150m 150m 146m 238m 46m REQUIRED Artificial Light & Mechanic Artificial Light & Mechar 15m² 28m² Artificial Light & Mechan c 24.6m² 129.5m² Artificial Light & Mechan c 23.8m² 129.5m² Artificial Light & Mechan 15m² 28m² Artificial Light & Mecha 15m² Artificial Lig Artificial Light & Mechar 10% AVAILABLE 28m² ynt & Mecha 7.3m² 22.1m² REQUIRED AVAILABLE cal Ventilation Required cal Ventilation Required VENTILATION 15m² ի Required Required 22.1m² 24.2 2

TABLE ROOM, OFFICE, ACTORY, WORKROOM, SANITARY ACTORY, WORKROOM, SANITARY ROOM, LAUNDRY AND ANY ROOM OCCUPIED BY A PERSON FOR ANY PURPOSE MUST ATURAL VENTILATION COMPLYING WITH F4.6 OF THE BCA ERNATIVELY INSTALL A MECHANICAL VENTILATION AND OR IDITIONING SYSTEM COMPLYING WITH AS1668.2 AND 3666.1 AL VENTILATION TO BE DUCTED TO EXTERNAL AIR OVIDE 2L/S CHANGES OF AIR TO EACH W.C & A.L

NOTES

1. PROVIDE
2. LIFT OFF
3. NO STOR.
4. FANS DUO
5. FANS / LIO

. PROVIDE SIMPLE LEVER HANDLE TO ALL EXIT DOORS.
. LIFT OFF HINGES TO ALL WC DOORS.
. NO STORAGE UNDER STAIRS.
. FANS DUCTED TO OUTSIDE FOR WC's.
. FANS / LIGHT SWITCH COMBINED.

FIGURED DIMENSIONS TO TAKE PRECEDENCE OVER SCALED DIMENSIONS.

PROPOSED: WAREHOUSE/OFFICE
DEVELOPMENT
AT: LOT 20 DOHERTYS ROAD
TRUGANINA
FOR: KMERCIAL P/L PROJECT: ROAD

DRAWING TITLE

ARCHITECTURAL

ANDREWS COMPLETE
DRAFTING SERVICE
ANDREW FARRUGIA
Ph/fax: 9 421 3655
Mobile: 0414 543 702
Email:acds@linet.net.au

FOR PROFESSIONAL DRAWING AND SERVICE

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BUILDER TO VERIFY ALL DIMENSIONS, LEVELS & SOIL CLASSIFICATION PRIOR TO COMMENCING ANY WORK.

1:200@A1 26-09-2016

FINISHES INTERNALLY:
CERAMIC FLOOR TILES TO IMPERVIOUS FLOOR OVER APPROV-SUBBASE
CERAMIC WALL TILES TO 300mm ABOVE VANITY BASINS.
SHOWERS TILED TO 1800 HIGH.

ALL AIR LOCKS AND W.C DOORS TO HAVE SELF CLOSERS (REMOVABLE HINGES TO STANDARD WC).

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ALL WINDOWS TO BE ALUMINIUM FRAMED "COMMERCIAL" TYPE SECTIONS POWDER COATED TO OWNERS SELECTION.
FABRICATOE TO PROVIDE ALL ANGLES & COVER PLATES IN SAME

^{ARD.} **VG TO AS2293-2005**

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ALL EXIT DOORS TO BE OPENABLE FROM THE INSIDE WITHOUT THE USE OF A KEY BY A SINGLE HANDED ACTION.

EMERGENCY LIGHTS "FAMCO" F990284 MOUNTING HEIGHT 6.0m (Co21m C90 18m) COMPLYING TO AS2293-2005 ANDCLAUSE E 4.2 OF THE BCA

J4. AIR MOVEMENT N/A

J8. ACCESS FOR MAINTENANCE
ALL SERVICES LOCATED IN THE ROOF MUST BE MEANS.

J7. HOT WATER SUPPLY*

J6. ARTIFICIAL LIGHTING AND POWER*

J5. AIR CONDITIONING*

AMENITIES:

1. CONSTRUCTION:
 .90 x 45 F7 TREATED PINE FRAMING @450cts.
 .200 X 50 F7 OREGON CEILING JOISTS @ 450 cts.
TERMITE TREATMENT MUST BE APPLIED

ALL EXHAUST FANS SHALL BE FITTED WITH SELF CLOSING DAMPER OR SIMILAR APPROVED.

PROVIDE RUBBER COMPRESSIBLE STRIP SEALS OR SIMILAR TO ENTIRE PERIMETER OF DOOR FRAMES EXCLUDING FIRE OR SMOKE DOORS. SELF CLOSING DEVICE TO MAIN ENTRANCE DOORS IF MANUALLY OPERATED

J3. BUILDING SEALING
ALL WINDOWS TO COMPLY WITH AS. 2047*

ROOF:

ROOF DECKING TO BE L.B.I TRIMDECK OR APPROVED SIMILAR ZINCALUME FINISH SHEET STEEL SET AT 3° MIN PITCH. SARKING

NATURAL ACRYLIC ROOFLIGHTING TO MATCH STEEL DECK IN PROAND TO BE KEPT 750 CLEAR OF GUTTERS AND SIDE BOUNDARIES. PROVIDE WIRE MESH UNDER 3mm THICKNESS, 300 X 150 GRID.

ALL DOWNPIPES (dp) TO BE 150Ø P.V.C GUTTERS TO BE 600w X 250d. ZINCALUME FINISH SHEET STEEL FLASH AND CAP OVER.

J2. EXTERNAL GLAZING*

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BCA SECTION 'J' COMPLIANCE

ENERGY EFFICIENCY REQUIREMENTS FOR INDUSTRIAL BUILDINGS

3A 40 B (E) DRYEXTINGUISHERS ARE REQUIRED AT A MIN 2
METERS AND MAX 20 METERS FROM ANY SWITCHBOARD
CHEMICAL EXTINGUISHER PLACED ADJACENT TO ELECTRICAL PORTABLE FIRE EXTINGUISHERSARE TO BE PROVIDED AS PER BCA TABLE E1.6 AND AS 2444-2001 MOUNTING HEIGHT NOT MORE THAN 1200mm ABOVE FFL 40 B (E) EXTINGUISHER, PLACED NEAR REQUIRED EXIT DOOR

FIRE FIGHTING / EMERGENCY EQUIPMENT:

WINDOWS / DOORS:
ALL GLAZING TO COMPLY WITH AS1288.
WINDOW MANUFACTURER TO PROVIDE SPECIFICATIONS PRIOR TO INSTALLATION FOR BUILDING SURVEYOR.

NOTES:
GENERAL:
DO NOT SCALE DRAWING, FIGURED DIMENSIONS TO TAKE
1. PRECEDENCE OVER SCALED DRAWING.

. 19)

BUILDER TO VARIFY ALL DIMENSIONS, LEVELS & SOIL CLASS ON SITE PRIOR TO COMMENCEMENT OF ANY WORK.

ALL MATERIALS AND METHODS OF CONSTRUCTION SHALL COMP WITH RELEVANT S.A.A CODES, BUILDING REGULATIONS AND B.C.

'ALU' SINGLE SIDED EMERGENCY RUNNING MAN EXIT SIGN COMPLYING TO AS2293 AND CLAUSE E4.5 OF THE BCA EMERGENCY SIGN PICTOGRAM AND EMERGENCY LIGHTING TO AS2293.1The minimum pictorial element height in the exit signs shall be no less than 200mm

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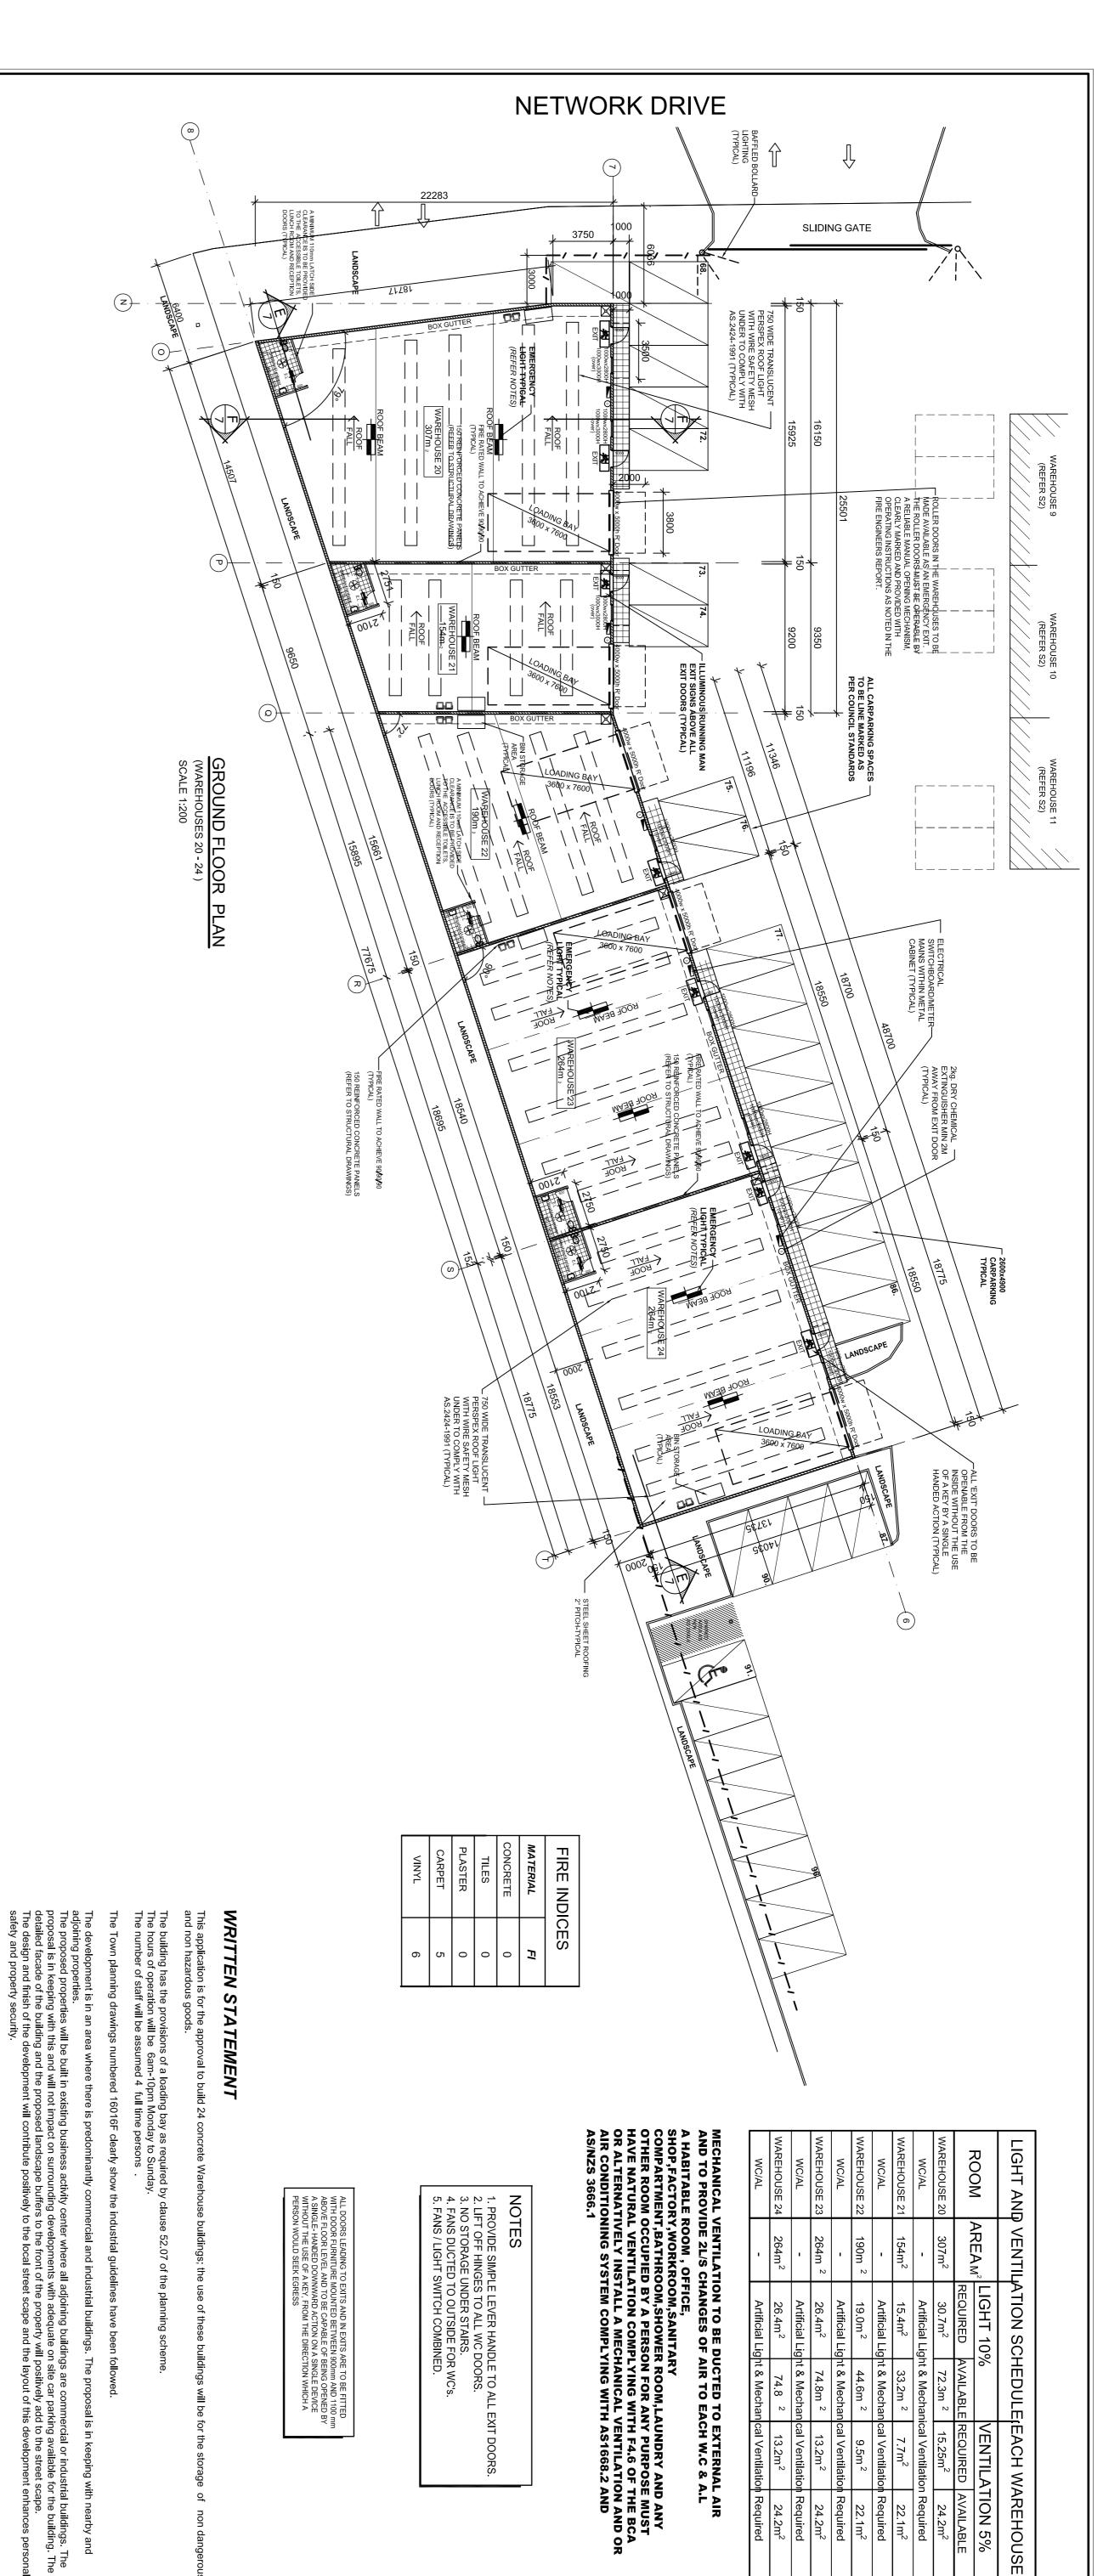
No. OF EMPLOYEES each building

DRAWN: DATE: SCALE: A.FARRUGIA

3 OF 7

SHEET:

PROJECT NO 16016F



LIGHT 10%

'ENTILATION 5%

19.0m²

Artificial Light & Mechan c

26.4m²

74.8m²

Artificial Light & Mechan c

9.5m²
22.1m²
n cal Ventilation Required
13.2m²
24.2m²
n cal Ventilation Required

74.8

15.4m² 33.2m ²
Artificial Light & Mechan

Artificial Light & Mechar

ENERGY EFFICIENCY REQUIREMENTS FOR INDUSTRIAL BUILDINGS

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FINISHES INTERNALLY: CERAMIC FLOOR TILES TO IMPERVIOUS FLOOR OVER APPROVE

ALL AIR LOCKS AND W.C DOORS TO HAVE SELF CL (REMOVABLE HINGES TO STANDARD WC).

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ROOF:
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ZINCALUME FINISH SHEET STEEL FLASH AND CAP OVER.

ROOF DECKING TO BE L.B.I TRIMDECK OR APPROVED SIMILAR ZINCALUME FINISH SHEET STEEL SET AT 3° MIN PITCH. SARKING UNDERSIDE. OT

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AMENITIES:

1. CONSTRUCTION:
1. 90 x 45 F7 TREATED PINE FRAMING @450cts.
200 X 50 F7 OREGON CEILING JOISTS @ 450 cts.
TERMITE TREATMENT MUST BE APPLIED

FIRE FIGHTING / EMERGENCY EQUIPMENT: PORTABLE FIRE EXTINGUISHERSARE TO BE PROVIDED AS PER BCA TABLE E1.6 AND AS 2444-2001 MOUNTING HEIGHT NOT MORE THAN 1200mm ABOVE FFL

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COMPLYING TO AS2293-2005

'ALU' SINGLE SIDED EMERGENCY RUNNING MAN EXIT SIGN COMPLYING TO AS2293 AND CLAUSE E4.5 OF THE BCA EMERGENCY SIGN PICTOGRAM AND EMERGENCY LIGHTING TO AS2293.1The minimum pictorial element height in the exit signs shall be no less than 200mm

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The development has a disa

ne proposed development uildings, we believe the de

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bled toilet and access for disabled persons to comply with Disability Discrimination Act 1992.

WINDOWS / DOORS:
ALL GLAZING TO COMPLY WITH AS1288.
WINDOW MANUFACTURER TO PROVIDE SPECIFICATIONS PRIOR TO INSTALLATION FOR BUILDING SURVEYOR.

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No. OF

EMPLOYEES each building

FEMALES:

4 0

ALL WINDOWS TO BE ALUMINIUM FRAMED "COMMERCIAL" TYPE SECTIONS POWDER COATED TO OWNERS SELECTION. FABRICATOE TO PROVIDE ALL ANGLES & COVER PLATES IN SAME COLOUR.

ALL EXIT DOORS TO BE OPENABLE FROM THE INSIDE WITHOUT THE USE OF A KEY BY A SINGLE HANDED ACTION.

FIGURED DIMENSIONS TO TAKE PRECEDENCE OVER SCALED DIMENSIONS

PROPOSED: WAREHOUSE/OFFICE
DEVELOPMENT
AT: LOT 20 DOHERTYS ROAD
TRUGANINA
FOR: KMERCIAL P/L PROJECT: ROAD

DRAWING TITLE

ANDREWS COMPLETE
DRAFTING SERVICE
ANDREW FARRUGIA
Ph/fax: 9 421 3655
Mobile: 0414 543 702
Email:acds@linet.net.au

ARCHITECTURAL

THESE DRAWINGS ARE TO BE READ IN CONJUNCTION WITH RELEVANT STRUCTURAL DRAWINGS, ROOF TRUSS MANUFACTURER AND RELEVANT DOCUMENTATION.

BUILDER TO VERIFY ALL DIMENSIONS, LEVELS & SOIL CLASSIFICATION PRIOR TO COMMENCING ANY WORK.

4 OF 7

DRAWN:

A.FARRUGIA

16016F

SCALE:

1:200@A1


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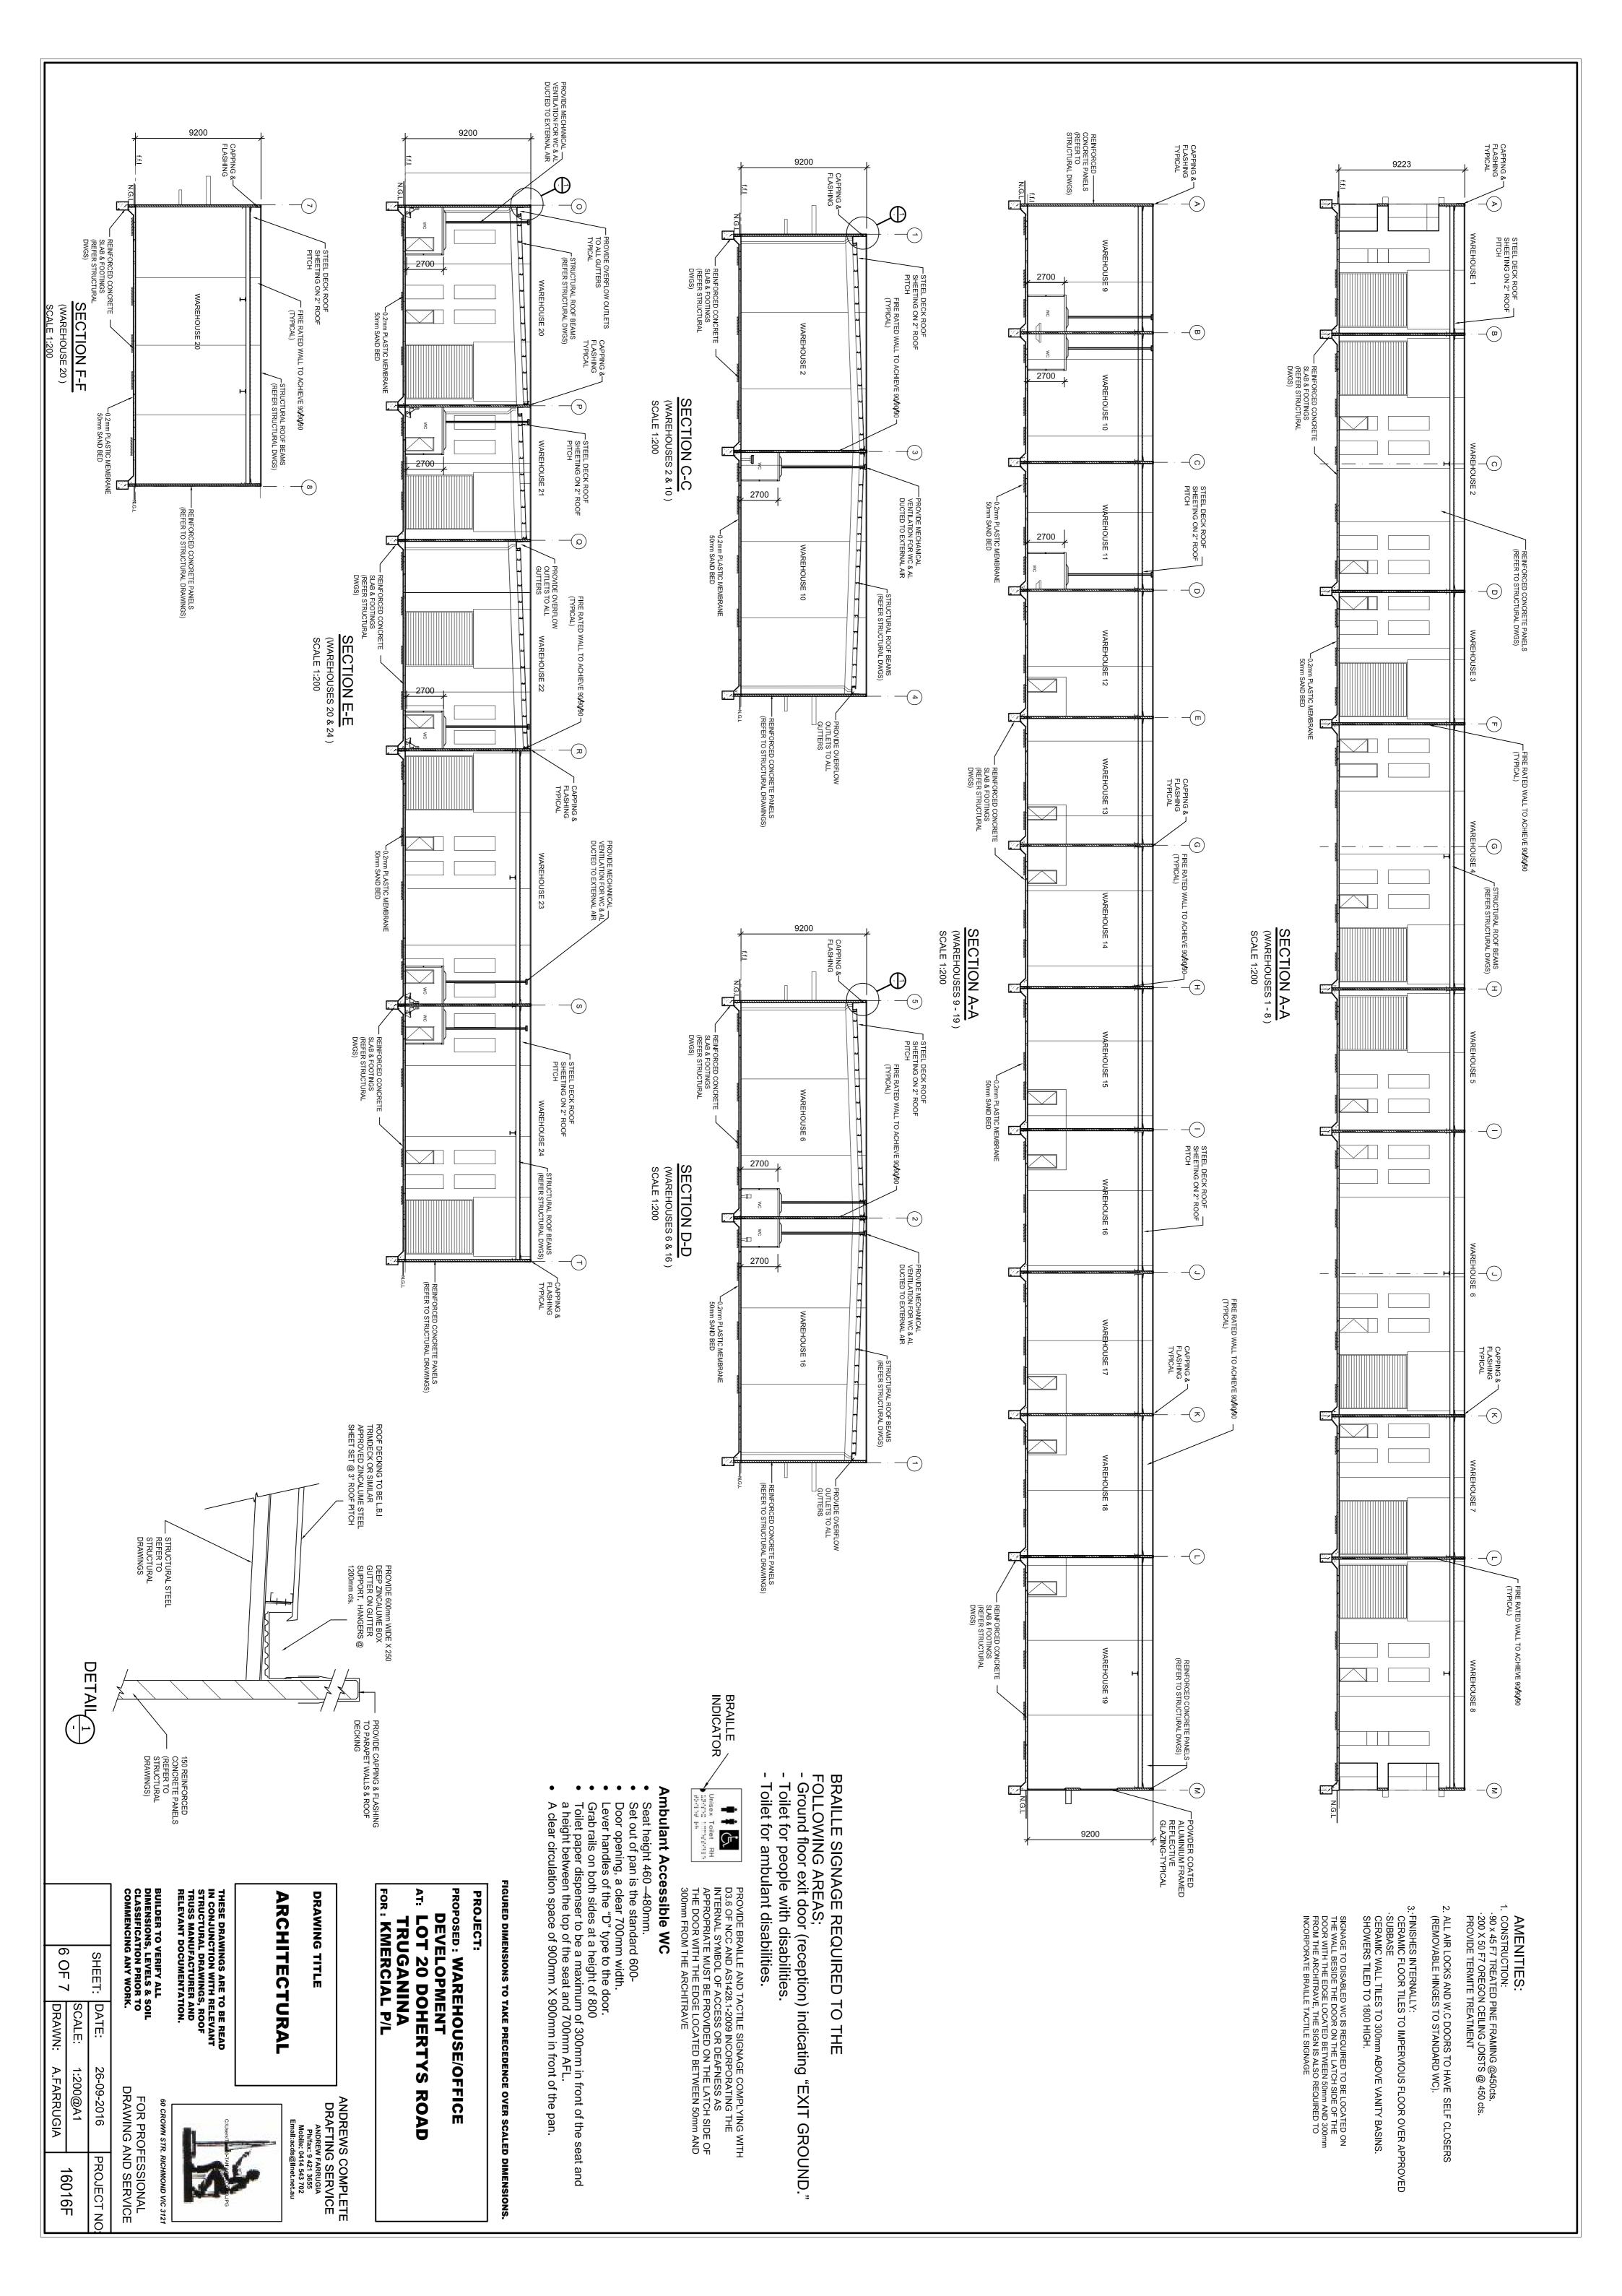
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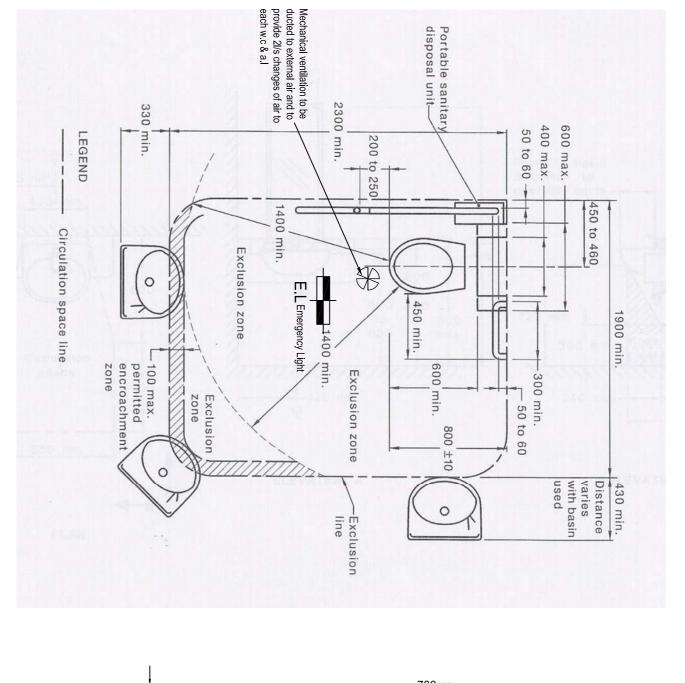
26-09-2016

PROJECT NO

FOR PROFESSIONAL DRAWING AND SERVICE





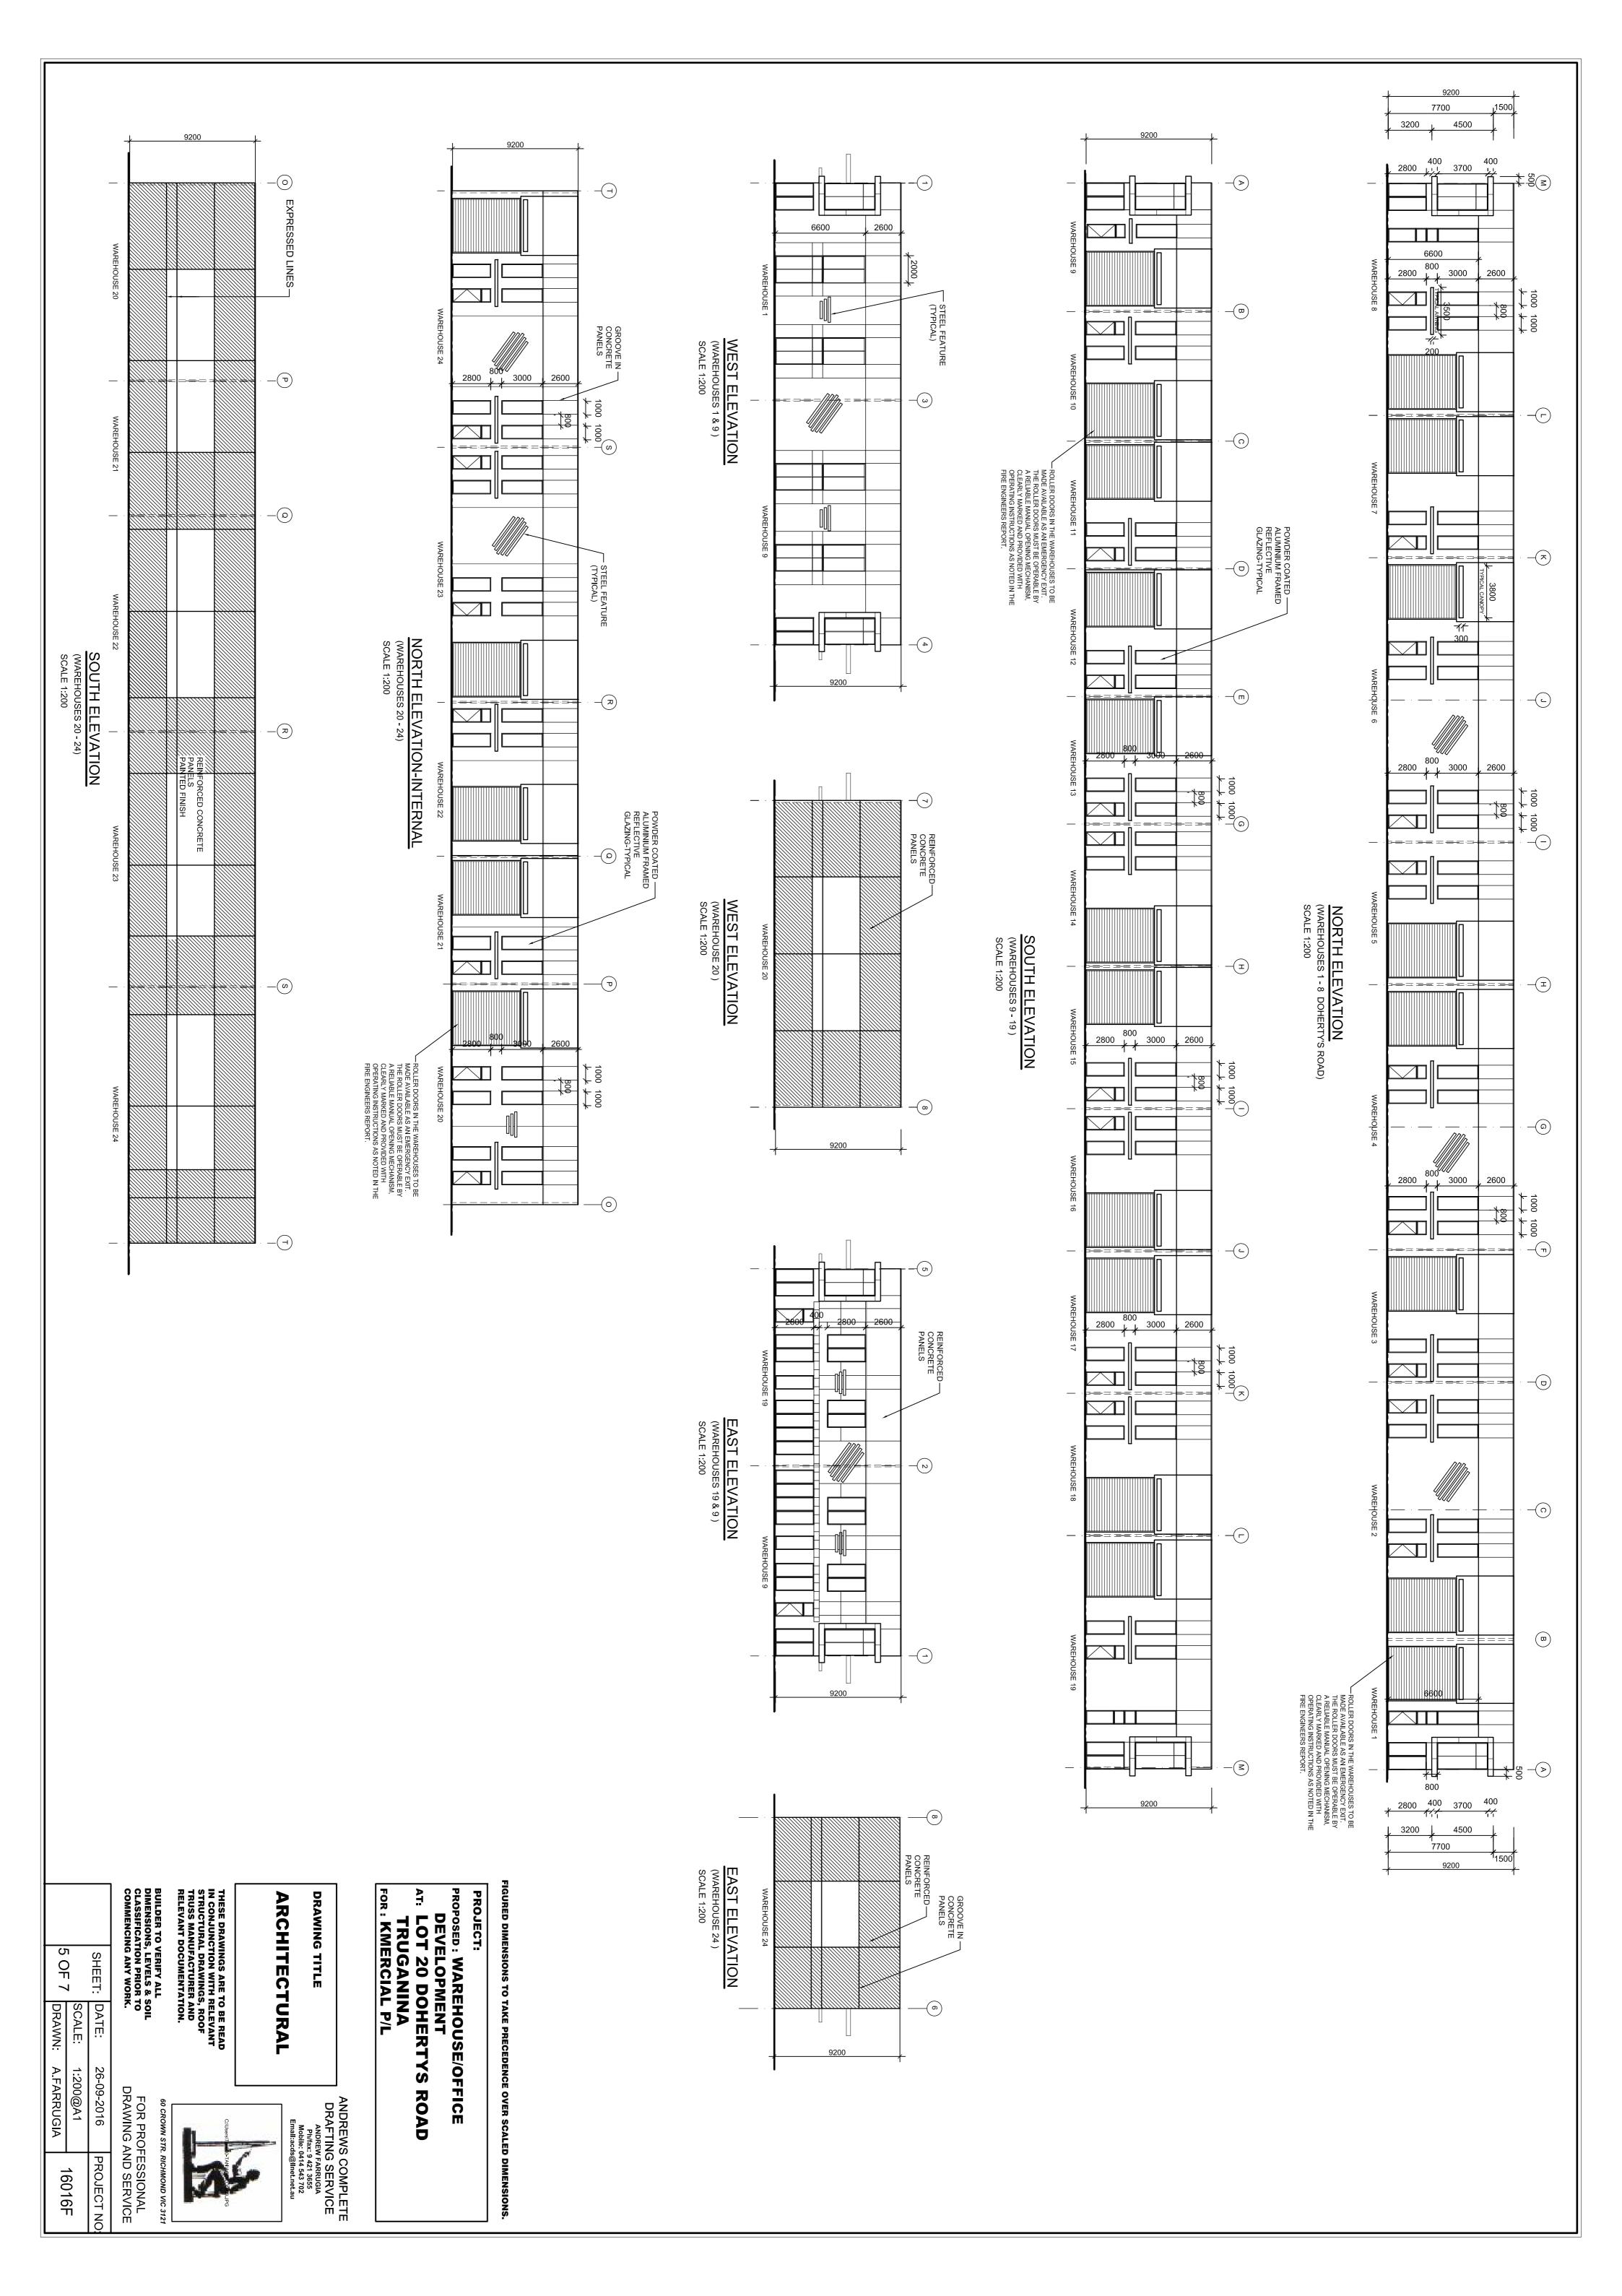

CIRCULATION SPACE IN DIS.WC's

DISABLED: BLED PERSONS AMENTIES TO PLY FULLY WITH A.S. 1428.1 - 2009

. DOORWAYS ALONG AN ACCESSIBLE PATH OF TRAVEL SHALL /E A MIN CLEAR OPENING OF 850mm -2009
LATCH SIDE CLEARANCECES NEED TO BE A MINIMUM OF CLEAR AND LEGIBLE BRAILLE AND TACTILE SIGNAGE TO ACH SANITARY FACILITY.SIGNAGE IS TO BE PLACED 200mm AND 1600mm ABOVE FLOOR LEVEL IN ACCORDANCE D3.6 OF BCA & AS1428.1-2009 COMPLY WITH

GNAGE TO DISABLED WC IS REQUIRED TO BE ATED ON THE WALL BESIDE THE DOOR ON LATCH SIDE OF THE DOOR WITH THE EDGE ATED BETWEEN 50mm AND 300mm FROM THE HITRAVE, THE SIGN IS ALSO REQUIRED TO SPPORATE BRAILLE TACTILE SIGNAGE

DISABLED WC NOTES: All fixtures and fittings to comply with S1428.1:2009 requirements. WC fittings to include: Seat height 460-480mm with closed ont, and buffers to prevent

810 810

460

WC paper dispenser within 300mm front of pan and maximum height leways movement;
Seat load capacity rated to 150kg;
Seat to have a 30% luminance
ntrast with the background;
3ackrest to be provided with a width
350-400mm and 150-200mm high,
detailed in AS1428.1:2009m Fig.

BECTION

900 to

ard projector WC

of front or punded front of 700mm;

- WC flush buttons to sit proud of WC grabrails to comply with S1428.1 Figure 42.
Taps to have lever handles or

Hot water to be delivered through a ntral mixing spout.

Mirrors, where provided, are to be rtical, 350mm minimum wide and sitioned at a height of no more an 900mm and extend up to a sight no less than 1850mm AFL. handles or sensor

land dryers, soap and towel
ensers' operable parts to be 9000mm AFL and not less than
mm from an internal corner.
Nothes hanging hook to be 12000mm AFL and not less than
mm from an internal corner.

ຼວດ beside basin as ນຸກ 300-400mm wide

separate fixture 300-400 x120-)mm wide at a height of 900-)0mm AFL if positioned within a ulation space nm minimum length x120mm num wide at a height of

Signage to designated car spaces to be in accordance with AS2890.6:2009.
 Maximum crossfall to designated car spaces to not exceed 1:33 (for asphalt) or 1:40 (for concrete) in both directions.
 Crossfall on all paths of travel, ramps and walkways to be 1:40 maximum. Surfaces to be slip resistive. Minimum width of paths of travel to be
 Abutments between materials on paths of travel to have no lip or step greater than 5mm, and to be rounded or

nts between materials on paths of travel to have no lip or step greater than 5mm,

nd to be

Jevelled edge.

ording to AS1428.1 income of travel to have aper

rection of travel.

Ramp handrails and kerbrails to be provided in accordance with AS1428.1:2009.

External access stairs to be designed in accordance with AS1428.1:2009 with complying handrails both intrast nosing to treads.

Stairs to be constructed according to AS1428.1:2009 requirements for handrails and contrast nosings who is accordance indicators to be provided to stairs used by the public (excluding Fire Stairs), kerbara is accordance with

sides and

be constructed according to AS1428.1:2009 requirements for handrails and contraground surface indicators to be provided to stairs used by the public (excluding Fire secordance with

actile ground surface indicators to be provided where a pedestrian path intersects with a the roadway.

andings to Entry Doors to have a maximum crossfall of 1:40. Landing dimensions as per

AS1428.1:2009.

STANDARD ACCESS NOTES:


AMBULANT


ACCESSIBLE


SC

700max 50 to 60 POSITION OF GRABRAIL NOTE: DISABLED PERSONS AMENTIES TO COMPLY FULLY WITH A.S. 1428.1 - 2009. to 105 800 ± 10


POSITION OF **GRABRAIL**

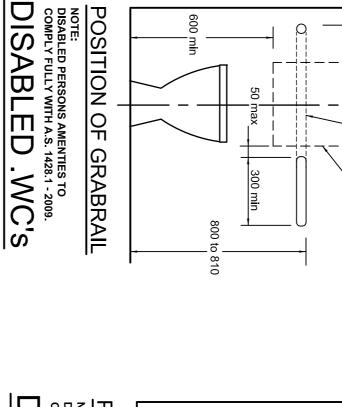


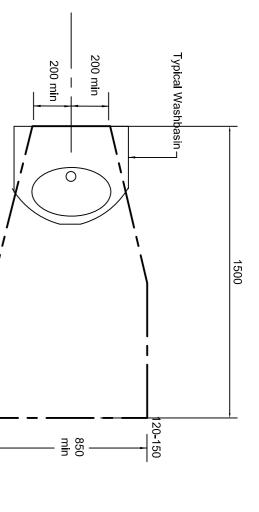


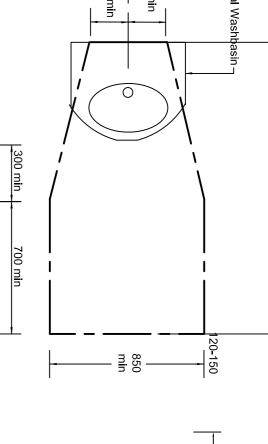

800-810

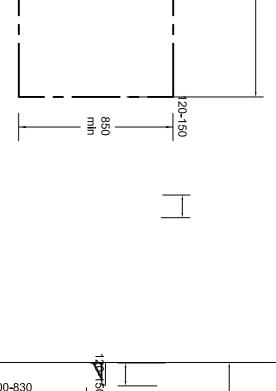

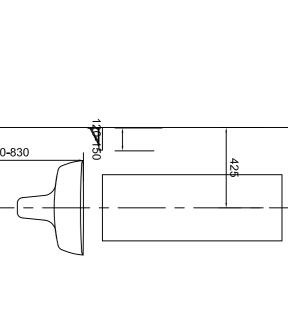

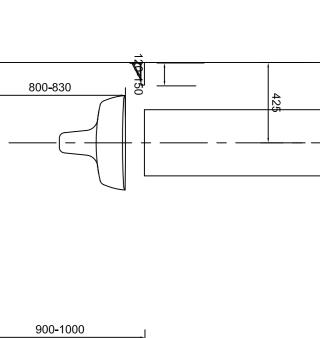

CIRCULATION SPACE OF HAND BASIN NOTE: DISABLED PERSONS AMENTIES TO COMPLY FULLY WITH A.S. 1428.1 - 2009.

CIRCULATION SPACE OF HAND BASIN

of the tread the difference in height is to be no greater than 5mm and be bevelled or rounded.

- Handrails are to extend 300mm horizontally at the top, and extend one tread width inclined + 300mm horizontally at the bottom, as measured past top/bottom stair

riser;
- If the nosing strip is fixed to surface

800-830

- Opaque risers;
- Riser to be in line with nose edge, and be vertical or splay backwards up to a maximum of 25mm;
- Stair nosing profile to be a sharp transition, rounded with a 5mm radius, or chamfered up to 5 x 5mm;
- Stair nosing strip to be 50-75mm wide with 30% luminance contrast across the full width of the step;
- Stair nosing strip to be no more than 15mm back from the nosing;
- Stair nosing is not to extend down the riser by more than 10mm, and is not to project beyond the face of the riser:

STAIRSNOTES:


Internal stairs are to be set back 400mm from an intersection with a corridor so the handrails do not protrude into the transverse path of


travel.


□All stairs (except for a Fire Isolated Stair) to comply with AS1428.1:2009


LEVER HANDLES MUST NOT BE LESS ADJACENT SURFACE

DISABLED .WC's

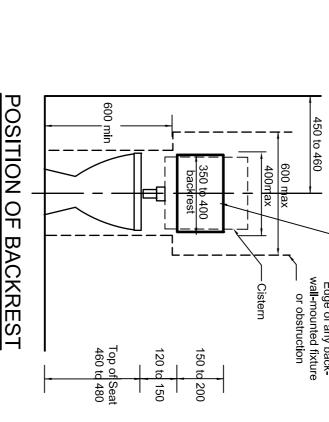


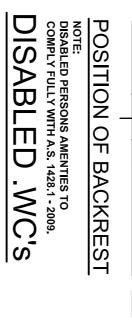

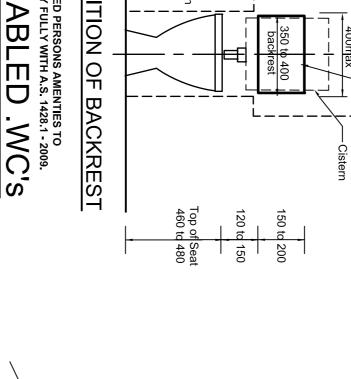

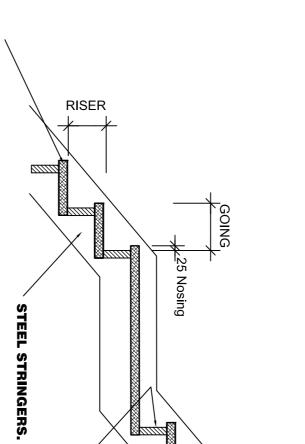




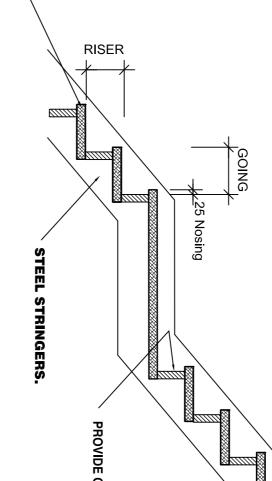


INTERNAL

STAIRWAY TO OFFICES TO HAVE A CLEAR UNOBSTRUCTED WIDTH THROUGHOUT OF 1000 mm MEASURED INSIDE HANDRAILS AND A CLEAR HEAD HEIGHT OF 2 meters



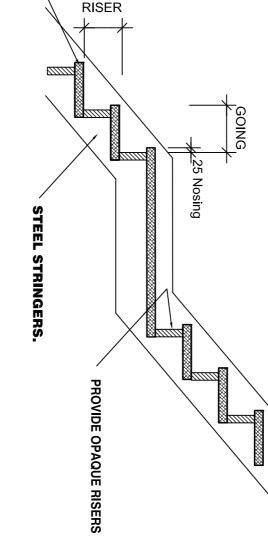



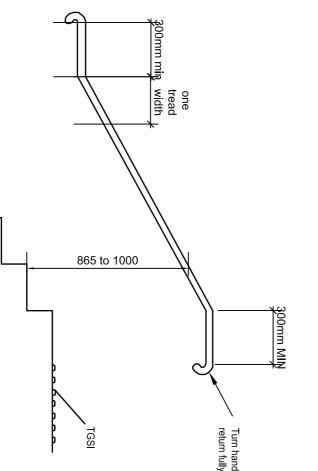

Seat height 460–480mm.
Set out of pan is the standard 600-660mm.
Door opening, a clear 700mm width.
Lever handles of the "D" type to the door.
Grab rails on both sides at a height of 800
Toilet paper dispenser to be a maximum of 300mm in front of the sea a height between the top of the seat and 700mm AFL.
And a reinculation space of 900mm X 900mm in front of the pan.

Ambulant Accessible WC

900 to 920



STAIRSNOTES:

Handrail fixings are not to intrude into the top 270° of the rail to allow free passage of the hand;
Handrails to be provided on both sides of the stair;
Handrails to be circular or elliptical with a 30mm minimum and 50mm

iosing; Handrails to be 865-1000mm above stair nosings;

The top and bottom step shall not encroach into circulation spaces.
Stairs should not have open risers or treads extending out past the line of the riser.
A contrasting solid strip with a minimum luminance contrast of at least 30% compared to the tread with a width of between 50-75mm in depth across the full width of the tread at the nosing.
The nosing may extend down the front of the riser by a maximum of 10mm or be set back a maximum of 15mm from the front of the nosing,

- with AS1428.4.1- 2009.

 The TGSIs shall be the "Warning Indicators" and shall be installed for the full width of the stairway, perpendicular to the angle of approach.

 They must be set back 300+/40mm from the edge of the nosing on the top step and from the riser on the bottom step.

 As the approach is from an open area the depth of the TGSIs must have a minimum of 12 truncated cones perpendicular to the path of travel.

 The minimum luminance contrast criteria must be applied to the TGSIs compared to the surrounding floor surface.

 Install handrails onboth sidesof the stairs of a tubular type construction that has a diameter of between 30-50mm or elliptical as per the following floures.

□Stair tread and riser dimensions to be in accordance with AS1428.2, ie 150-165mm for risers and 275-300mm for

le indicators required in bliance with AS1428.4.1:2009 ..

ner handrails are not required to end 300mm horizontally at rmediate landings where the rail

ו a 30mm minimum and 50mm dimum diameter; andrails to be continuous, as far as

- Ninimum clearance behind the handrail is to be 50mm. Insure that the fixings do not encroach into the top 270° arc and that there a 15mm clearance below the 270° for the full length of the handrail. There must be clearance above the handrail of a minimum of 600mm for its all length.

- Depth of 600-800mm;
- Across the full width of the steps;
- Not required on enclosed mid-landing where the handrails are continuous and the landing depth does not exceed 3000mm;
- 30% luminance


- design shall allow for the handrail to extend out over the top and om of the gradient by 300+/10mm and return back on itself, to the wall
- he handrail at the bottom of the stairway must extend out the width of one ead plus 300mm in a horizontal direction. he return shall not intrude into any trafficable area. he handrail is to have a minimum luminance contrast of 30% to its

- 30% luminance contrast for solid indicators (integrated TGSIs) when compared with the adjacent flooring surface. 45% luminance contrast required for individual (discrete) TGSIs, and 60% for two-tone (composite discrete) TGSIs;
- Installed where the height of stair soffit is reduced to less than 2000mm and no other

- STAIRWAY TO BE AS1428.1-2009 COMPLIANT 1000 WIDE MEASURED IN BETWEEN HANDRAILS. HANDRAILS REQUIRED BOTH SIDES OF STAIRWAY
- TACTILE INDICATORS TO TOP AND BOTTOM OF STAIRCASE TO AS1428.4.-1992

- STAIRWAY TO OFFICES TO HAVE A CLEAR UNOBSTRUCTED WIDTH THROUGHOUT OF 1000 mm MEASURED INSIDE HANDRAILS AND A CLEAR HEAD HEIGHT OF 2 meters

STAIRWAY HANDRAIL LOCATION AND EXTENSIONS AT END OF STAIRWAY DETAIL

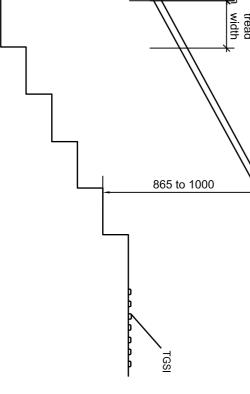


PROVIDE NON-SLIP FINITIMBER STAIRS AND LAI SH TO NDINGS.

4. TREAD RISER REQUIREMENTS GOING- 250min 355 max. RISER - 115min 190 max. ALL GOING & RISER HEIGHTS MUST REMAIN CONSTANT.

HANDRAILS TO BE AT A MINIMUM HEIGHT OF 865mm ABOVE TREAD NOSING AND 1000mm ABOVE LANDINGS.

IF UNDERSIDE OF STAIRS IS USED FOR STORAGE PROVIDE FIRE RATED PLASTER (60 /60 / 60) TO UNDERSIDE AND SUPPORTING WALLS.

NOTES: PROVIDE OPAQUE RISERS

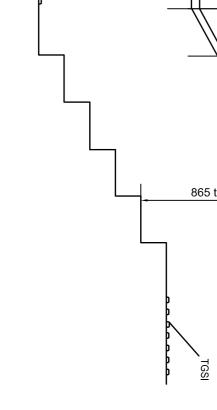

FIGURED DIMENSIONS TO TAKE PRECEDENCE OVER SCALED DIMENSIONS. PROJECT:

PROPOSED: WAREHOUSE/OFFICE
DEVELOPMENT
AT: LOT 20 DOHERTYS ROAD
TRUGANINA
FOR: KMERCIAL P/L ROAD

ARCHITECTURAL ANDREWS COMPLETE
DRAFTING SERVICE
ANDREW FARRUGIA
Ph/fax: 9 421 3655
Mobile: 0414 543 702
Email:acds@linet.net.au

DRAWING TITLE

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SHEET:

DATE:

OF 7

DRAWN:

A.FARRUGIA

16016F

SCALE:

1:200@A1



FOR PROFESSIONAL DRAWING AND SERVICE

26-09-2016 PROJECT NO