ERMIT POINT **BUILDING ONSULTANTS** PTY LTD

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PROPOSED WAREHOUSE & OFFICE DEVELOPMENT AT: LOT 11 HARRISON COURT, MELTON



Harrison Court Streetscape Elevation

GENERAL NOTES:

REGULATIONS 2017. THE NATIONAL CONSTRUCTION CODE SERIES 2016 BUILDING CODE OF AUSTRALIA VOLUME 1 AND

FOR CLARIFICATION. FIGURED DIMENSIONS TAKE PRECEDENCE OVER SCALED DIMENSIONS

THE BUILDER AND SUBCONTRACTOR SHALL ENSURE THAT ALL STORM WATER DRAINS, SEWER PIPES AND THE LIKE ARE LOCATED AT A SUFFICIENT DISTANCE FROM ANY BUILDINGS FOOTING AND/OR SLAB EDGE BEAMS SO AS TO PREVENT GENERAL MOISTURE PENETRATION, DAMPNESS, WEAKENING AND UNDERMINING OF ANY BUILDING AND ITS FOOTING SYSTEM.

THE BUILDER SHALL TAKE ALL STEPS NECESSARY TO ENSURE THE STABILITY AND GENERAL WATER TIGHTNESS OF ALL NEW AND/OR EXISTING STRUCTURES DURING ALL WORKS

ALL STORM WATER TO BE TAKEN TO THE LEGAL POINT OF DISCHARGE TO THE RELEVANT AUTHORITIES' APPROVAL. INSTALLATION OF ALL SERVICES SHALL COMPLY WITH THE RESPECTIVE SUPPLY AUTHORITY REQUIREMENTS. THESE DRAWINGS SHALL BE READ IN CONJUNCTION WITH ALL ARCHITECTURAL SPECIFICATIONS, RELEVANT STRUCTURAL AND ALL OTHER CONSULTANTS' DRAWINGS/DETAILS AND SPECIFICATIONS AND WITH ANY OTHER WRITTEN INSTRUCTIONS ISSUED IN THE COURSE OF THE CONTRACT.

LIGHT SWITCHES, DOOR HANDLES ETC. TO ALL DOORS/WALLS TO BE LOCATED BETWEEN 900MM AND 1100MM ABOVE F.F.L.

ALL WET AREAS, FLOOR, WALLS ETC., TO BE IN

SARKING-TYPE MATERIALS USED FOR WEATHERPROOFING OF ROOFS AND WALLS TO COMPLY WITH AS/NZS 4200 PARTS 1 AND 2.

ACCORDANCE WITH F1.7 OF B.C.A. AND AS 3740. ALL MATERIALS AND CONSTRUCTION PRACTICE SHALL MEET THE PERFORMANCE REQUIREMENTS OF THE BUILDING CODE OF AUSTRALIA. WHERE A PERFORMANCE SOLUTION IS PROPOSED THEN PRIOR TO IMPLEMENTATION OR INSTALLATION IT FIRST MUST BE ASSESSED AND APPROVED BY THE RELEVANT BUILDING SURVEYOR AS MEETING THE PERFORMANCE REQUIREMENTS OF THE BUILDING CODE OF AUSTRALIA.

WINDOW SIZES NOMINATED ARE NOMINAL ONLY. ACTUAL SIZE MAY VARY ACCORDING TO MANUFACTURER. WINDOWS TO BE FLASHED ALL AROUND.

REFER TO CIVIL ENGINEERS DESIGN AND DETAILS FOR ALL STORM WATER, CAR PARKING AND DRIVEWAY CONSTRUCTION REQUIREMENTS.

THESE PLANS HAVE BEEN PREPARED FOR THE EXCLUSIVE USE BY THE CLIENT OF BB DESIGN GROUP FOR THE PURPOSE EXPRESSLY NOTIFIED TO THE DESIGNER. ANY OTHER PERSON WHO USES OR RELIES ON THESE PLANS WITHOUT THE WRITTEN CONSENT OF BB DESIGN GROUP DOES SO AT THEIR OWN RISK AND NO RESPONSIBILITY IS ACCEPTED BY BB DESIGN GROUP FOR SUCH USE AND/OR

RELIANCE. THE CLIENT AND/OR THE CLIENT'S BUILDER SHALL NOT MODIFY OR AMEND THE PLANS WITHOUT THE KNOWLEDGE AND CONSENT OF BB DESIGN GROUP EXCEPT WHERE A REGISTERED BUILDING SURVEYOR MAKES MINOR NECESSARY CHANGES TO FACILITATE THE BUILDING PERMIT APPLICATION AND THAT SUCH CHANGES ARE PROMPTLY REPORTED BACK TO BB DESIGN GROUP.

FIRE HAZARD PROPERTIES:

ALL FLOOR MATERIAL OR FLOOR COVERING MUST HAVE (a) A CRITICAL RADIANT FLUX NOT LESS THAN THAT LISTED

COMPLYING WITH SPECIFICATION E1.5, A MAXIMUM SMOKE DEVELOPMENT RATE OF 750 PERCENT-MINUTES. THE MINIMUM TYPE OF FIRE RESISTING CONSTRUCTION OF A BUILDING MUST BE THAT SPECIFIED IN TABLE C1.1 AND

SPECIDFICATION C1.1. CONSTRUCTION JOINTS BETWEEN CONCRETE PANELS TO BE FIRE SEALS AS NECESSARY, IN ACCORDANCE WITH AS 1530.4

EARLY FIRE HAZARD INDICES:

SMOKE DEVELOPED: SPREAD OF FLAME: CARPET (0- 10) **SARKING (0-10)** VINYL FLOORING (0- 10) 6 FIRE HAZARD PROPERTIES OF MATERIALS AND ASSEMBLIES

TO COMPLY WITH BCA SPECIFICATION C1.10. CONSTRUCTION JOINTS BETWEEN CONCRETE PANELS TO BE FIRE SEALS AS NECESSARY, IN ACCORDANCE WITH AS 1530.4

FIRE SERVICE LEGEND

REFER TO FIRE SERVICES DESIGN FOR ALL HYDRANT, HOSE REELS AND EXTINGUISHER DETAILS.

ELECTRICAL SWITCHBOARDS LOCATED IN THE PATH OF TRAVEL TO EXITS TO BE ENCLOSED IN A METAL OR OTHER NON COMBUSTIBLE CABINET WITH SMOKE PROOF DOORS. SIGNIFICANT SWITCHBOARDS SHALL BE PROVIDED WITH A 5KG CARBON DIOXIDE EXTINGUISHER OR ANOTHER TYPE OF EXTINGUISHER WITH A MINIMUM CLASSIFICATION OF 1A:E AND FITTED WITH A HOSE COMPLETE WITH EXTINGUISHER IDENTIFICATION SIGNAGE AND SHALL BE LOCATED BETWEEN 2M AND 20M FROM THE SIGNIFICANT

PROVIDE ONE DRY POWDER EXTINGUISHER ADJACENT TO THE MAIN SWITCHBOARD.

REQUIRED HOSE REEL (36m HOSE),

LOCATED WITHIN 4m OF EXIT DOOR. DURING CONSTRUCTION, NOT LESS THAN ONE FIRE EXTINGUISHER TO SUIT CLASS A, B, AND C FIRES AND ELECTRICAL FIRES MUST BE PROVIDED AT ALL TIMES ON EACH STOREY ADJACENT TO EACH REQUIRED EXIT OR

SWITCHBOARD.

ALL EXIT DOORS & DOORS IN A PATH OF TRAVEL TO EXITS ARE TO BE CAPABLE OF BEING OPENED AT ALL TIMES FROM THE SIDE OF PERSON SEEKING EGRESS FROM THE BUILDING WITH A SINGLE HANDED DOWNWARD OR PUSHING ACTION ON A SINGLE DEVICES WITHOUT THE USE OF A KEY & LOCATED BETWEEN 900mm & 1200mm ABOVE FLOOR LEVEL IN ACCORDANCE WITH CLAUSE D2.21 OF THE BCA

ALL PROPOSED SLIDING DOORS SERVING AS EXIT DOORS TO OPEN AUTOMATICALLY IF THERE IS A POWER FAILURE TO THE DOOR OR ON ACTIVATION OF THE FIRE OR SMOKE ALARM ANYWHERE IN THE TENANCY.

DISABLED ACCESS:

TEMPORARY STAIRWAY OR EXIT.

DISABLED PERSON ACCESS TO THE BUILDING SHALL BE VIA ENTRANCE DOOR No: D01, AS DESIGNATED ON FLOOR PLAN. DISABLED ACCESS & MOBILITY SHALL FULLY COMPLY WITH AS.1428.1 & AS.1428.4

BRAILLE AND TACTILE SIGNAGE COMPLYING WITH SPEC. D3.6 AND INCORPERATING THE INTERNATIONAL SYMBOL OF ACCESS OR DEAFNESS OR OTHER SYMBOL AS APPROPRIATE MUST BE PROVIDED TO THE DISABLED SANITARY FACILITY.

LIGHTING LEGEND:

ALL EMERGENCY LIGHTING AND EXIT SIGNS TO COMPLY WITH AS 2293, AND B.C.A. 2016

DENOTES 'CLEVERTRONICS' 2 x 3 WATT LIFELIGHT LUMINAIRE NON MAINTAINED EMERGENCY LIGHT. CHAIN SUSPENDED 6000mm ABOVE FLOOR LEVEL TO UNDERSIDE

DENOTES 'CLEVERTRONICS' 1 x 1.9 WATT LIFELIGHT

OF ROOF PURLINS CAT NO.CLIFE-2PRO-SMS-600 (Co D125 34m, C90 D125 34m)

LUMINAIRE NON MAINTAINED EMERGENCY LIGHT RECESSED MOUNTED 2700mm ABOVE FLOOR LEVEL TO UNDERSIDE OF SUSPENDED CEILING

CAT NO. ELIFE-X (Co-D40 18M, C90-D40 18M) DENOTES HIGH EFFICIENCY HI BAY LIGHTING IN ACCORDANCE WITH PART J6. 1-6.6 OF THE BCA AND THE

SPECIFICATION J6 DENOTES "CLEVERTRONICS" 1 x 3.3w MAINTAINED EXIT EMERGENCY SIGN MOUNTED ABOVE ALL EXIT DOOR OPENINGS BETWEEN 2100-2400mm HIGH

GLAZING NOTES:

CAT. No. CCFPRO (Co-D4; C90-E8)

MAXIMUM AREAS OF CLEAR PATTENED GRADE 'A' FRAMED GLASS SIDE PANELS AND OTHER GLAZED SAFETY GLASS MATERIAL FOR FRAMED GLASS, GLAZING AS PER AS.1288 AND AS.2047

TYPE OF GLASS THICKNESS AREA. TOUGHENED SAFETY 2.0sqm 3.0sqm GLASS. 4.0sqm 6.0sqm 8.0sqm LAMINATED SAFETY 5.38mm 3.38mm

MECHANICAL VENTILATION SCHEDULE:

8.38mm

12.38mm

3.0sqm

PROPOSED WAREHOUSE 1:

FLOOR AREA = 348.88m² @ 5% $= 17.44 \text{m}^2$ EXISTING VENTILATION (OPENINGS) = 24.25m² BALANCE REQUIRED $= 00.00 \text{m}^2$

PROPOSED WAREHOUSE 2:

FLOOR AREA = 393.67m² @ 5% EXISTING VENTILATION (OPENINGS) = 24.25m² BALANCE REQUIRED

PROPOSED WAREHOUSE 3:

FLOOR AREA = 415.60m² @ 5% = 17.44m² EXISTING VENTILATION (OPENINGS) = 24.25m² BALANCE REQUIRED

DENOTES PROPOSED EXHAUST FAN

MECHANICAL VENTILATION OR AIR-CONDITIONING OF ROOMS TO BE PROVIDED WITH A SYSTEM COMPLYING WITH AS1668.2 AND AS/NZS 3666.1 AS AMENDED. EXHAUST OUTLETS TO BE LOCATED NO CLOSER THAN 6.0M TO FRESH AIR INLETS. AIR CONDITIONING TO BE PROVIDED TO OFFICE. MECHANICAL VENTILATION TO BE PROVIDED TO WC AND AIR LOCK AREAS. (BY OTHERS)

DIRECTIONAL SIGNAGE NOTES:

Where directional signage is provided consistant colour and layout to assist people find & use the signage

Matt finishes shall be used to assist people with vision impairment.

Colours with high luminance contrast are to be used.

Standardized symbols to be used where possible to reinforce written

Sans Serif font to be used.

EMERGENCY SERVICES NOTES:

All emergency services and warning systems to be in accordance with BCA requirements.

All lighting levels are to comply with AS1428.1 CLAUSE 17.1 and be consistant with AS1680.0 to provide for safe movement within the

GENERAL CONSTRUCTION NOTES:

Light switches to be located between 900mm - 1100mm above FL, horizontally aligned with door handles and not less than 500mm from internal corners.

Carpet to have a max. pile height of 6mm.

Vinyl flooring if proposed to be slip resistive comply with AS1428.1:2009 Clause 7.

ACCESSIBLE SIGNAGE:

Acessible signage to be provided adjacent to each required exit door.

Braille and tactile components of a sign must be located not less than 1200mm and not higher than 1600mm above the floor or ground surface.

Signs with single lines of characters must have the line of tactile characters not less than 1250mm and not higher than 1350mm above the ground or floor

Each sign must indicate the word "Exit" and description of the Level. (Refer Example Below)



DISABLED STANDARD NOTES:

Signage to designated car spaces to be in accord. with AS 1428.1 and 2890.6

Maximum cross-fall to designated car spaces for persons with disabilities not to exceed 1:40 in both directions.

Drainage grates not to be in path of travel b/w designated car space for persons with disabilities and any paths to entry doors.

Provide level transition b/w car space and landing to entry doors.

If any door closers are fitted to any door requiring accessibility, then the force to open not to exceed 20N.

Disabled amenity room size and internal fit-out to comply with AS 1428.1:2009.

Cross-fall on designated car spaces, paths and level landings at entry

All door circulation spaces & disabled amenities to comply with AS1428.1:2009.

All Pavement pathways are to be flush with roadways and parking areas with otherwise disabled compliant kerb ramps are to be

All entry & internal doors to provide minimum 850mm clear opening.

Provide level threshold at entry oor/landing junction and maximum fall

All joinery fitout to be by tenant.

doors not to exceed 1:40.

All Doors & handles to comply with AS 1428.1:2009 and door frame to have 30% luminance contrast to the adjacent surface. Safety decals to door leaves, sidelights and any other areas which can be mistaken for openings. Min. solid non-transparent band no less than 75mm wide req. with the lower edge of the band to be 900-1000mm above FL.

Tactile indicators to footpaths either side of crossovers, as required by local

ALL PARKING BAYS TO BE LINE MARKED INCLUDING DISABLED AND ASSOCIATED SHARED AREA PAVEMENT MARKING.

PROJECT CONSULTANTS LIST

Consulting Structural Engineer: Matrix Consulting Engineers

Consulting Civil Engineer: Matrix Consulting Engineers Consulting Fire Service Design: PBH Design Solutions

Consulting Geotechnical Engineer: Melbourne Soil Test

Consulting Landscape Designer: Etched Projects

PROJECT AUTHORITIES LIST

Municipality: Melton City Council Planning Permit No: PA2014/4523

Issue Date: 14th January 2015 Sewerage Authority: Western Water

Drainage Authority: Melton City Council Relevant Building Surveyor: Permit Point

- | 16/03/2018 | PRELIMINARY ISSUE A 09/06/2018 PRELIMINARY ISSUE

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PROPOSED WAREHOUSE & OFFICE DEVELOPMENT


AT: LOT 11 HARRISON COURT **MELTON**

CARABOTT NOMINEES

DRAWING TITLE **GENERAL NOTES**



DRG NO. MAR 2018 N/A A00 CHECKED JOB NO. DRAWN 171208

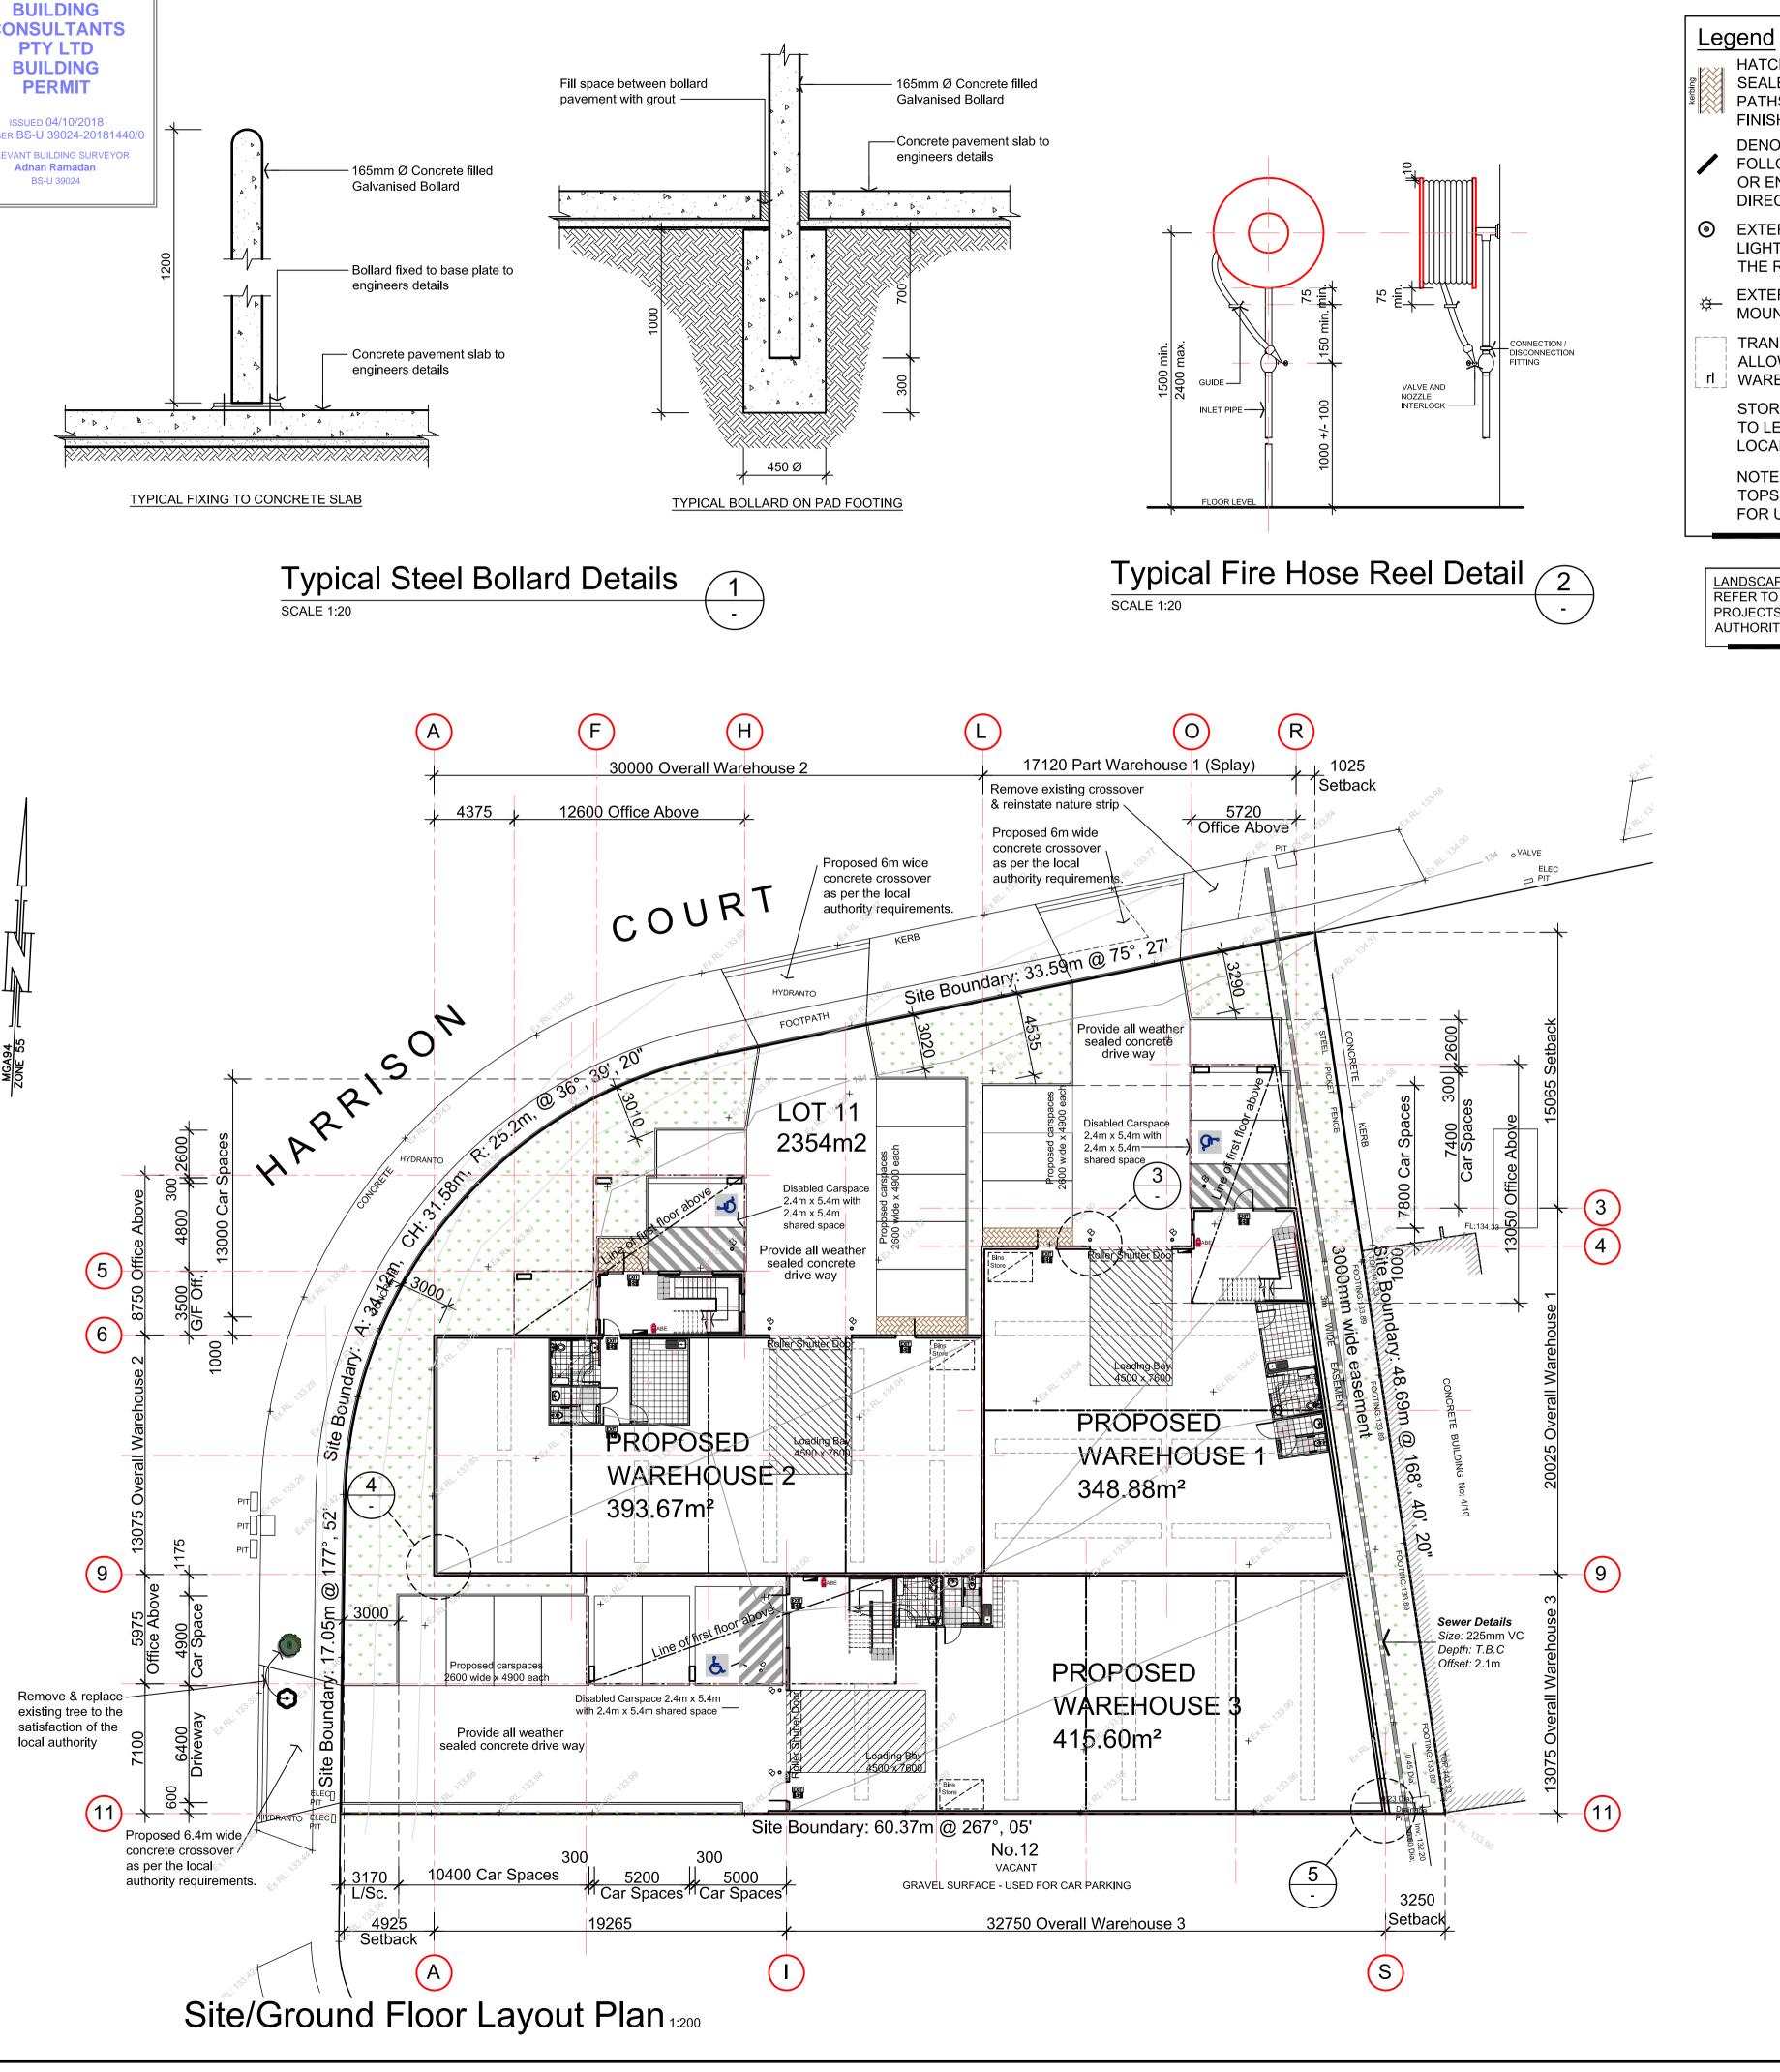

ERMIT POINT

HATCH DENOTES ALL WEATHER SEALED CONCRETE PATTERN PAVED PATHS WITH "CHARCOAL" COLOR FINISH AS SELECTED

- DENOTES SIGNAGE. SIGNAGE TO HAVE FOLLOWING:"ALL VEHICLES MUST EXIT OR ENTER IN A FORWARD FACING DIRECTION.
- EXTERNAL "PILLAR BAFFLED " LED LIGHTING TO THE SATISFACTION OF THE RESPONSIBLE AUTHORITY
 - EXTERNAL HIGH EFFICIENT WALL MOUNTED LED SECURITY LIGHTING
- TRANSLUCENT SHEET ROOFING TO ALLOW NATURAL LIGHT INTO rl | WAREHOUSE FLOOR AREA.

STORMWATER DRAINAGE TO CONNECT TO LEGAL POINT OF DISCHARGE TO LOCAL AUTHORITY REQUIREMENTS

NOTE: SITE TO BE SITESCAPED OF TOPSOIL AND STOCKPILED ON SITE FOR USE IN PLANTING AREAS.

AREA ANALYSIS:

TOTAL SITE AREA LOT 11 = 2,354.00 SQ METERS WAREHOUSE AREA = 1,158.12 SQ METERS OFFICE AREA (TOTAL) = 287.85 SQ METERS OVERALL DEVELOPMENT = 1,445.97 SQ METERS

= 61.42%

CARPARK ANALYSIS

SITE COVERAGE

WAREHOUSE: 1,158.12m2 (1,075.92 m2 net - minus loading bay 82.20m2)


OFFICE: 287.85 m2 (257.85m2 net - minus staircase 30.00m2)

TOTAL NET FLOOR AREA: 1333.77m2

CARSPACE REQUIRED WAREHOUSE/OFFICE: @ 2 + 1.5/100M2 TOTAL CARSPACE REQUIRED: 26 TOTAL CARSPACE PROVIDED: 20

REFER TO LANDSCAPE PLAN PREPARED BY ETCHED PROJECTS TO BE IN ACCORDANCE WITH LOCAL AUTHORITY VEGETATION REQUIREMENTS.

Prop. disabled carspace 2400 x 5400 each with 2400mm wide shared area. Detailed signage to be prov. in accordance with AS1428.1 / 2890.6 Disabled Carspace Detail Scale: N.T.S Landing 1500 min. from top of ramp surface indicators to any obstruction (TGSI's) 1330 clear , 1000 `─Kerb face Typical Kerb Ramp Detail Scale: N.T.S Tactile indicators in accordance with AS1428.4.1.2009 Refer to Manufacturers Specifications Tactile Indicator Plan Scale: 1:50 Proposed 2.1m high black steel picket fence where nominated on the plans Typical Front Fence Detail Scale: N.T.S

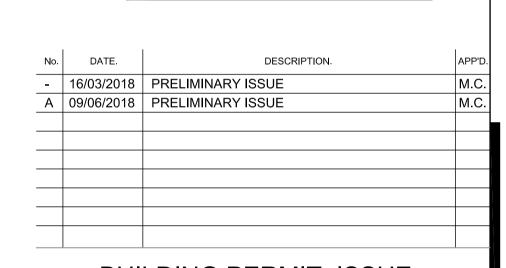


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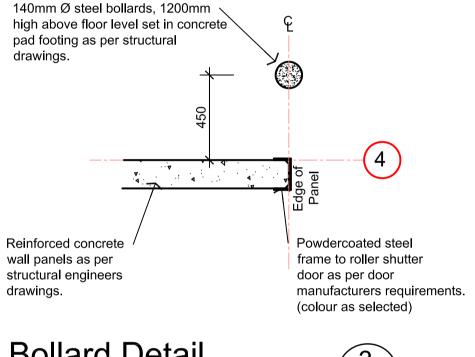
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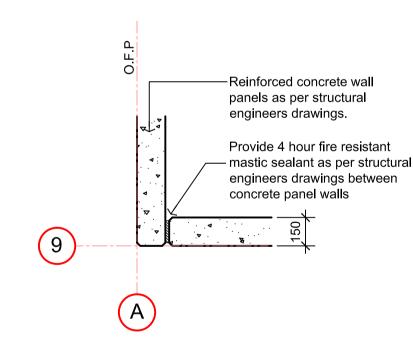
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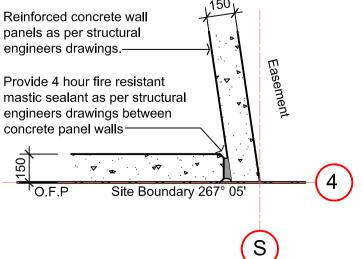



Bollard Detail SCALE 1:20


(TYPICAL TO ALL ROLLER DOOR OPENINGS)





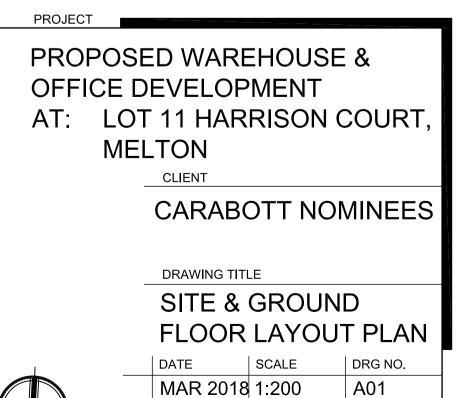

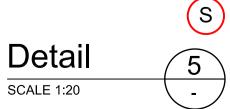

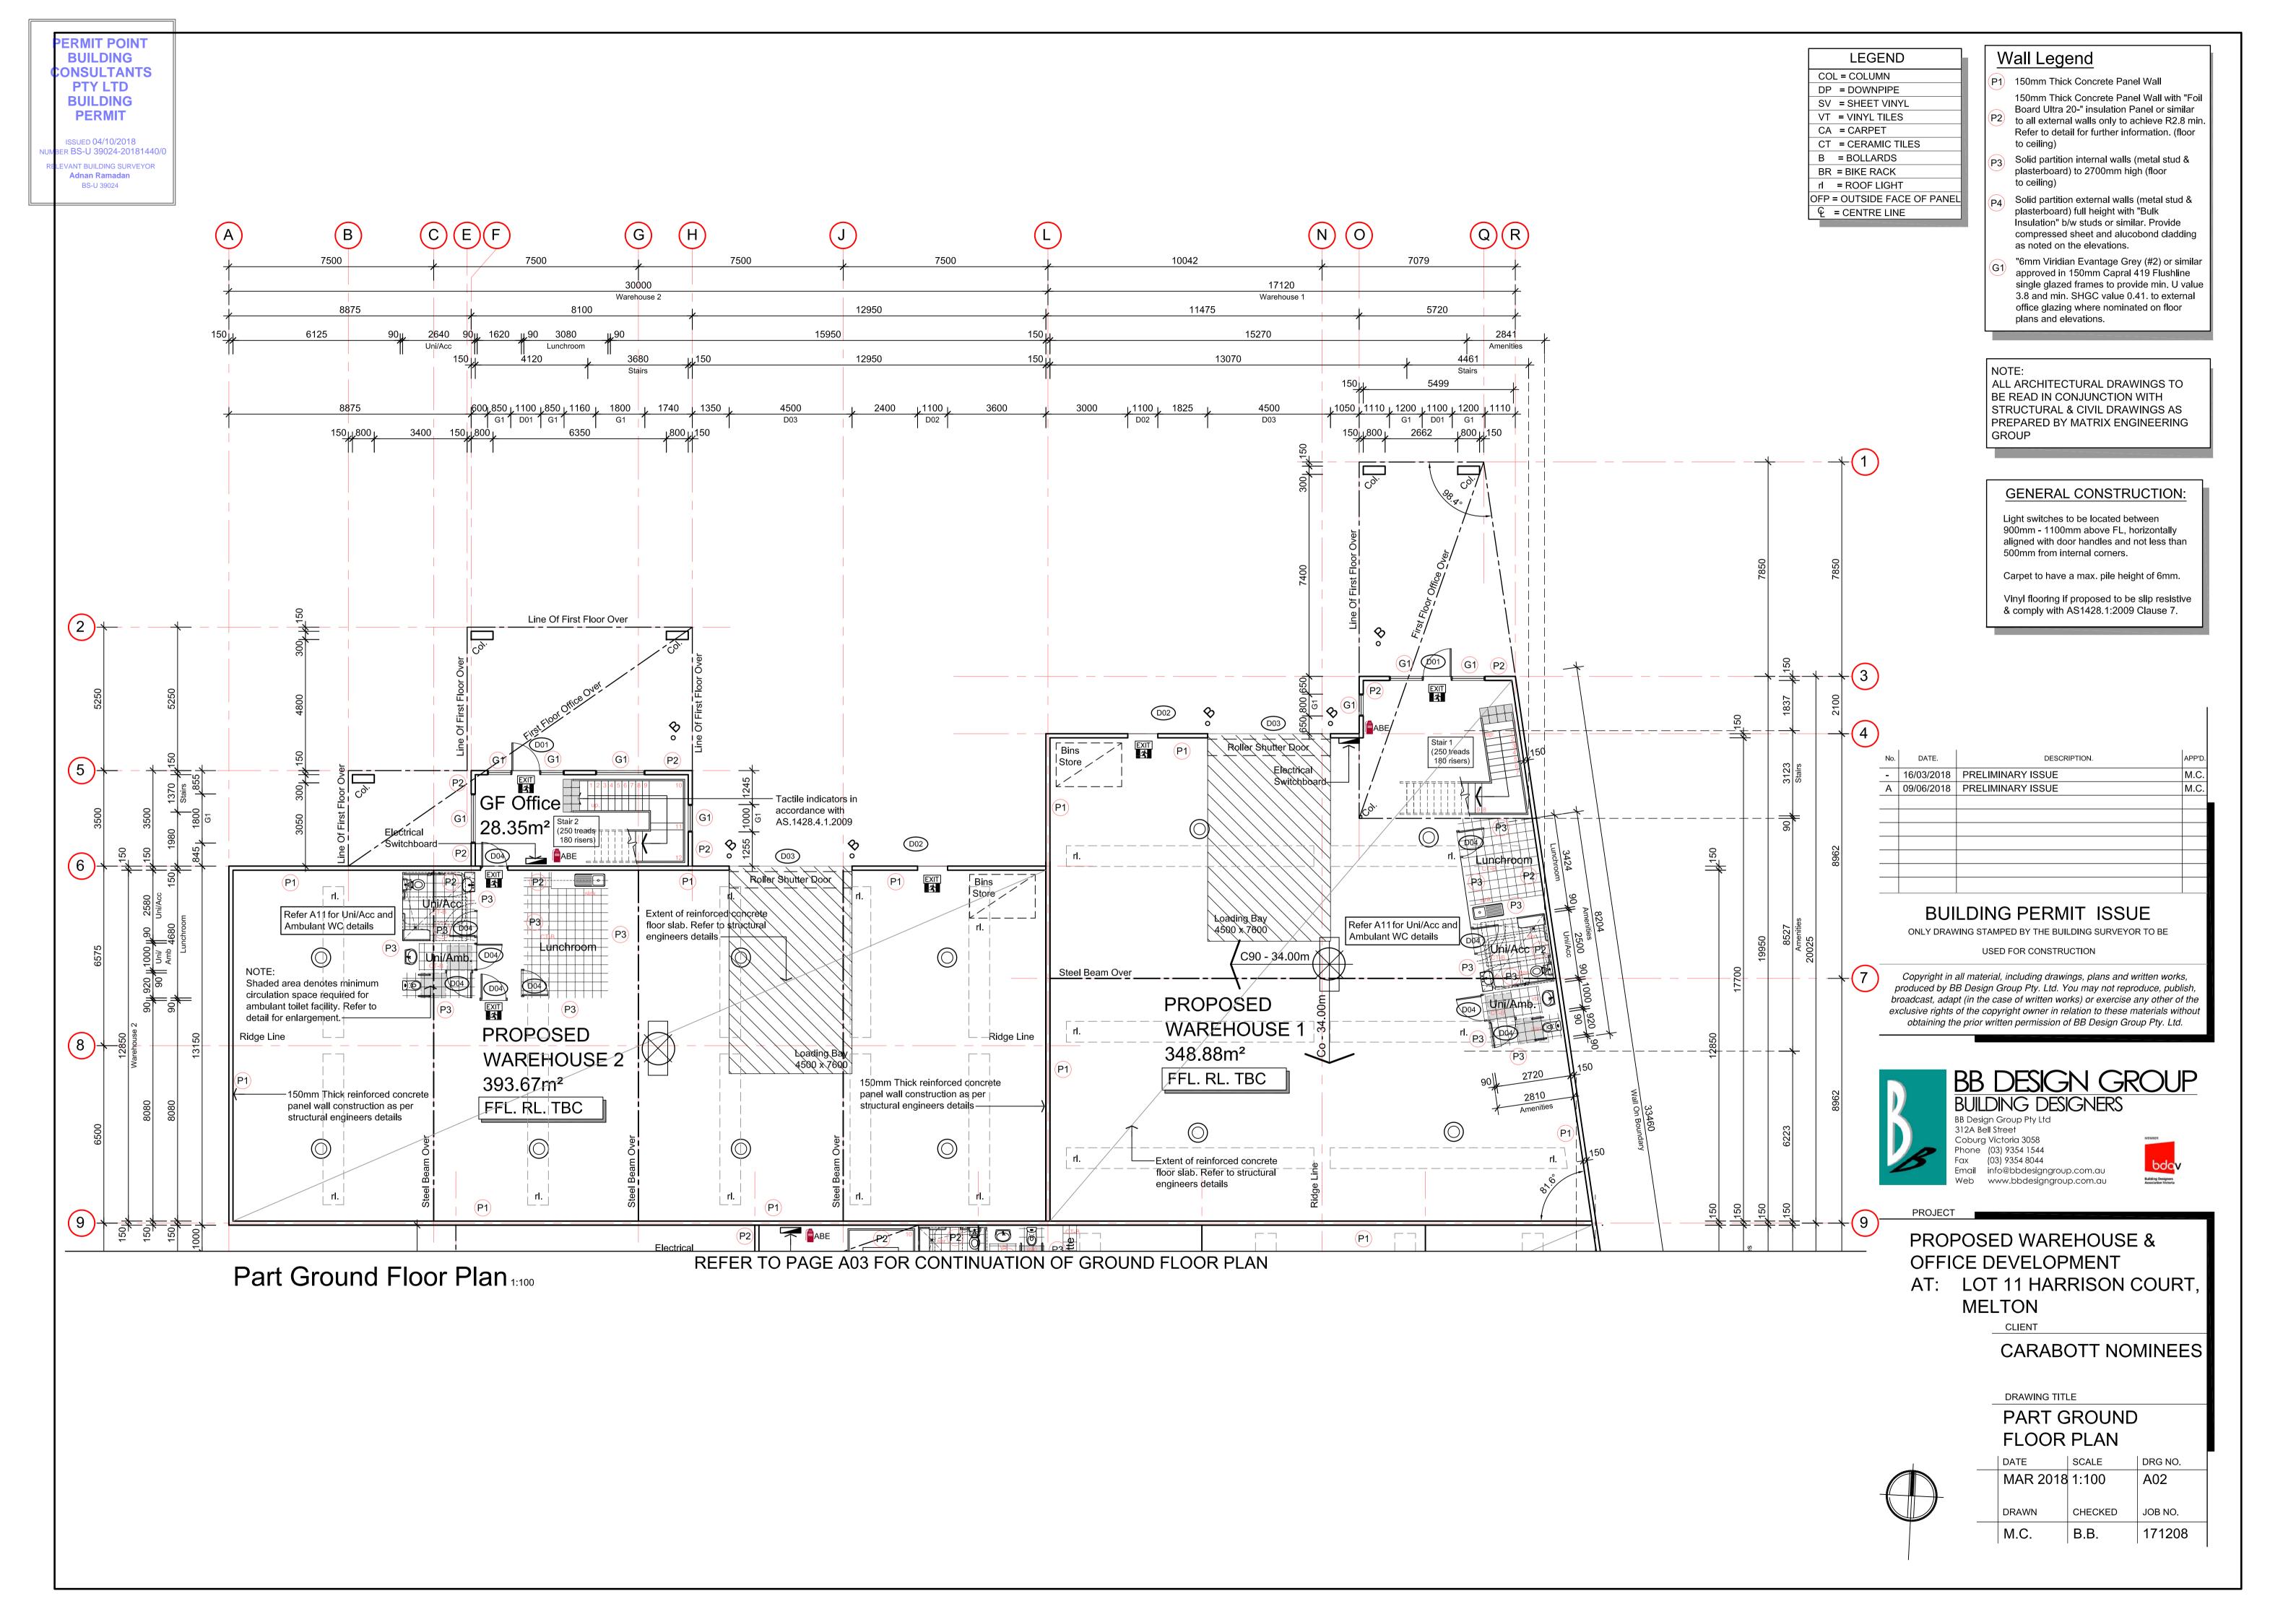

ERMIT POINT BUILDING **ONSULTANTS** PTY LTD **BUILDING PERMIT** ISSUED 04/10/2018 R BS-U 39024-20181440/ VANT BUILDING SURVEYOR Adnan Ramadan

BS-U 39024

Part Ground Floor Plan 1:100

Wall Legend LEGEND 150mm Thick Concrete Panel Wall

DP = DOWNPIPE SV = SHEET VINYL VT = VINYL TILES CA = CARPET CT = CERAMIC TILES

COL = COLUMN

B = BOLLARDS BR = BIKE RACK rl = ROOF LIGHT OFP = OUTSIDE FACE OF PANEL € = CENTRE LINE

150mm Thick Concrete Panel Wall with "Foil

Board Ultra 20-" insulation Panel or similar to all external walls only to achieve R2.8 min. Refer to detail for further information. (floor to ceiling)

> Solid partition internal walls (metal stud & plasterboard) to 2700mm high (floor

Solid partition external walls (metal stud & plasterboard) full height with "Bulk Insulation" b/w studs or similar. Provide compressed sheet and alucobond cladding as noted on the elevations.

"6mm Viridian Evantage Grey (#2) or similar approved in 150mm Capral 419 Flushline single glazed frames to provide min. U value 3.8 and min. SHGC value 0.41. to external office glazing where nominated on floor plans and elevations.


ALL ARCHITECTURAL DRAWINGS TO BE READ IN CONJUNCTION WITH STRUCTURAL & CIVIL DRAWINGS AS PREPARED BY MATRIX ENGINEERING

GENERAL CONSTRUCTION:

Light switches to be located between 900mm - 1100mm above FL, horizontally aligned with door handles and not less than 500mm from internal corners.

Carpet to have a max. pile height of 6mm.

Vinyl flooring if proposed to be slip resistive & comply with AS1428.1:2009 Clause 7.

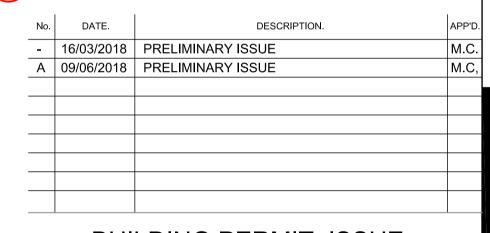

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PROPOSED WAREHOUSE & OFFICE DEVELOPMENT


AT: LOT 11 HARRISON COURT


MELTON


CARABOTT NOMINEES

DRAWING TITLE

PART GROUND FLOOR PLAN

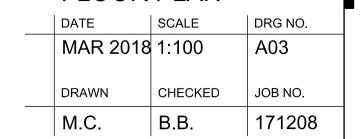


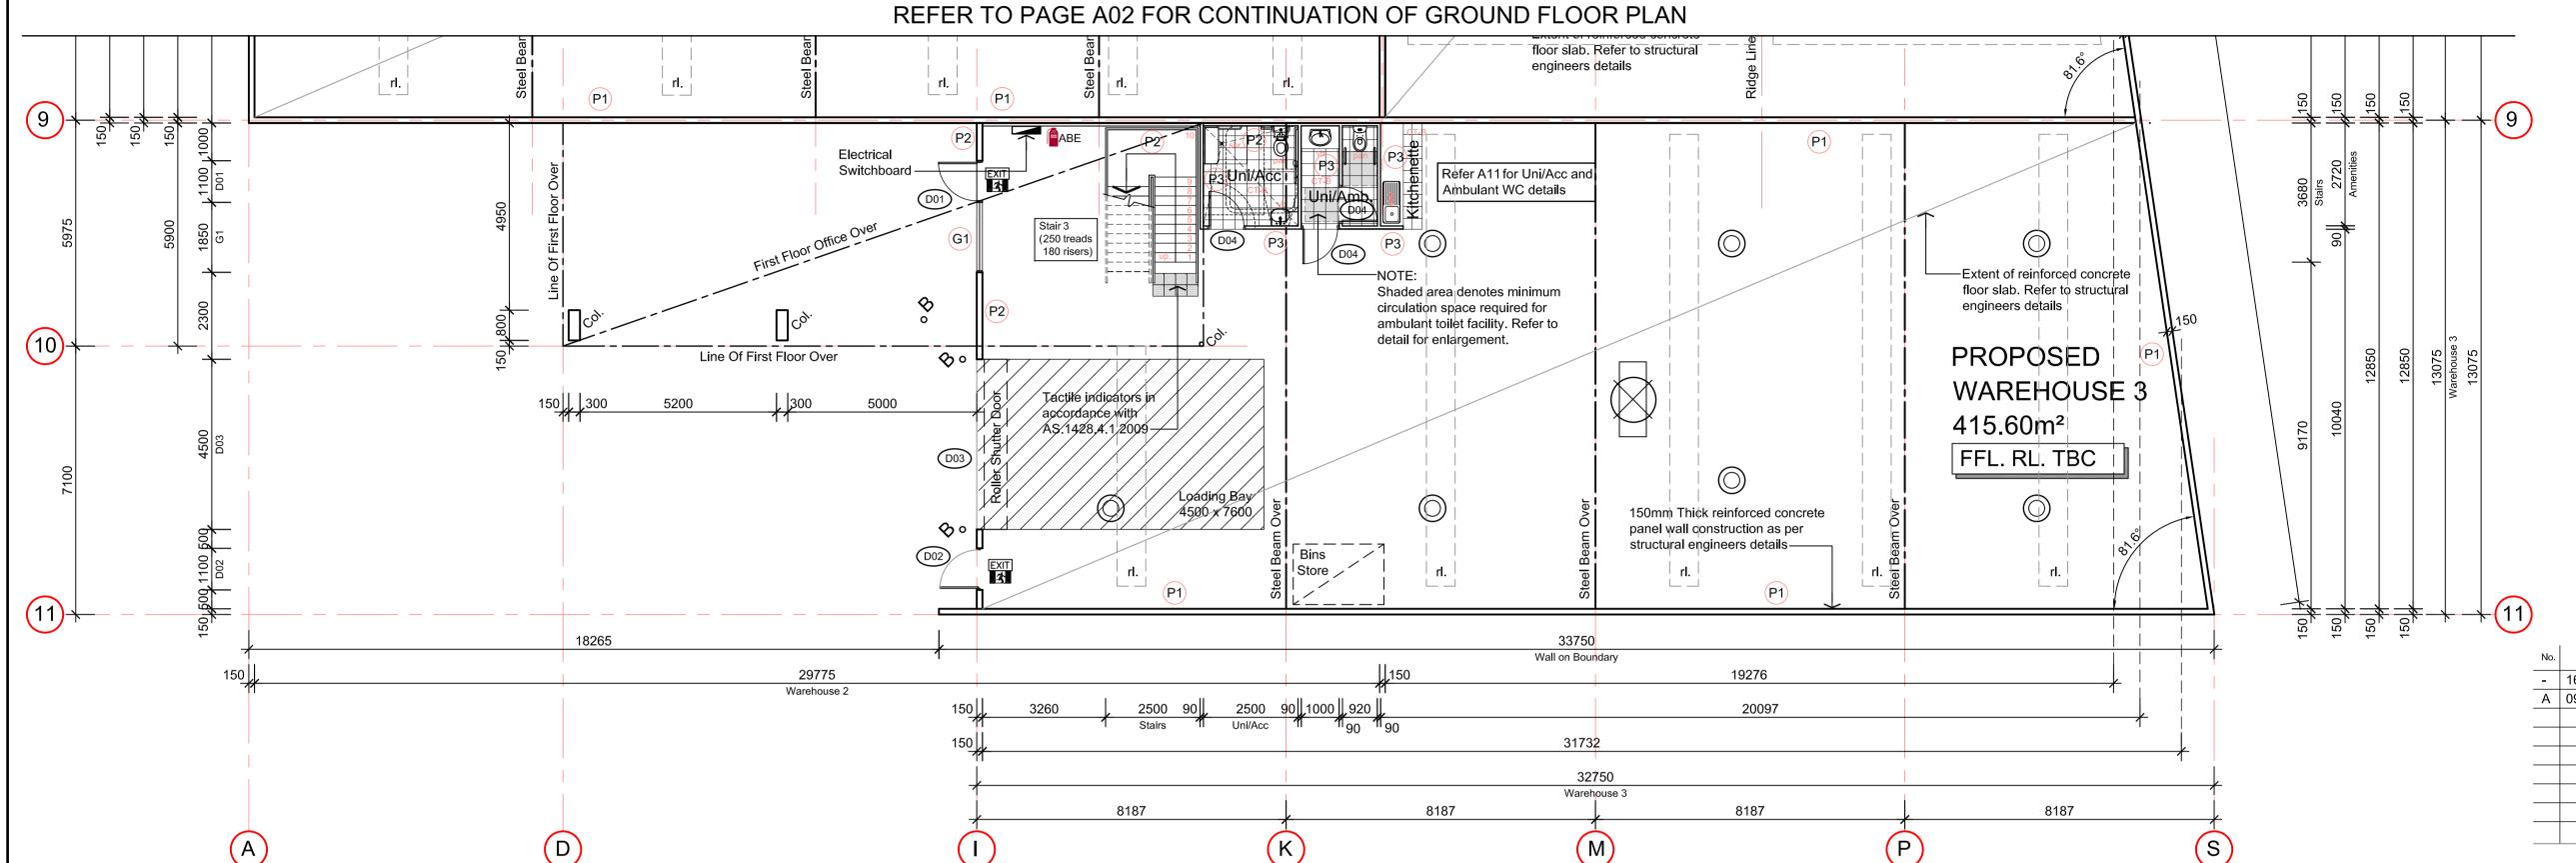


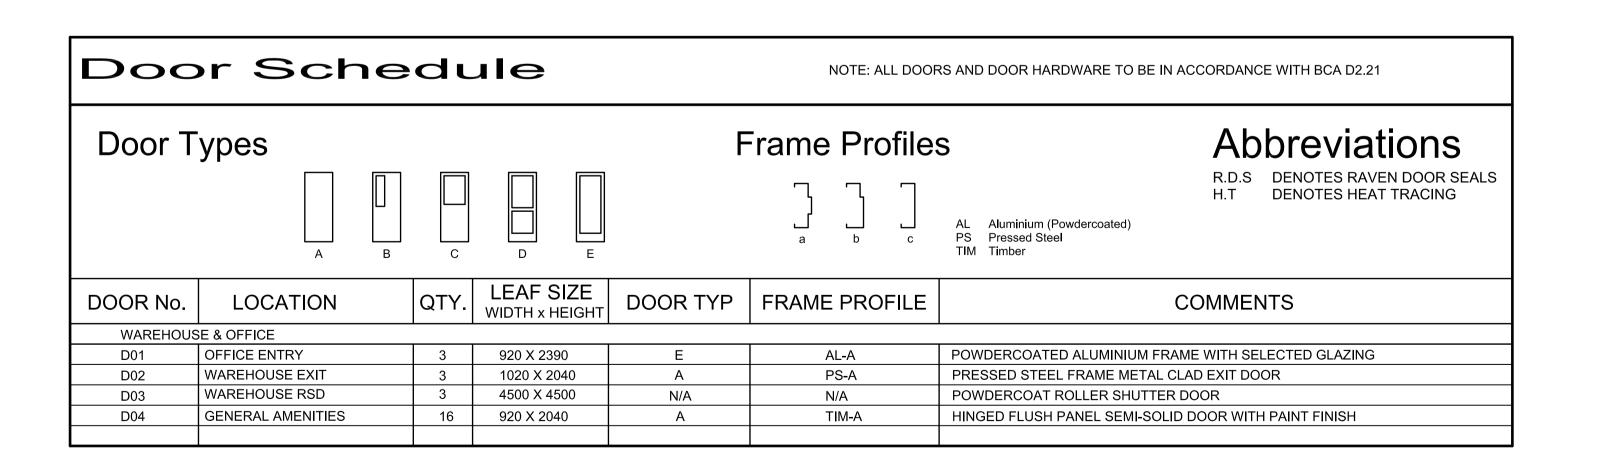


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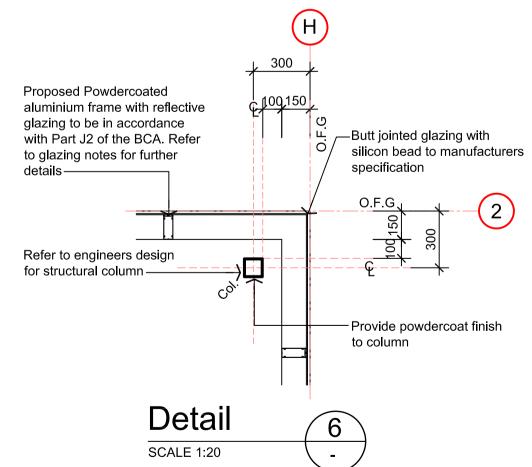
ER BS-U 39024-20181440/ VANT BUILDING SURVEYOR Adnan Ramadan BS-U 39024



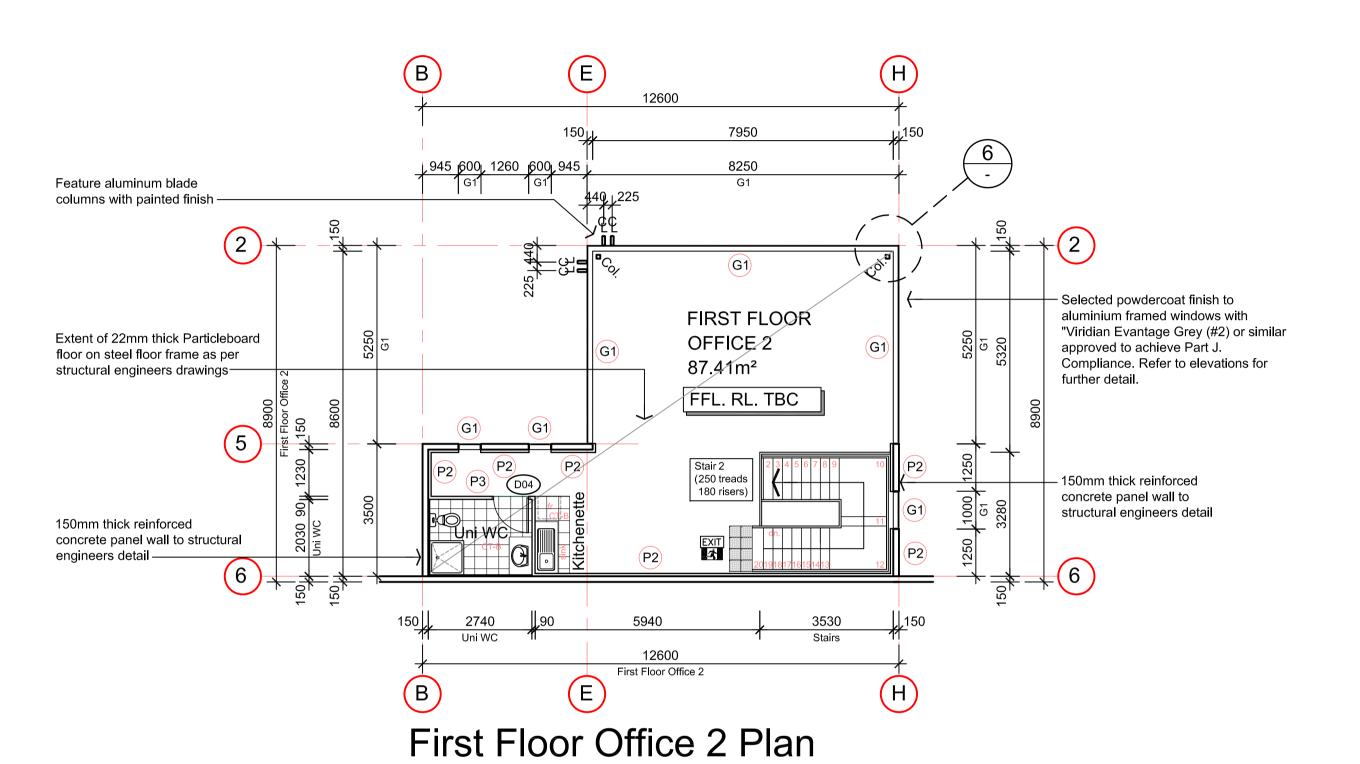

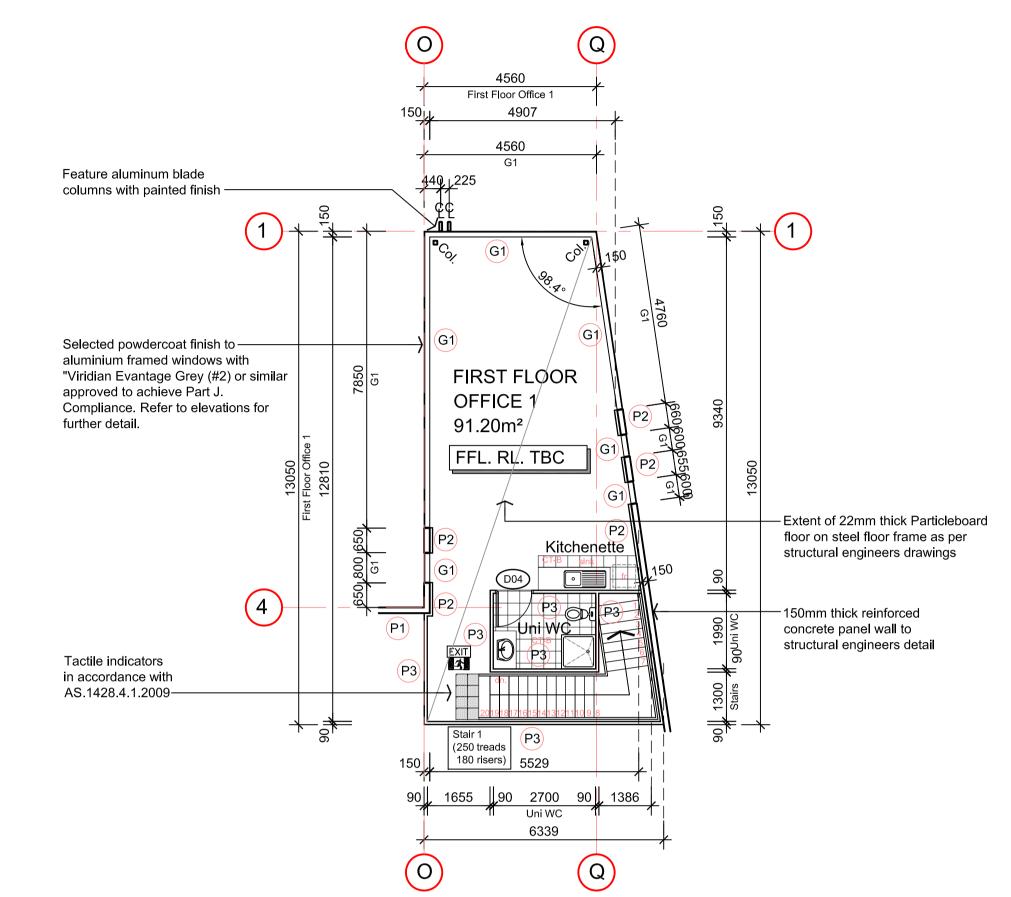First Floor Office 1 Plan



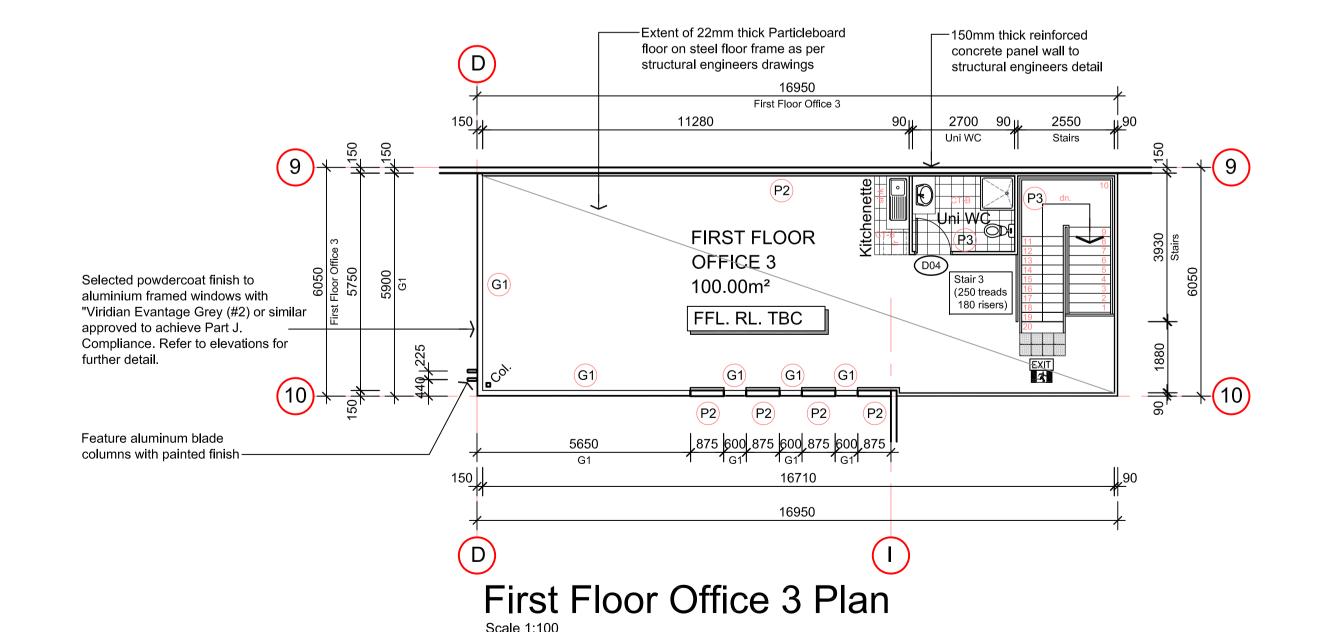

Wall Legend

LEGEND

COL = COLUMN

DP = DOWNPIPE

SV = SHEET VINYL

VT = VINYL TILES

CT = CERAMIC TILES

CA = CARPET

B = BOLLARDS

BR = BIKE RACK

rl = ROOF LIGHT

€ = CENTRE LINE

OFP = OUTSIDE FACE OF PANEL

- 150mm Thick Concrete Panel Wall
- 150mm Thick Concrete Panel Wall with "Foil Board Ultra 20-" insulation Panel or similar to all external walls only to achieve R2.8 min. Refer to detail for further information. (floor to ceiling)
- Solid partition internal walls (metal stud & plasterboard) to 2700mm high (floor
- Solid partition external walls (metal stud & plasterboard) full height with "Bulk Insulation" b/w studs or similar. Provide compressed sheet and alucobond cladding as noted on the elevations.
- "6mm Viridian Evantage Grey (#2) or similar approved in 150mm Capral 419 Flushline single glazed frames to provide min. U value 3.8 and min. SHGC value 0.41. to external office glazing where nominated on floor plans and elevations.

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GENERAL CONSTRUCTION:

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Carpet to have a max. pile height of 6mm.

Vinyl flooring if proposed to be slip resistive & comply with AS1428.1:2009 Clause 7.

DATE.	DESCRIPTION.	APP'D.
16/03/2018	PRELIMINARY ISSUE	M.C.
09/06/2018	PRELIMINARY ISSUE	M.C.
_	16/03/2018	16/03/2018 PRELIMINARY ISSUE

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PROPOSED WAREHOUSE & OFFICE DEVELOPMENT

AT: LOT 11 HARRISON COURT

MELTON

CARABOTT NOMINEES

DRAWING TITLE

FIRST FLOOR PLAN




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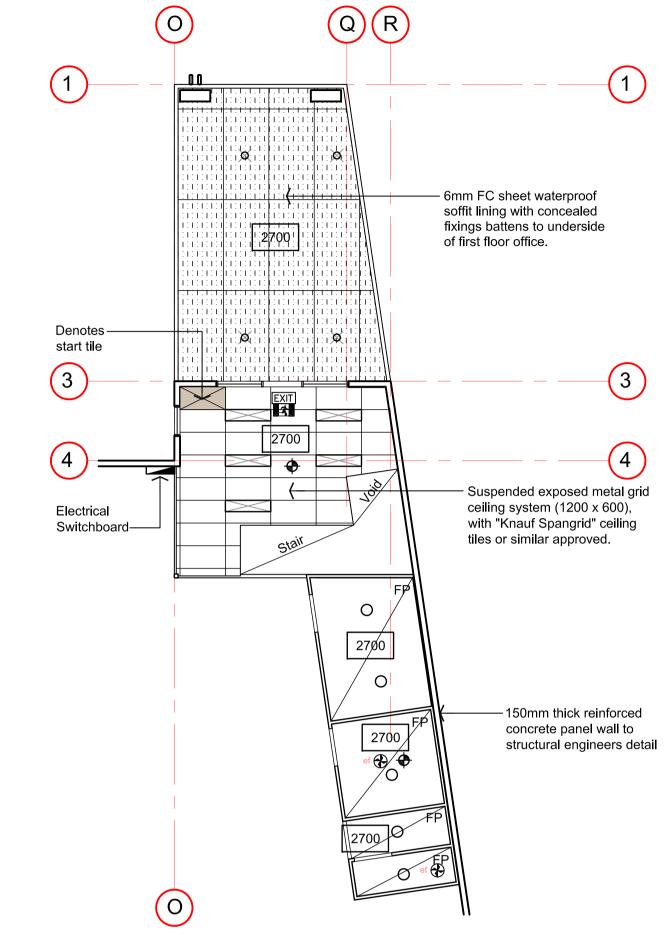
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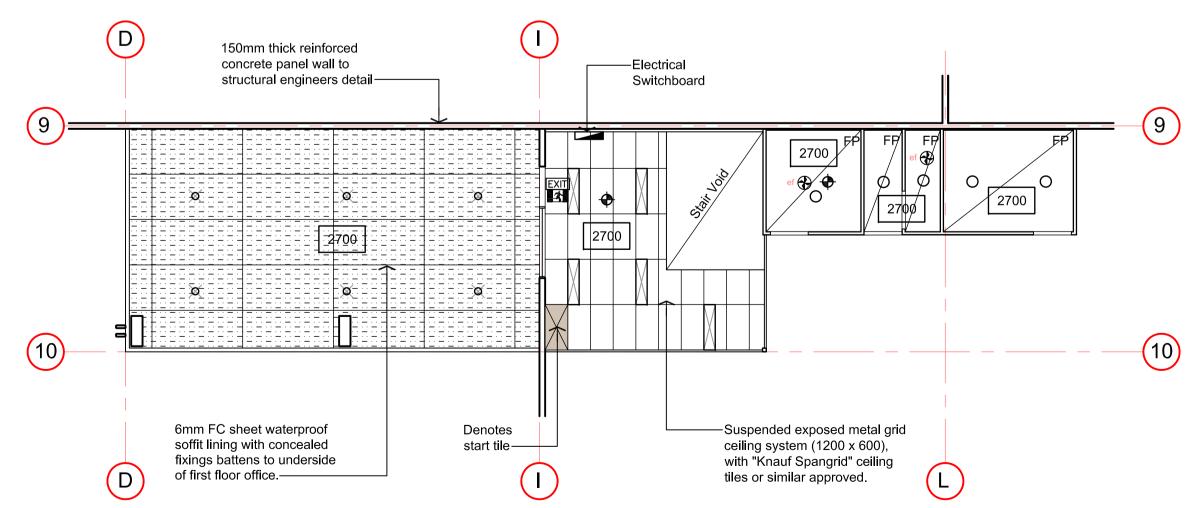
JAMBER BS-U 39024-20181440/4

VANT BUILDING SURVEYOR **Adnan Ramadan**BS-U 39024






Ground Floor Reflected Ceiling Plan
Scale 1:100

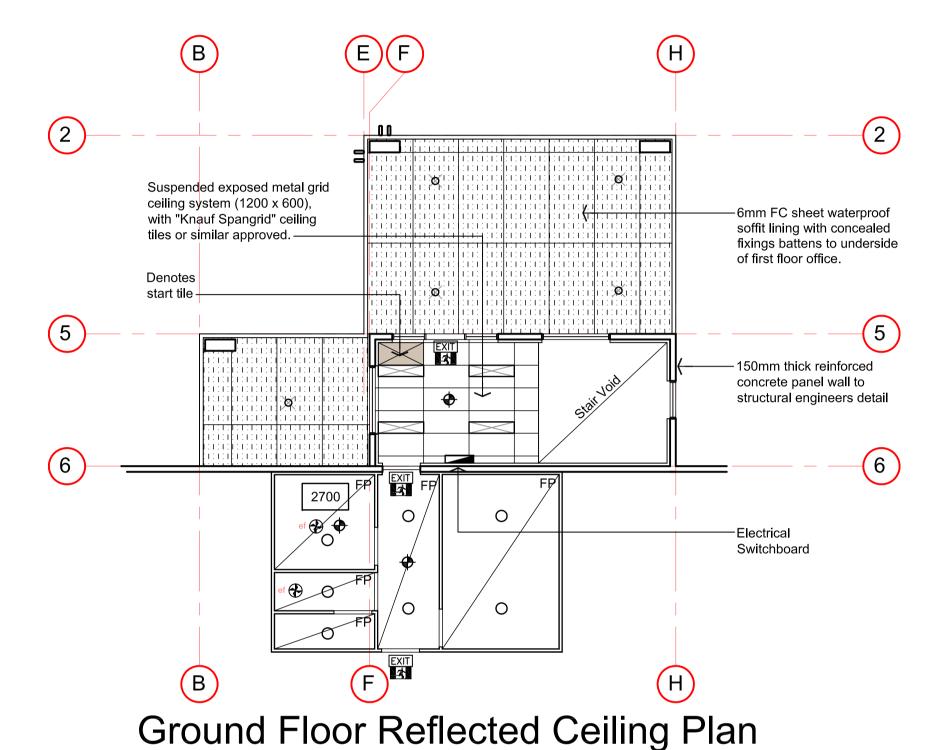

Ground Floor Reflected Ceiling Plan
Scale 1:100
Office 3

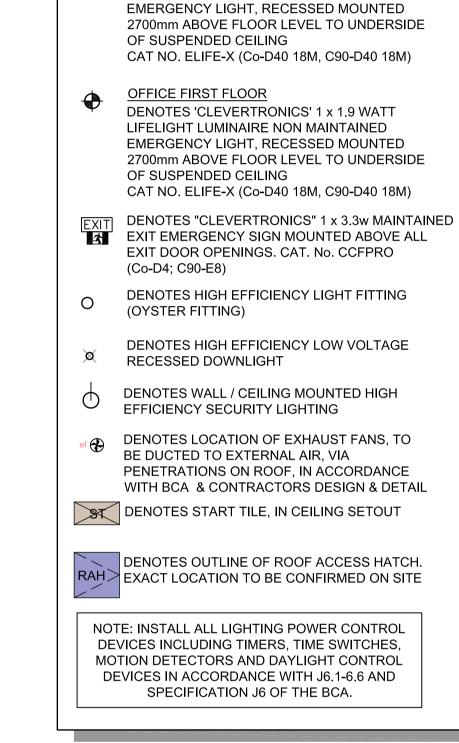

LIGHTING LEGEND:


OFFICE GROUND FLOOR

DENOTES HIGH EFFICIENCY RECESSED FLUORESCENT LIGHT FITTING WITH PRISMATIC


DENOTES 2 X 36w HIGH EFFICIENCY SURFACE

MOUNTED LIGHT FITTING WITH DIFFUSER.

DENOTES 'CLEVERTRONICS' 1 x 1.9 WATT LIFELIGHT LUMINAIRE NON MAINTAINED

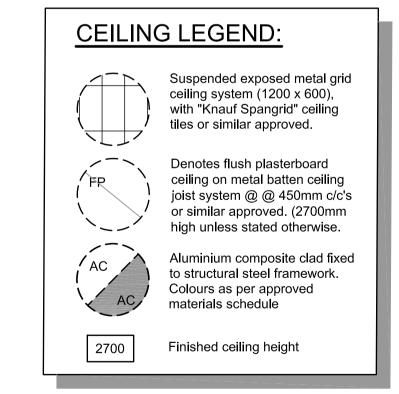

NOTE:
LIGHTING LAYOUT IS INDICATIVE ONLY,
WITH FINAL DESIGN BY ELECTRICAL
DESIGN AND CONSTRUCT CONSULTANT

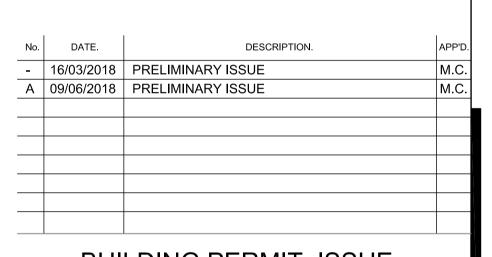

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PROJECT

PROPOSED WAREHOUSE & OFFICE DEVELOPMENT

AT: LOT 11 HARRISON COURT

MELTON

CLIEN

CARABOTT NOMINEES

DRAWING TITLE

GF REFLECTED
CEILING PLAN



 DATE
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 DRG NO.


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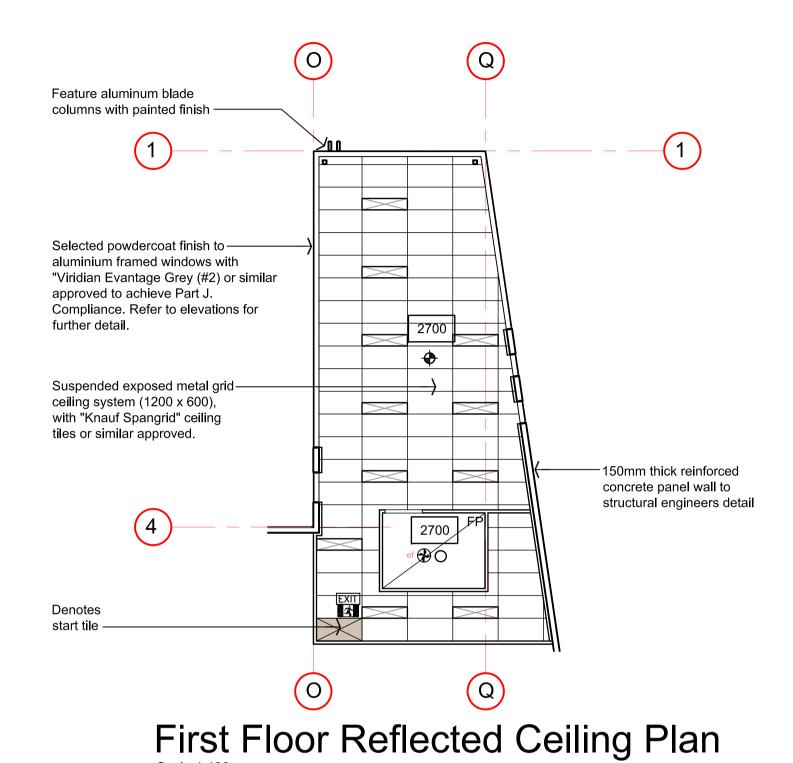
 M.C.
 B.B.
 171208

PERMIT POINT
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BUILDING
PERMIT


ISSUED 04/10/2018
NUMBER BS-U 39024-20181440/
RELEVANT BUILDING SURVEYOR
Adnan Ramadan
BS-U 39024




Office 2

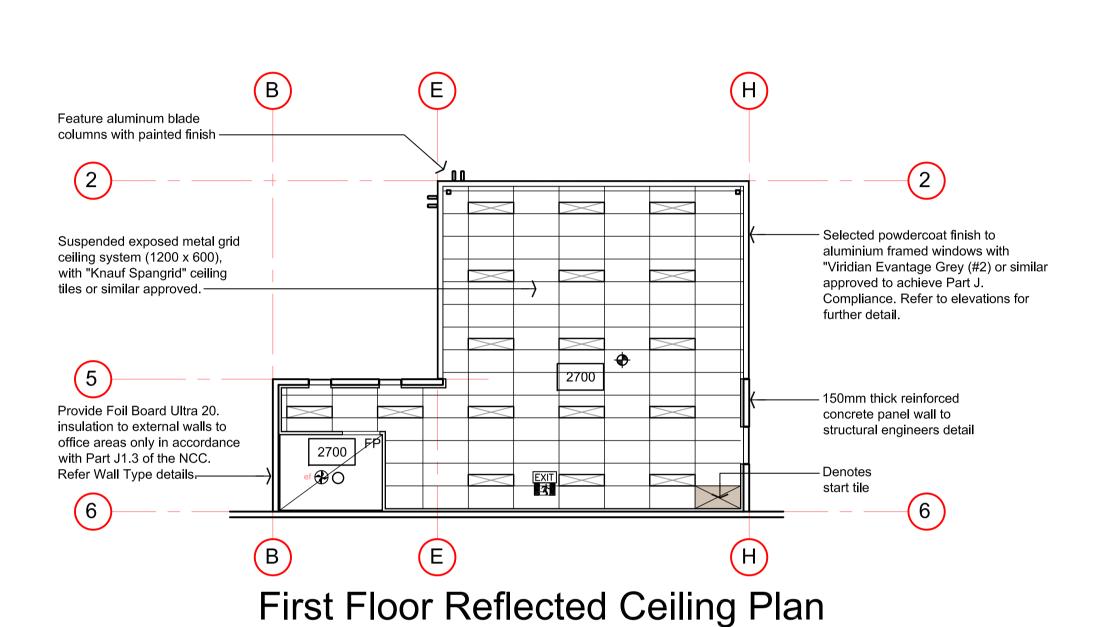

Office 1

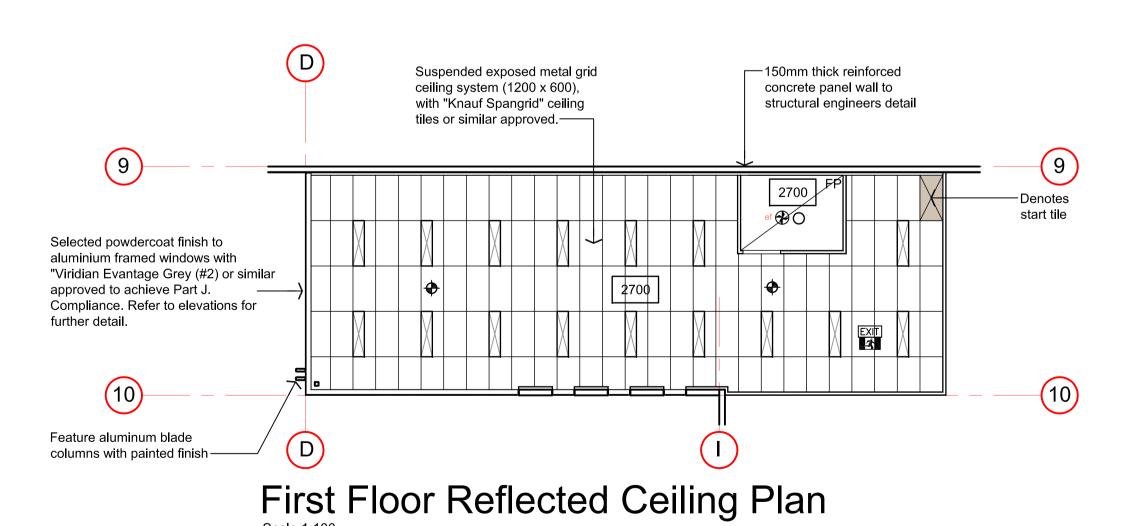

Office 3

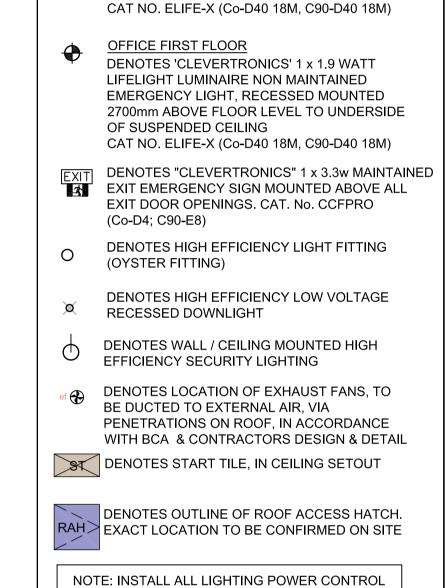

DEVICES INCLUDING TIMERS, TIME SWITCHES, MOTION DETECTORS AND DAYLIGHT CONTROL

DEVICES IN ACCORDANCE WITH J6.1-6.6 AND SPECIFICATION J6 OF THE BCA.

LIGHTING LEGEND:

OFFICE GROUND FLOOR


OF SUSPENDED CEILING

DENOTES HIGH EFFICIENCY RECESSED FLUORESCENT LIGHT FITTING WITH PRISMATIC


DENOTES 2 X 36w HIGH EFFICIENCY SURFACE MOUNTED LIGHT FITTING WITH DIFFUSER.

DENOTES 'CLEVERTRONICS' 1 x 1.9 WATT

LIFELIGHT LUMINAIRE NON MAINTAINED EMERGENCY LIGHT, RECESSED MOUNTED 2700mm ABOVE FLOOR LEVEL TO UNDERSIDE

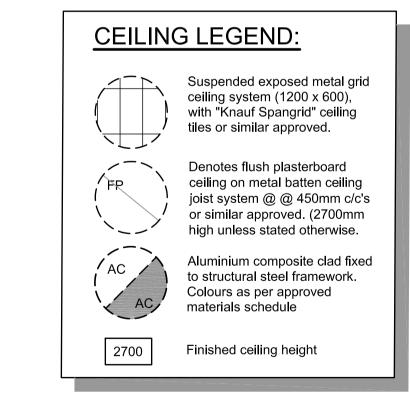

NOTE:
LIGHTING LAYOUT IS INDICATIVE ONLY,
WITH FINAL DESIGN BY ELECTRICAL
DESIGN AND CONSTRUCT CONSULTANT

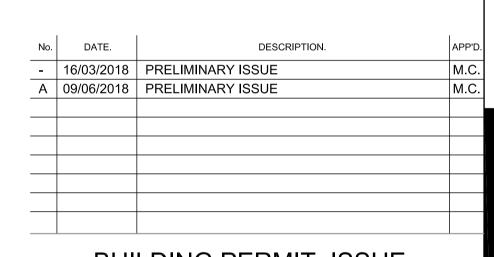

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PROJECT

PROPOSED WAREHOUSE & OFFICE DEVELOPMENT

AT: LOT 11 HARRISON COURT

MELTON

CARABOTT NOMINEES

DRAWING TITLE


FF REFLECTED CEILING PLAN



DATE	SCALE	DRG NO.	
MAR 2018	1:100	A06	
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M.C.	B.B.	171208	
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ISSUED 04/10/2018
NUMBER BS-U 39024-20181440
RELEVANT BUILDING SURVEYOR
Adnan Ramadan
BS-U 39024



NATURAL LIGHT ANALYSIS

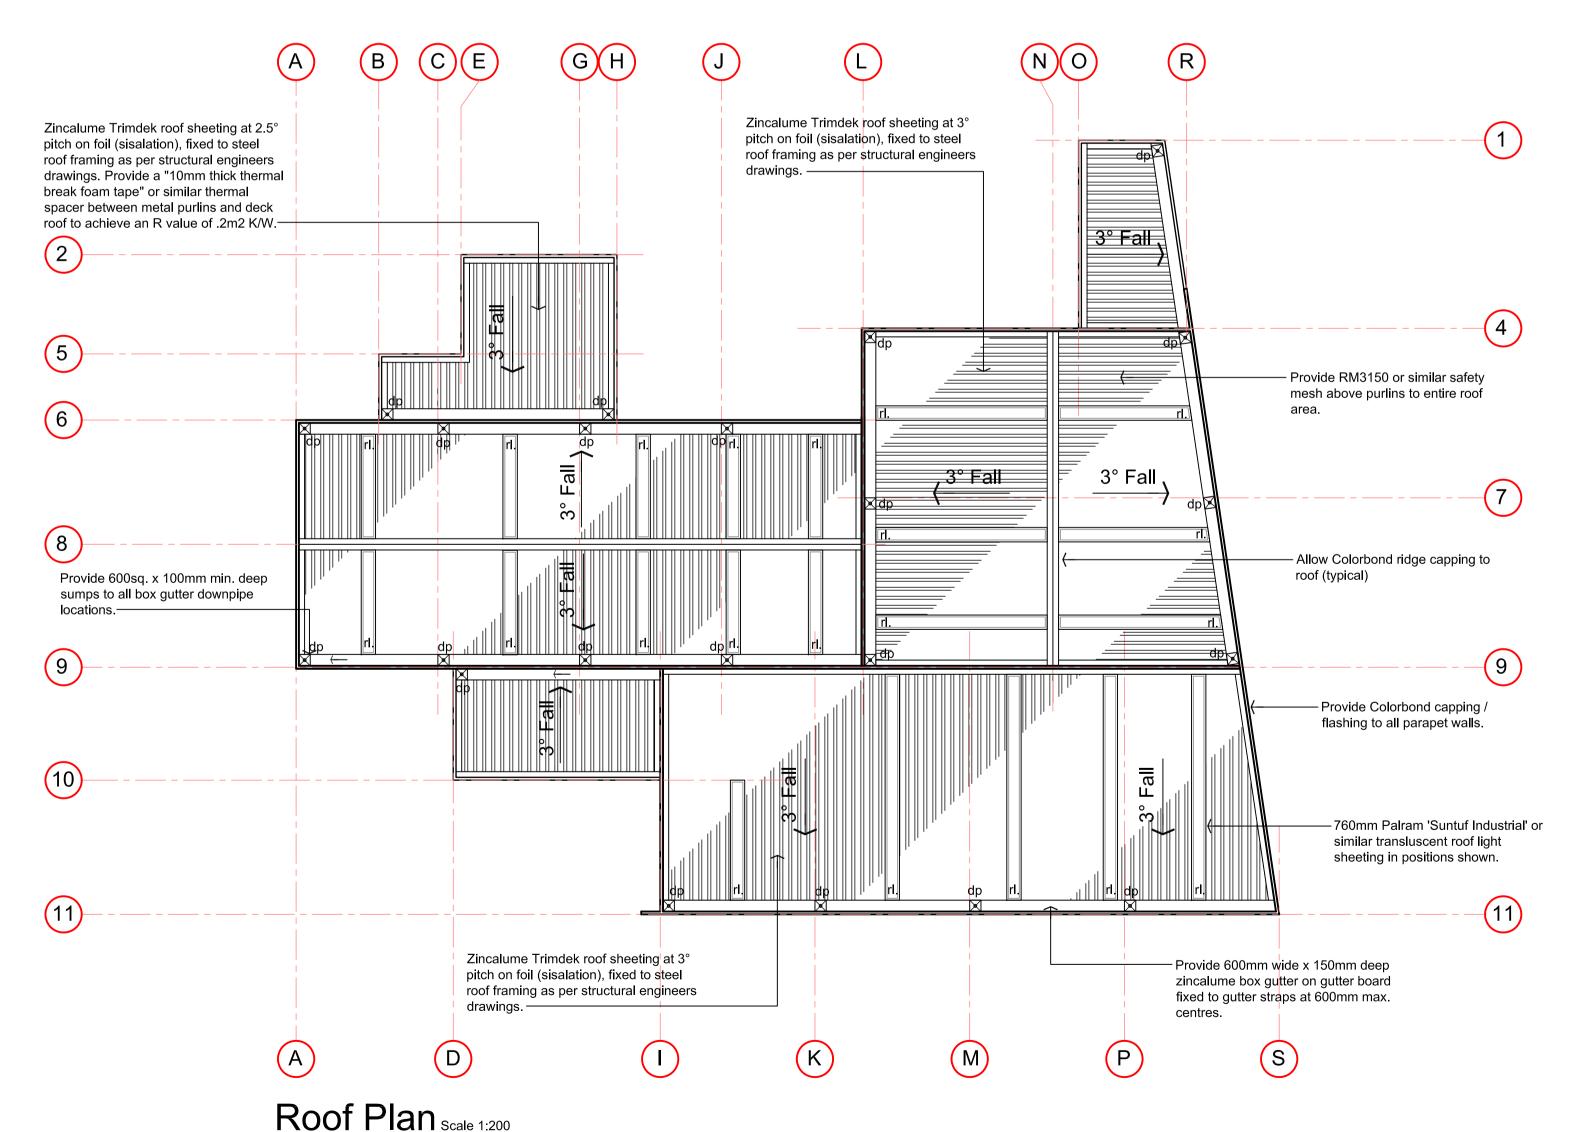WAREHOUSE 1 FLOOR AREA: 348.88m²
REQ'D 10% NATURAL LIGHTING: 34.88m²
NATURAL LIGHT VIA CLEAR ROOF LIGHTS (85% TRANSPARENT OR SIMILAR.

 0.76m W X 9.06m L
 =6.88m² X = 3
 20.65m²

 0.76m W X 8.68m L
 =6.59m² X = 1
 6.59m²

 0.76m W X 8.00m L
 =6.08m² X = 1
 6.08m²

 0.76m W X 7.05m L
 =5.35m² X = 1
 5.35m²

 TOTAL NATURAL LIGHTING
 38.67m²

WAREHOUSE 2 FLOOR AREA: 393.67m²
REQ'D 10% NATURAL LIGHTING: 39.36m²
NATURAL LIGHT VIA CLEAR ROOF LIGHTS (85% TRANSPARENT OR SIMILAR.

0.76m W X 5.52m L =4.19m² X = 10 <u>41.90m²</u>

WAREHOUSE 3 FLOOR AREA: 415.60m²
REQ'D 10% NATURAL LIGHTING: 41.56m²
NATURAL LIGHT VIA CLEAR ROOF LIGHTS (85%
TRANSPARENT OR SIMILAR.

0.76m W X 11.95m L =9.08m² X = 4 0.76m W X 6.90m L =5.24m² X = 1 TOTAL NATURAL LIGHTING 41.56m²

NOTE:

PROVIDE WHIRLY BIRD ROOF
VENTILATION TO WAREHOUSE TO
PROVIDE 150L/SEC MIN

NOTE:

ALL CEILING/ROOF INSULATION TO ACHIEVE A TOTAL MIN. R VALUE OF 3.2. (TO OFFICE AREA ONLY)

NOTE:
DENOTES LOCATION OF ROOF
ACCESS HATCH. BUILDER TO
PROVIDE NECESSARY FLASHING TO
ENSURE WATERTIGHT FINISH

NOTE:

NATURAL VENTILATION VIA
FRESH AIR FAN DUCTED
DIRECTLY TO OUTSIDE AIR WITH WALL
MOUNTED SWITCH 200 LITRES PER
SECOND MINIMUM CAPACITY

NOTE:

ALL AMENITY EXHAUST FANS, TO BE
DUCTED TO EXTERNAL AIR, VIA
PENETRATIONS ON ROOF, IN
ACCORDANCE WITH BCA &
CONTRACTORS DESIGN & DETAIL

NOTE:

ALL ARCHITECTURAL DRAWINGS TO BE READ IN CONJUNCTION WITH STRUCTURAL & CIVIL DRAWINGS AS PREPARED BY MATRIX ENGINEERING GROUP

ROOFING NOTES:

METAL ROOF SHEETING TO COMPLY WITH AS 1562.1

PROVIDE ZINCALUME TRIMDECK ROOF SHEETING AT 3.0° PITCH TO OFFICE/WAREHOUSE AS PER SPEC.

ROOF SHEETING TO BE FIXED AND INSTALLED AS PER MANUFACTURERS REQUIREMENTS.

PROVIDE 3mm

ZINC COATED SAFETY MESH 150mm
X 300mm (150 BEING THE SPACING OF
LONGITUDINAL WIRES PARALLEL TO THE

DO NOT USE ANY LEAD NAILS OR ANY LEAD A FLASHING, WASHERS, ETC.

CORRIGATIONS) UNDER ALL ROOF SHEETING.

USE RECOMMENDED SEALANTS BY ROOFING MANUFACTURER.

ALL DOWNPIPES TO BE 150mm Ø MINIMUM, UNLESS OTHERWISE NOTED. REFER TO CIVIL ENGINEERS DRAWINGS FOR DETAILS.

ALL PENETRATIONS IN ROOF SHEETING TO BE FLASHED WITH ZINCALUME FLASHING AS SUPPLIED BY ROOFING MANUFACTURER.

PROVIDE WIRE MESH TO TOP OF ALL SUMPS.

PROVIDE 300mm SOAKER GUTTERS AS REQUIRED TO ALL ROOF MOUNTED EQUIPMENT.

PROVIDE OFFICE/WAREHOUSE BOX GUTTERS WITH 600 X 600 X 150MM DEEP SUMPS. PROVIDE 600 X 100MM OVERFLOW IN SUMP LOCATED CENTRAL. 30MM ABOVE BASE OF BOX GUTTER.

ALL GUTTERS TO BE PROVIDED WITH A MINIMUM GRADE OF 1:200.

INSULATION, SISALATION AND SAFETY MESH

SUPPLY AND INSTALL AS SPECIFIED INSULATION, SISALATION AND SAFETY MESH OVER MILD STEEL PURLINS PRIOR TO LAYING AND FIXING ROOF SHEETS.

SAFETY MESH TO BE FIXED TO RIDGE PURLIN AND PULLED TIGHT IN CONTINUOUS LENGTH FOR FULL SPAN OF ROOF, LAY SISALATION AND/OR INSULATION OVER SAFETY MESH IMMEDIATELY PRIOR TO LAYING ROOF SHEETS.

ENSURE SISALATION/INSULATION IS ADEQUATELY LAPPED WITH ADJACENT SHEETS TO PROVIDE A CONTINUOUS INSULATION BARRIER TO THE FULL EXTENT OF ROOF. ENSURE INSULATION IS CONTINUED UNDER BOX GUTTERS AND FIXED IN POSITION. CHECK ALL INTERNAL EXPOSED SURFACES OF INSULATION FOR CONTINUITY AND MAKE GOOD AS REQUIRED.


PLANT PLATFORMS

CONTRACTOR IS TO PROVIDE GALVANISED MILD STEEL ROOF MOUNTED PLANT PLATFORMS TO ROOF MOUNTED UNITS. AS PER MANUFACTURES SPEC.

ROOF PENETRATIONS

CUT ROOF PENETRATIONS & INSTALL UNDERFLASHINGS WHERE DIRECTED OR AS SHOWN ON ARCHITECTURAL & MECHANICAL DRAWINGS. ENSURE UNDERFLASHING HAS SUFFICIENT UPTURN TO ALLOW OVERFLASHINGS TO BE SECURELY FIXED IN FINAL POSITION.

USE A SUFFICIENCY OF SILICON SEALANT TO ENSURE UNDERFLASHING PROVIDES A WATERPROOF SEAL.

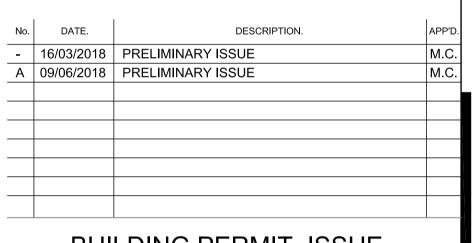

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PROJECT

PROPOSED WAREHOUSE & OFFICE DEVELOPMENT

AT: LOT 11 HARRISON COURT

MELTON


CARABOTT NOMINEES


DRAWING TITLE

ROOF PLAN





	DATE	SCALE	DRG NO.	
	MAR 2018	1:200	A07	
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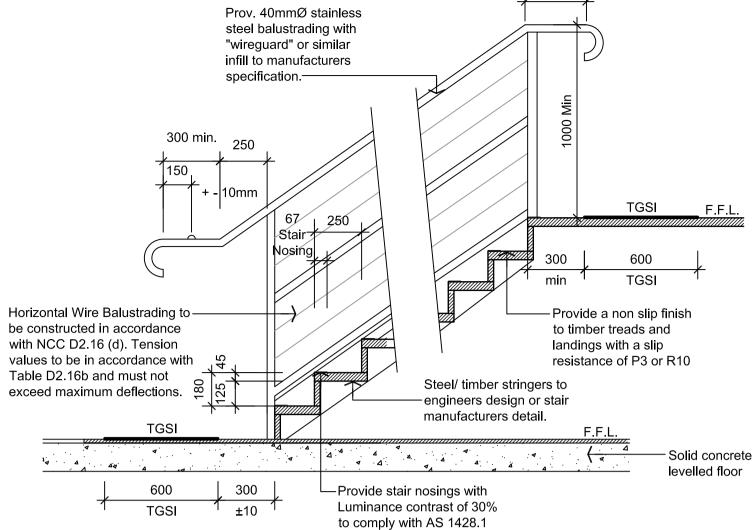


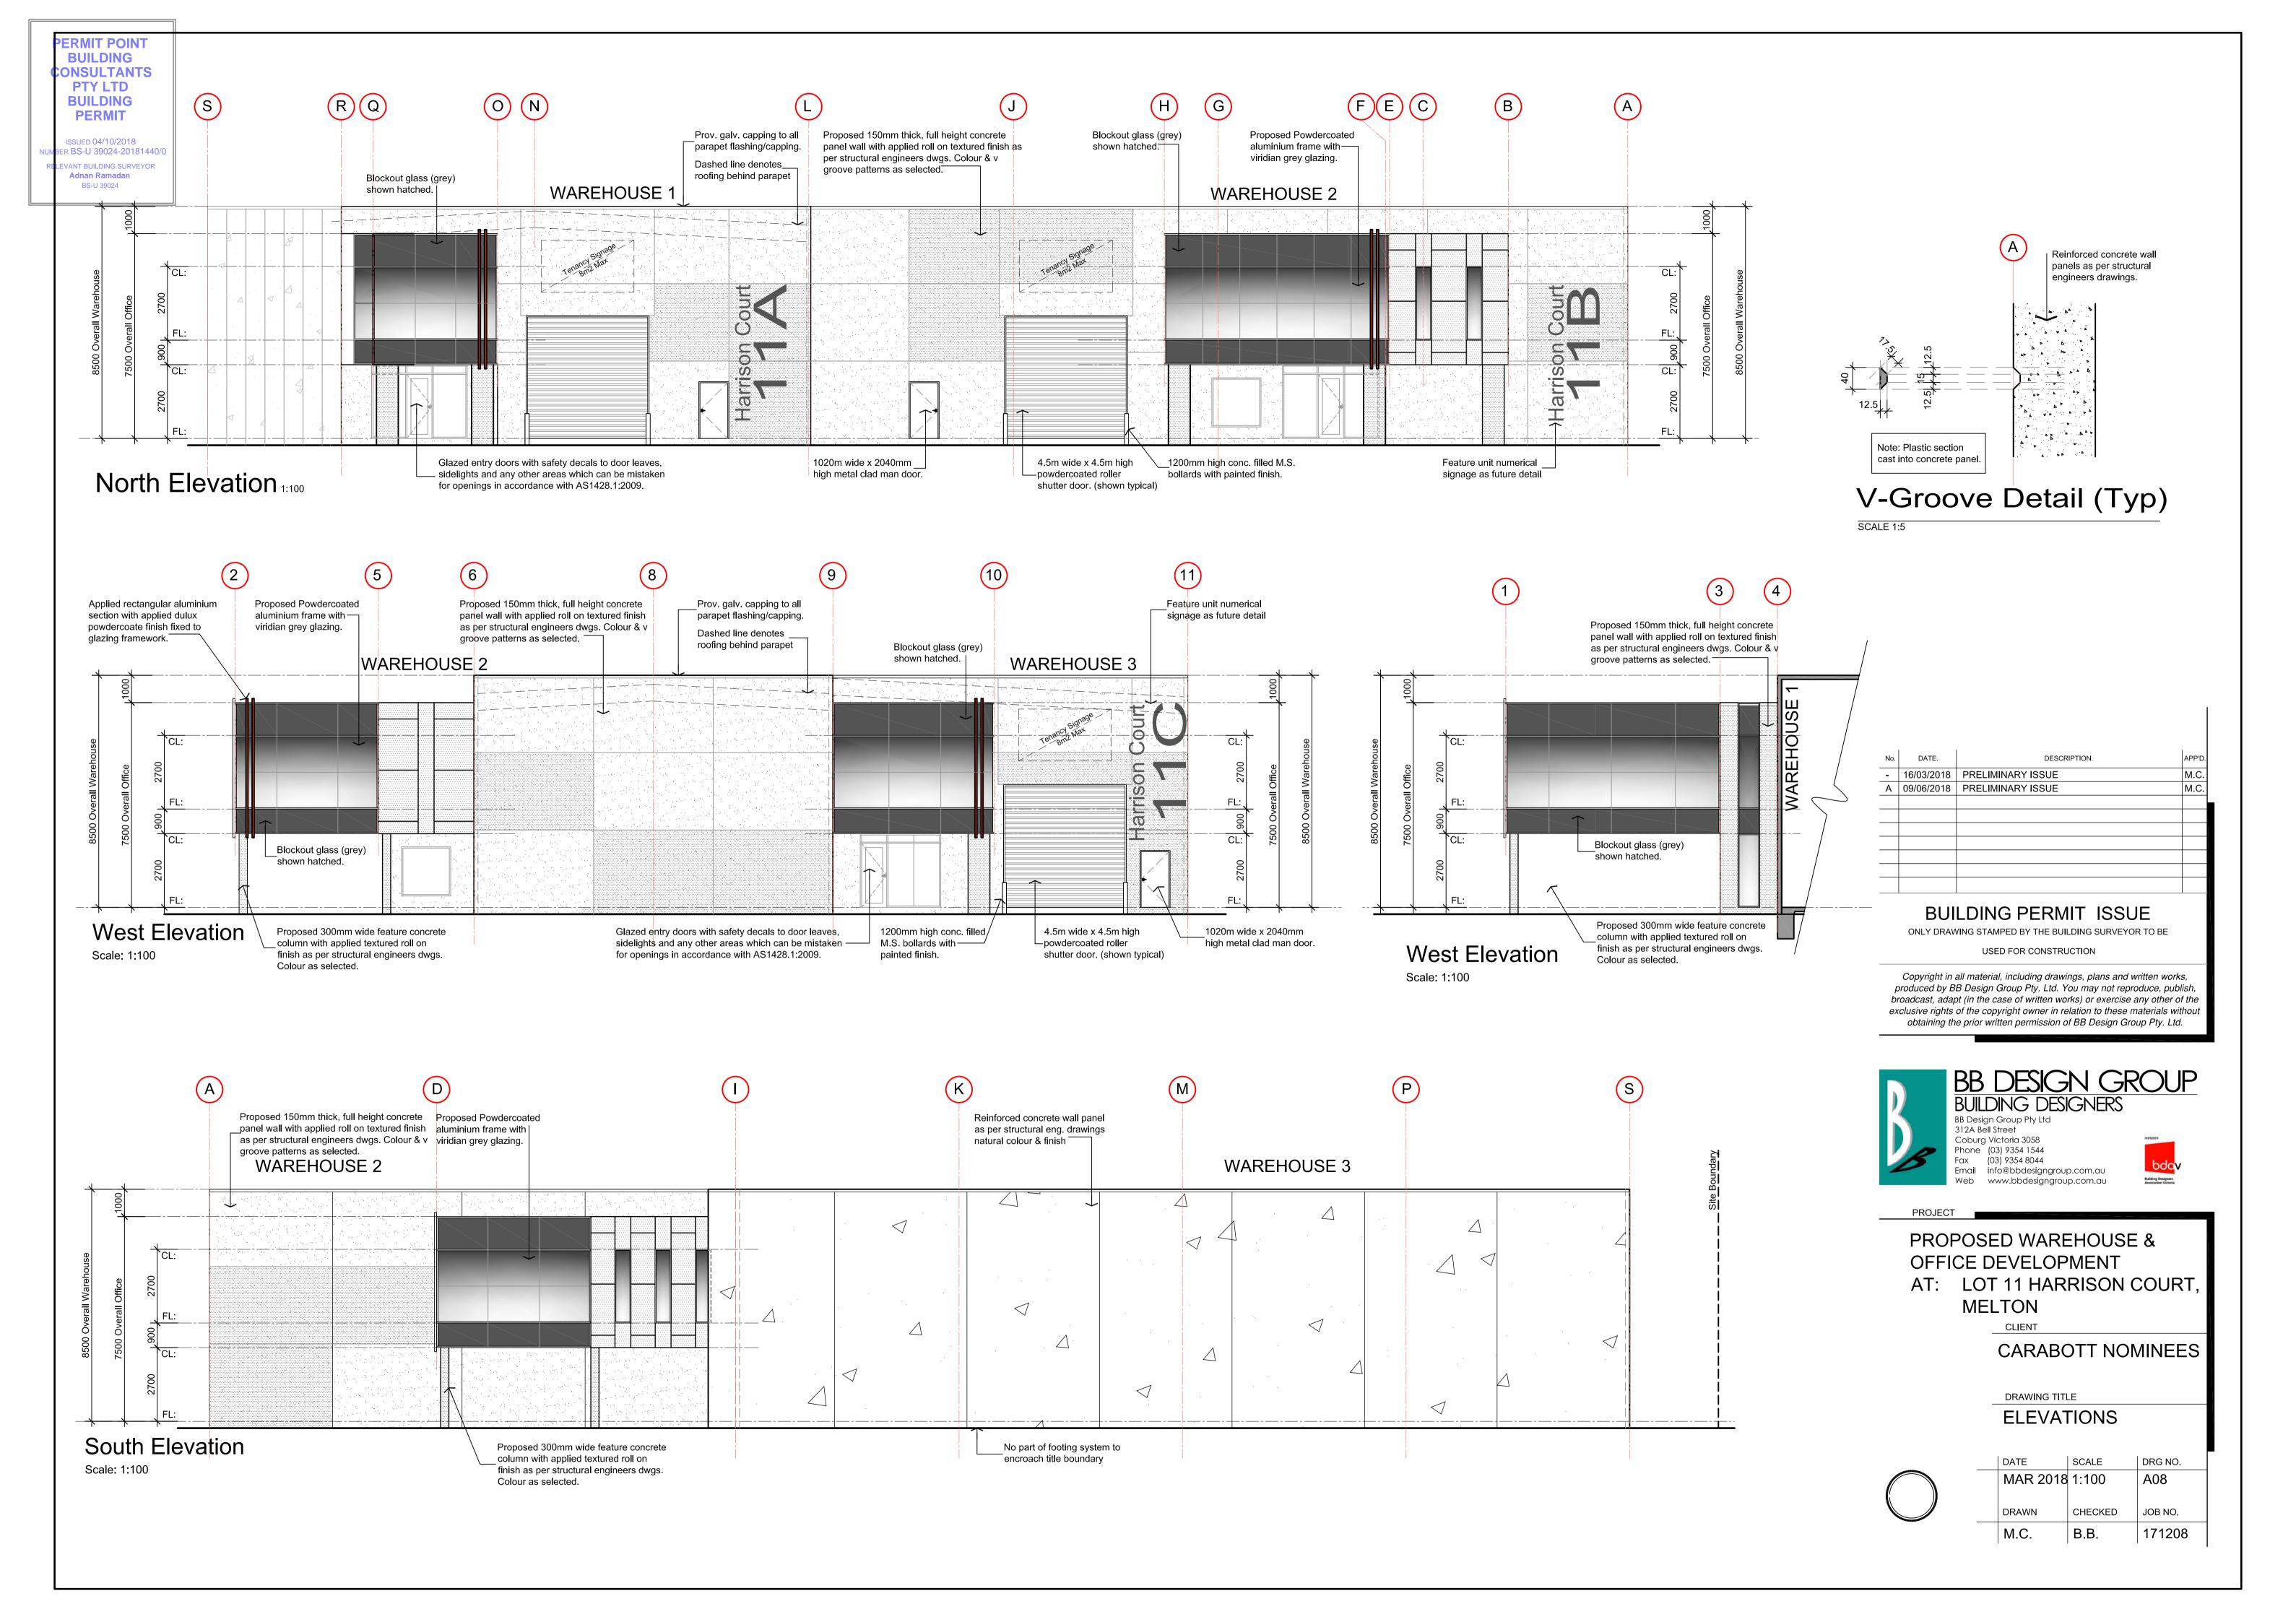

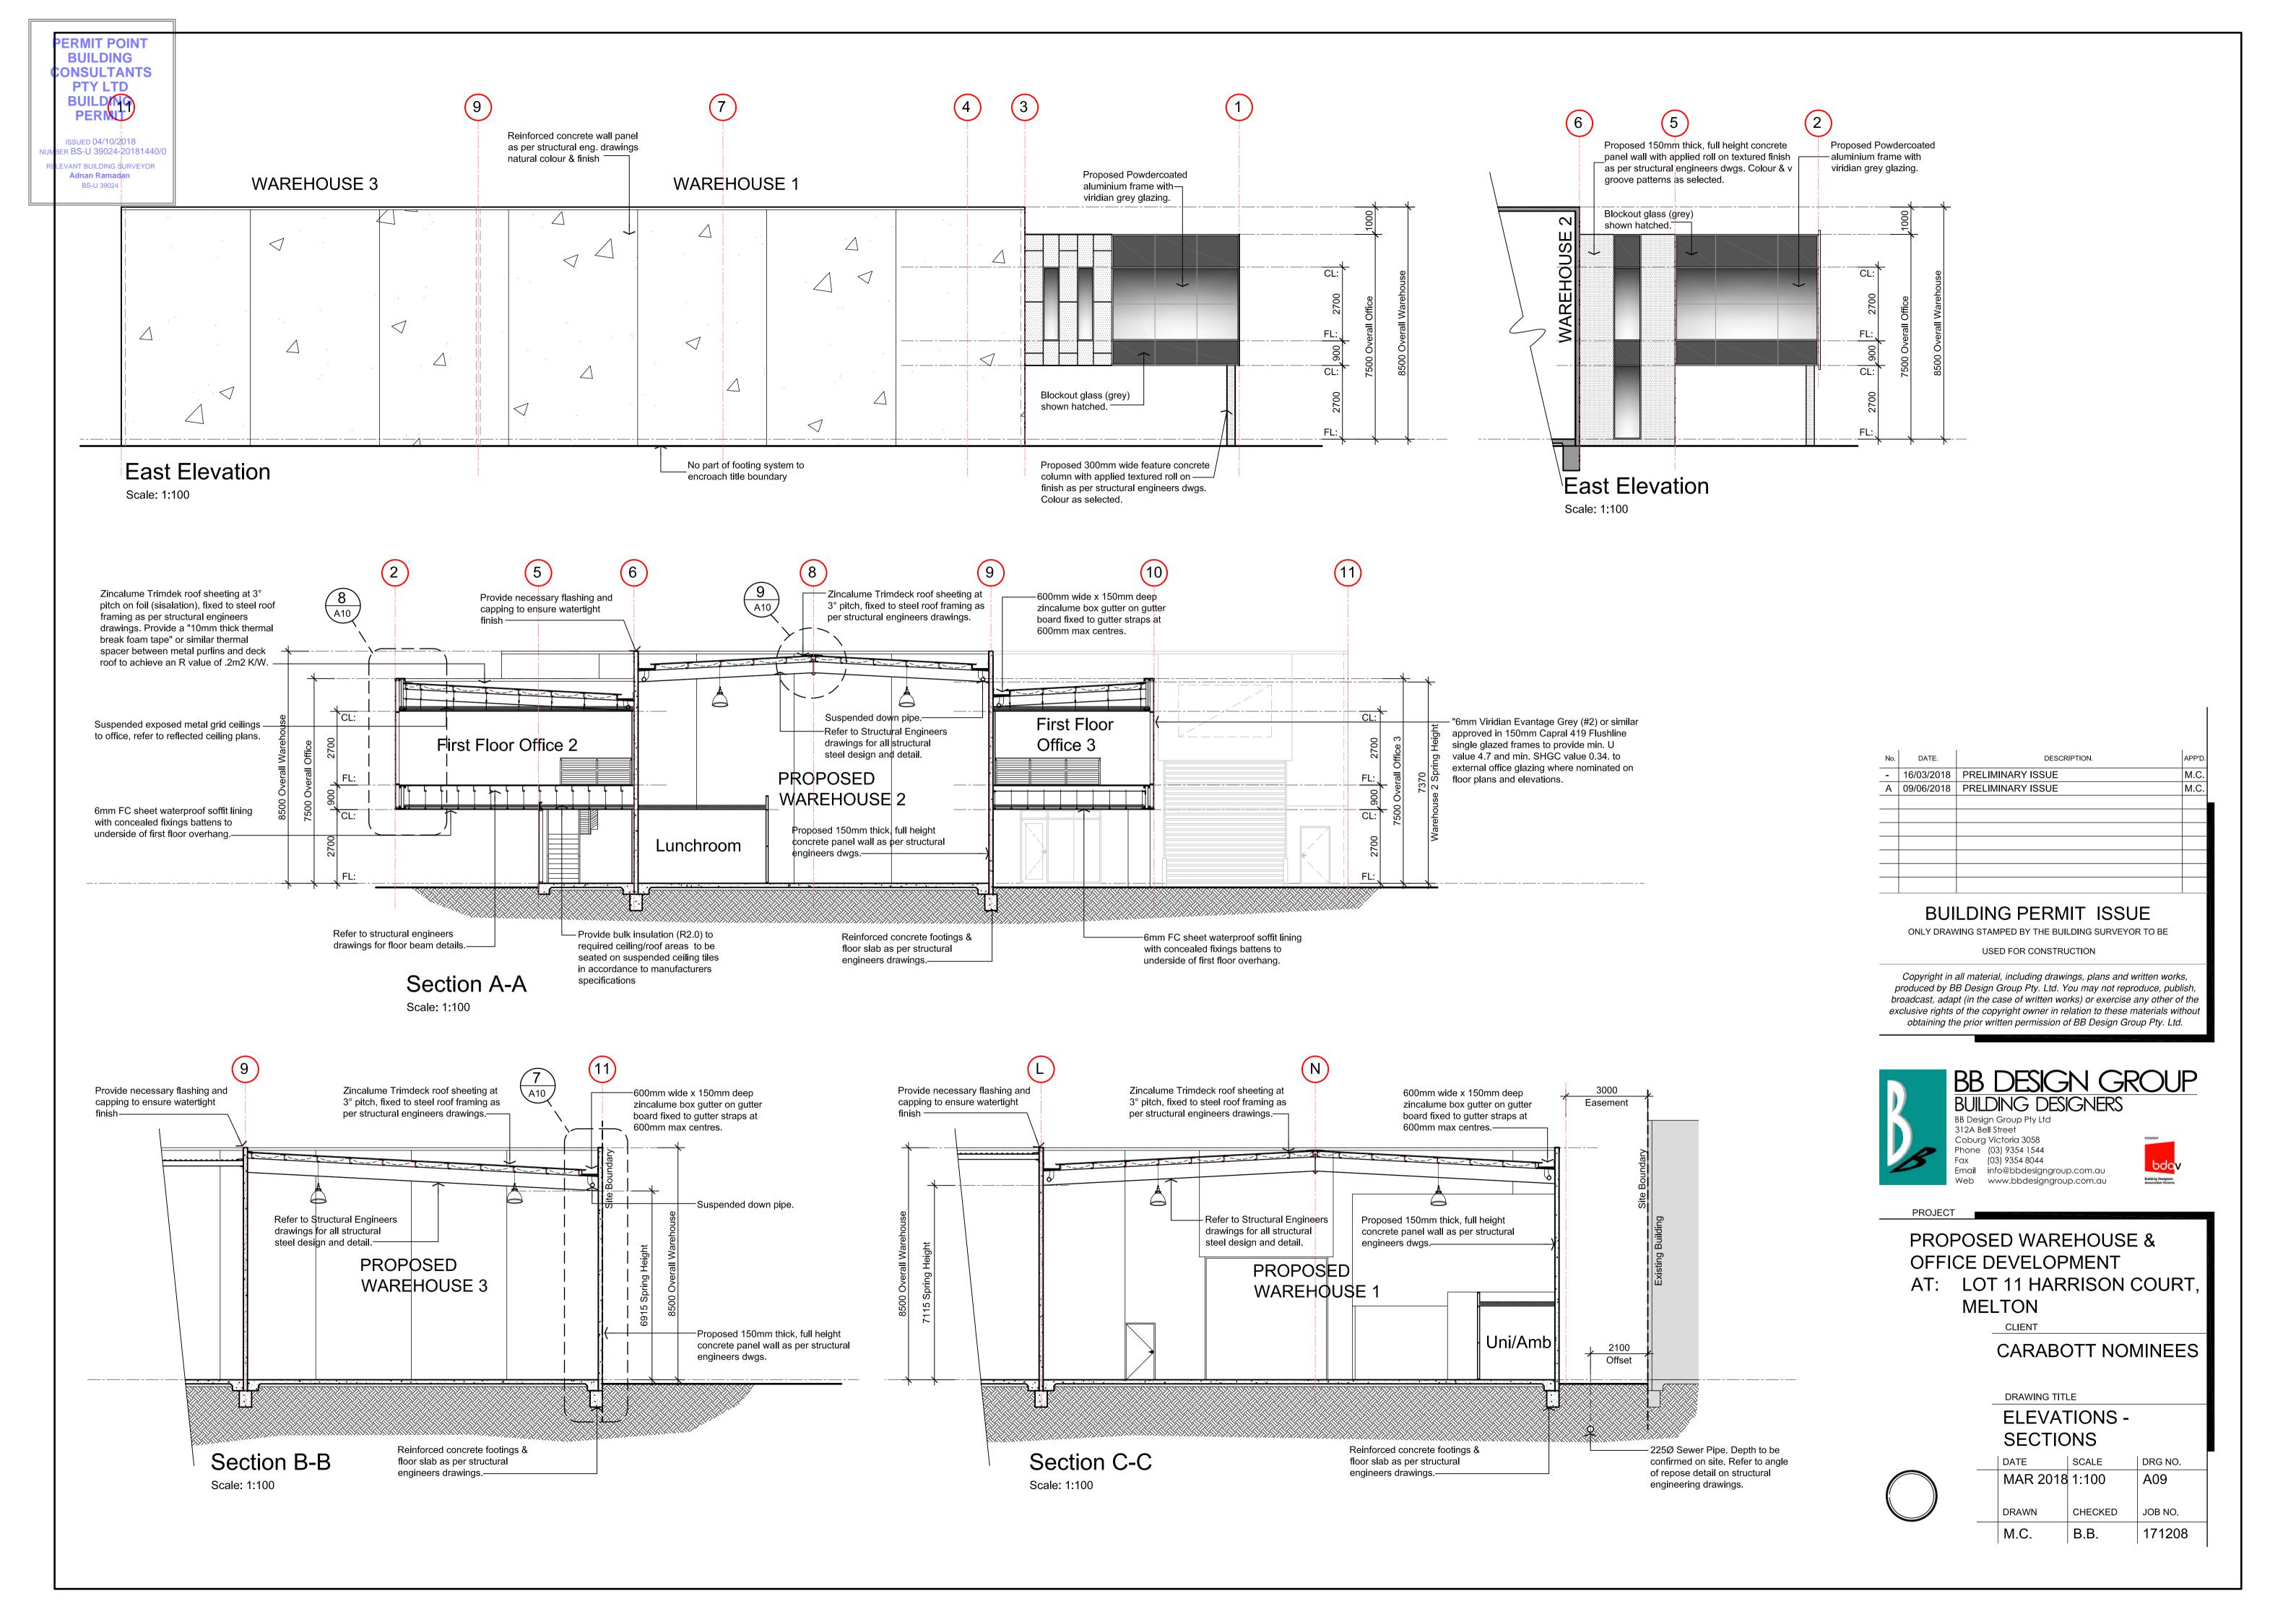
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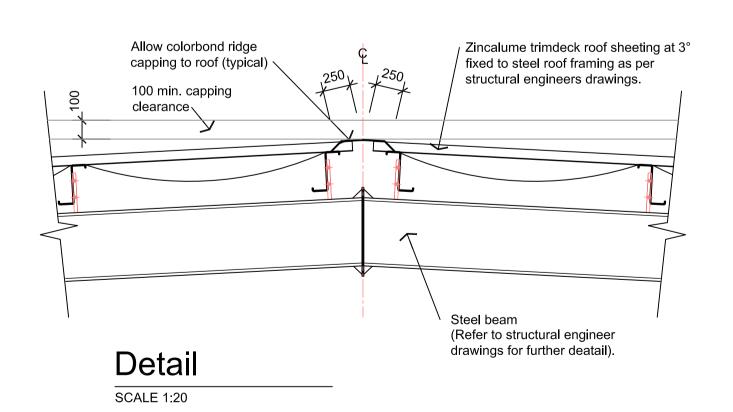


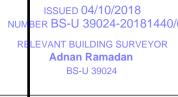

Typical Stair Detail

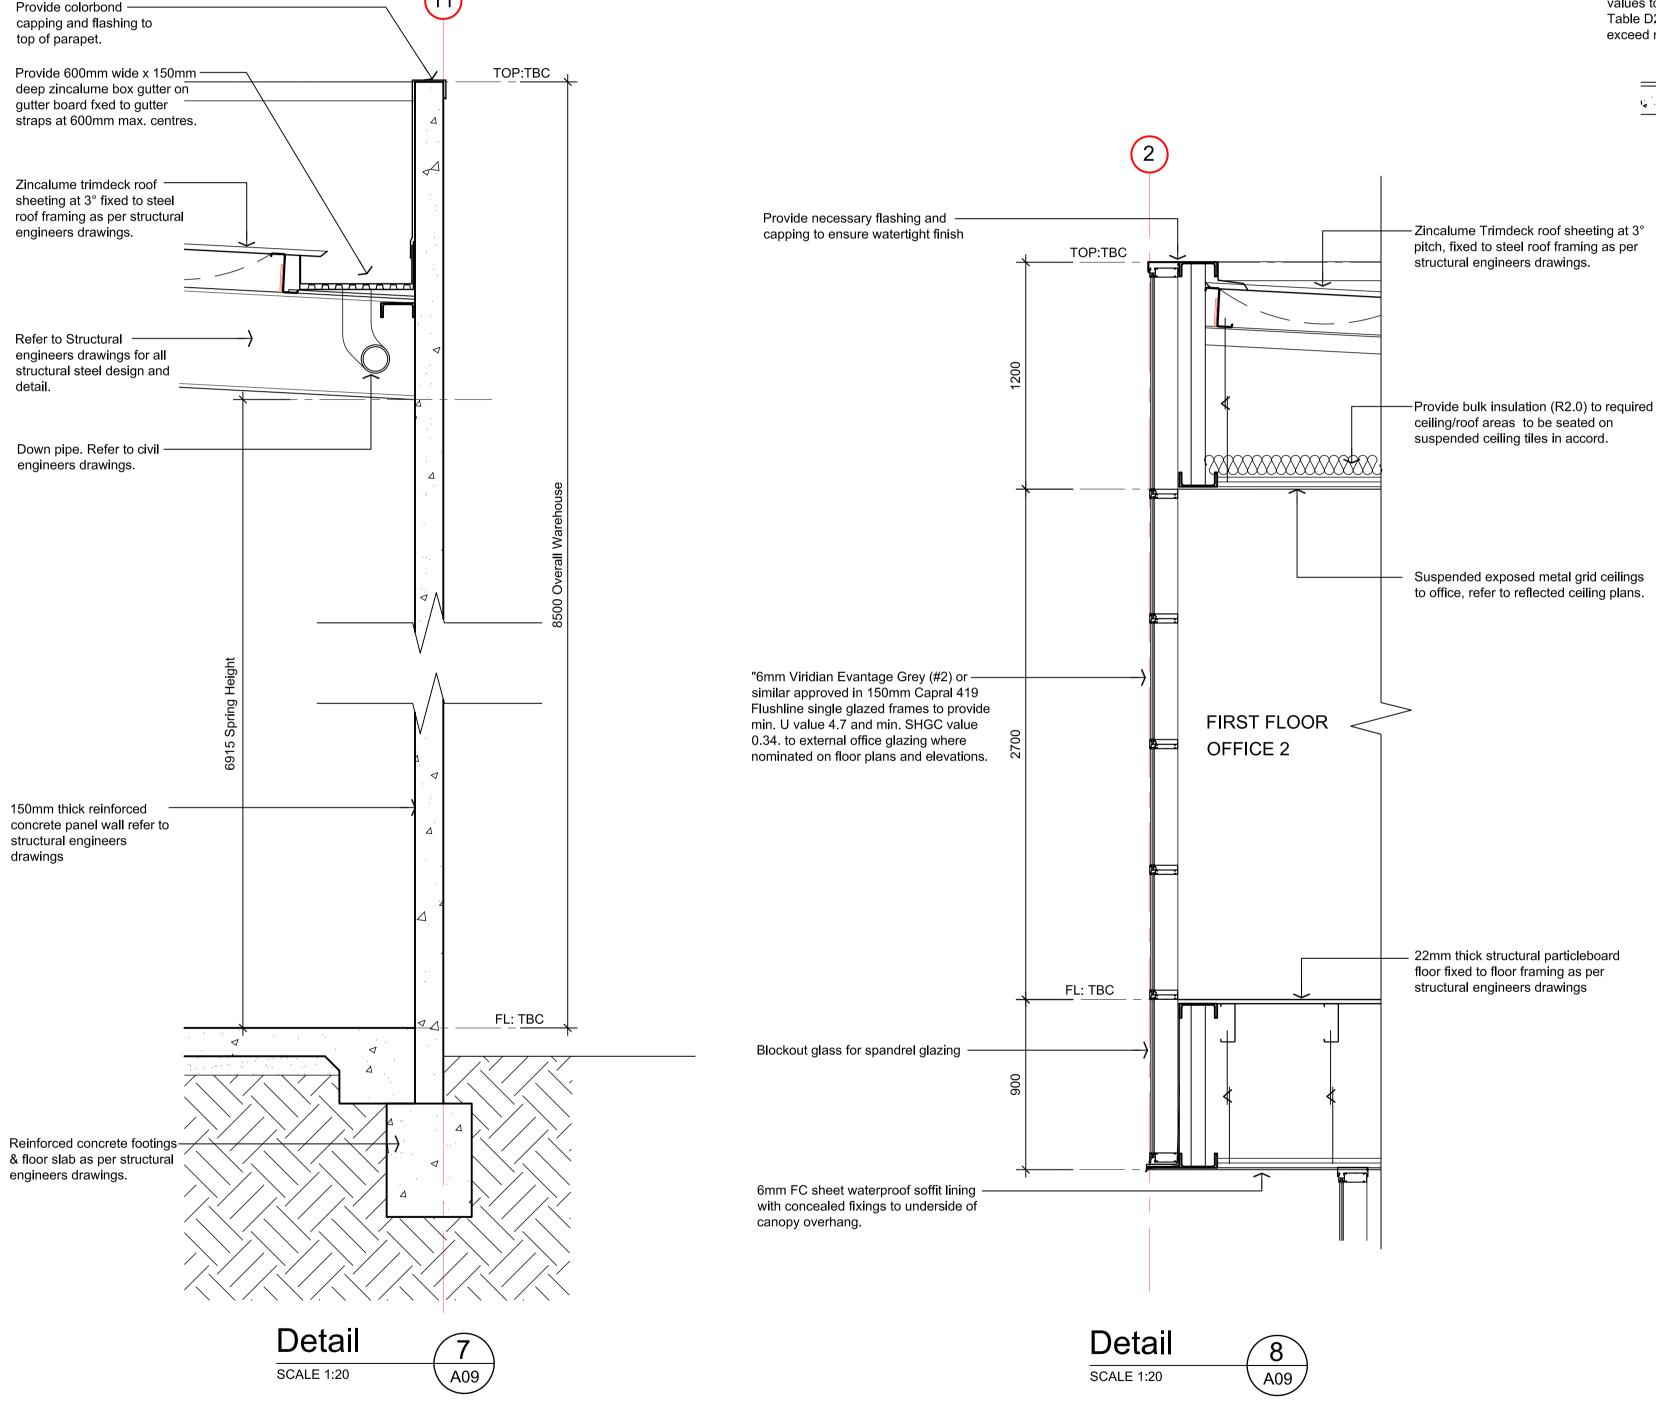

Typical Balustrade Detail

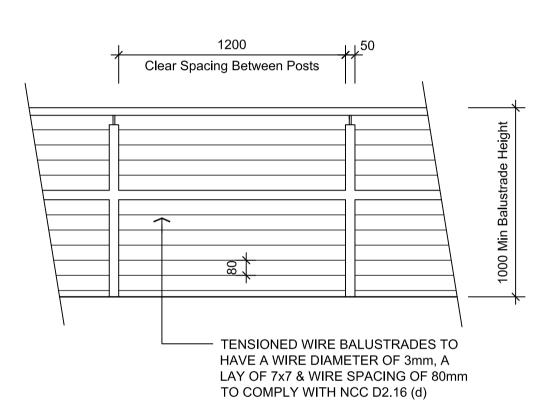

Stair Note:

REQUIRED STAIR/ STEP NOSINGS

ENSURE THAT STAIR NOSINGS HAVE A 50mm HIGH / WIDE COLOURED STRIP OF A COLOUR CONTRASTING TO THE BACKGROUND COLOUR AND TACTILE STRIPS OF GROOVES SET 300mm EACH SIDE OF THE STEP OR STAIR (AND RAMP WHERE FALL IS GREATER THE 1:20)

ENSURE THAT STAIR TREADS HAVE OPAQUE RISERS IN ACCORD. WITH AS 1428.1:2009

STEP SIZES (OTHER THAN FOR SPIRAL STAIRS) TO BE:-RISERS (R) 190mm MAXIMUM AND 115mm MINIMUM GOING (G) 355mm MAXIMUM AND 250mm MINIMUM 2R + 1G = 700mm MAXIMUM AND 550mm MINIMUM 125mm MAXIMUM GAP TO OPEN TREADS

ALL INTERNAL STEPS, LANDINGS AND THE LIKE TO HAVE A SLIP RESISTANCE OF P3 OR R10. ALL INTERNAL STAIR NOSING STRIPS TO HAVE A SLIP RESISTANCE OF P3 IN ACCORDANCE WITH AS 4586

PROVIDE BALUSTRADES WHERE CHANGE IN LEVEL EXCEEDS 1000mm ABOVE THE SURFACE & BENEATH BALUSTRADES TO BE:-1000mm MIN. ABOVE BALCONIES, LANDINGS OR THE LIKE, AND 865mm MIN. ABOVE STAIR NOSING OR RAMP, AND VERTICAL WITH A 125mm MAXIMUM GAP BETWEEN.

HAND RAILS TO BE 1000MM MINIMUM ABOVE STAIR NOSING HANDRAILS ARE REQUIRED ON BOTH SIDES OF THE STAIR AND WITH 300MM EXTENSIONS AT TOP AND BOTTOM AS SHOWN.


THE WIDTH OF A FLIGHT OF STAIRS (MEASURED CLEAR OF HANDRAILS & OBSTRUCTIONS) SHALL

BE 1000MM MIN. AND CONSTANT.

THE MINIMUM HEAD ROOM CLEARANCE TO BE 2000mm.

TACTILE INDICATORS ARE REQUIRED AT THE TOP, BOTTOM & LANDINGS OF THE STAIR FOR VISION IMPAIRED PEOPLE. REFER TO FLOOR PLANS FOR LOCATION.

TENSIONED WIRE BALUSTRADES TO HAVE A WIRE DIAMETER OF 3mm, A LAY OF 7x7, WIRE SPACING OF 80mm AND A CLEAR DISTANCE OF 1200mm BETWEEN POSTS AND COMPLY WITH NCC D2.16 (d)

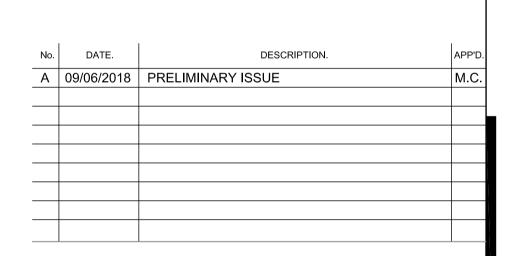

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PROPOSED WAREHOUSE & OFFICE DEVELOPMENT


AT: LOT 11 HARRISON COURT


MELTON

CARABOTT NOMINEES

DRAWING TITLE

DETAILS

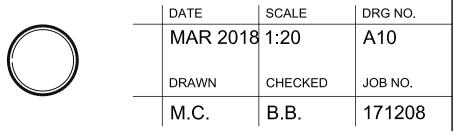

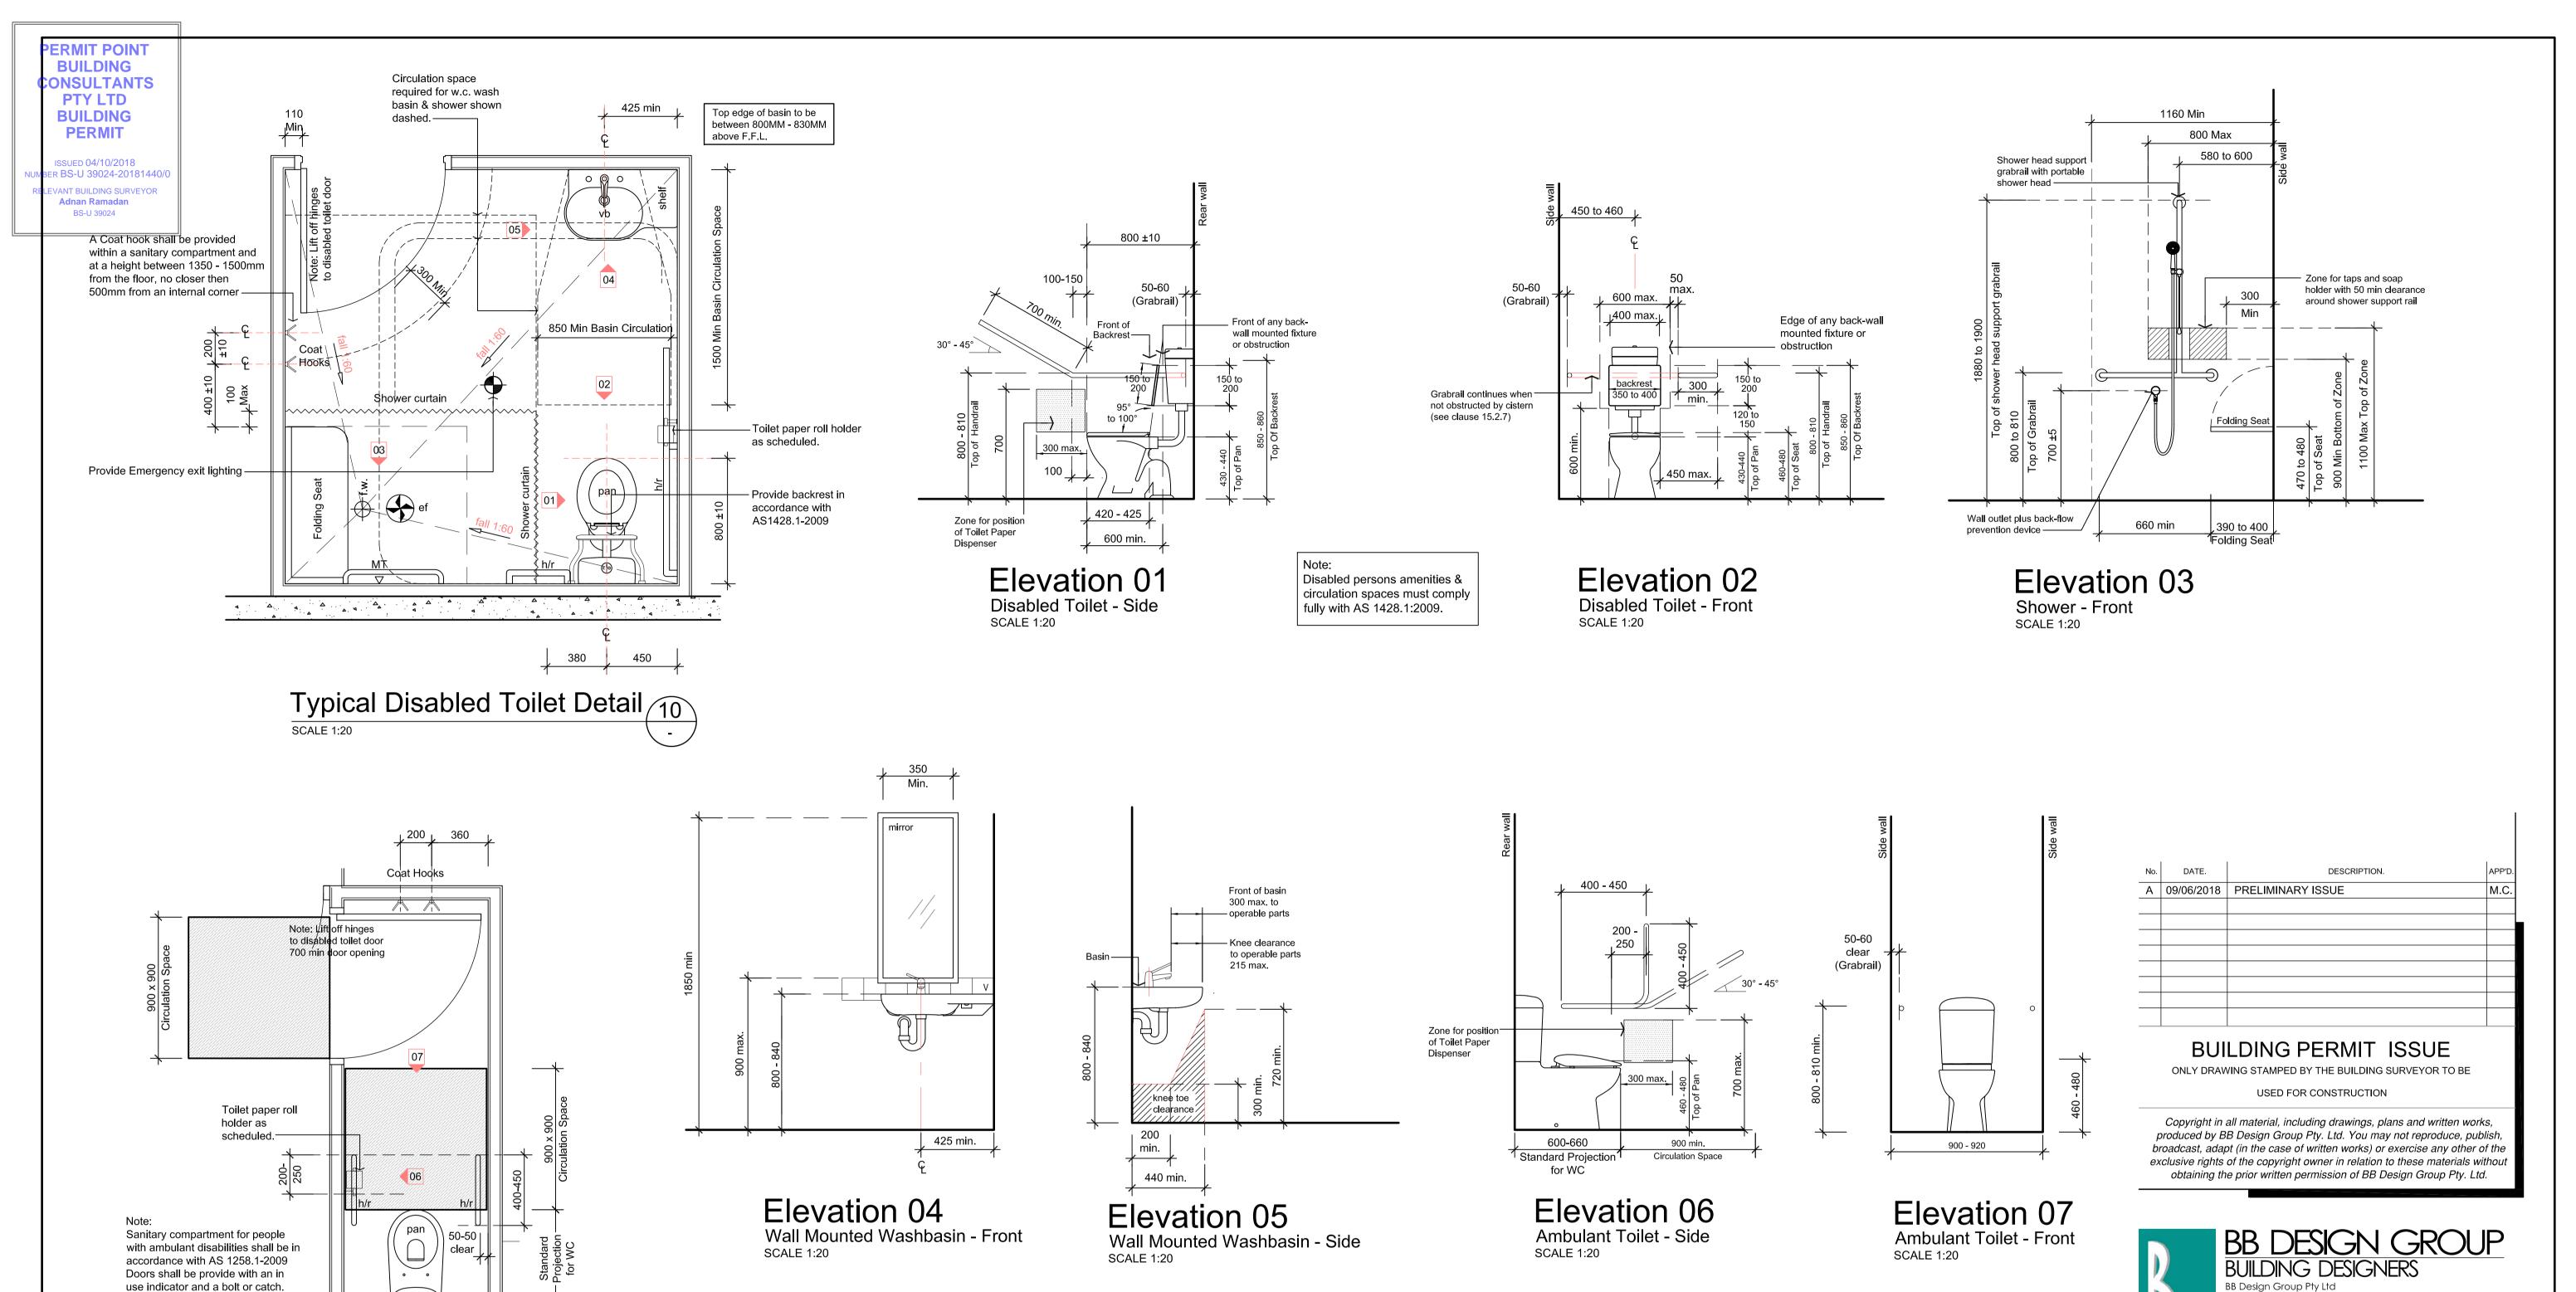



PROPOSED WAREHOUSE & OFFICE DEVELOPMENT

AT: LOT 11 HARRISON COURT

MELTON


CARABOTT NOMINEES

DRAWING TITLE

ACCESSIBLE & AMBULANT WC DETAILS



DATE	SCALE	DRG NO.
MAR 2018	AS	A11
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DRAWN	CHECKED	JOB NO.
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Where snib catch is used, the snib

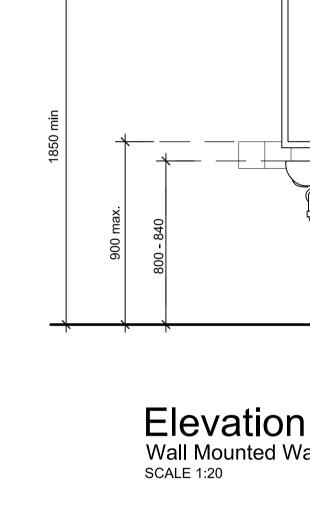handle shall have a minimum length

spindle. In an emergency, the latch

mechanism shall be openable from

900 - 920


Typical Ambulant Toilet Detail 11

of 45mm from the center of the

the outside

Shower areas must;

- Have waterproof floors for the shower area, and - Have waterproof walls to a height the greater of
 - Not less than 150mm above the floor substrate or, - Not less than 25mm above the maximum retained water level and,
- Be water resistant walls in the shower area to not less than 1800mm above finished floor level of the shower, and
- Be waterproof wall and wall/floor junctions within the shower area, and - Be waterproof any penetrations in the shower area.
- Walls adjoining sinks must; - Be water resistant to a height not less thank 150mm above
- the sink for the extent of the sink Water closet areas must;
- Have a water resistant floor, and - Have a waterproof wall/floor junctions

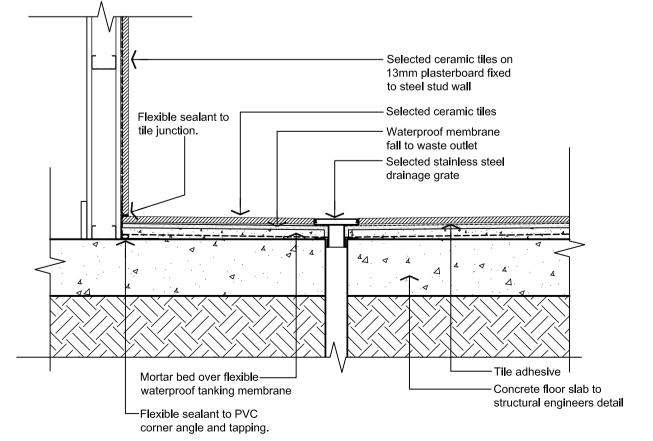

Typical Shower Waterproofing Detail

PGENERAL NOTES FOR BCA SECTION J COMPLIANCE:

11. BUIDING FABRIC

ALL REQUIRED INSULATION TO COMPLY WITH AS4859.1 AND BE INSTALLED THAT:

OVERLAPS ADJOINING INSULATION FORMS CONTINIUOS BARRIER WITH CEILING, WALLS, BULKHEADS FLOORS AND THE LIKE DOES NOT AFFECT THE SAFE EFFECTIVE OPERATION OF

SERVICES OR FITTINGS. REFLECTIVE INSULATION MUST BE CLOSE FITTING AGAINST ANY PENETRATION. DOOR OR WINDOW AND ADEQUATELY SUPPORTED BY FRAMING MEMBERS. (REFER TO MANUFACTURES SPECIFICATION) INSTALLED WITH EACH ADJOINING SHEET OF ROLL MEMBRANE BEING OVERLAPPED NOT LESS THAN 50MM

OR TAPED TOGETHER. BULK INSULATION IN ROOF SPACE MUST BE INSTALLED TO MAINTAIN ITS POSITION AND THICKNESS. OTHER THAN WHERE IT CROSSES BATTERNS, WATER PIPES, ELECTRICAL CABLING OR THE LIKE.

ALL ROOF LIGHTS TO WAREHOUSE TO COMPLY WITH PART J1.4 AND PROVIDE A MINIMUM U-VALUE OF 1.3w/m2 AND SHGC OF .25 (REFER TO MANUFACTURES SPECIFICATION.)

ALL REQUIRED EXTERNAL WALLS TO BE FITTED WITH "RETROSHEILD" OR SIMILAR INSULATION TO ACHEIVE MIN R2.8 VALUE IN ACCORDANCE WITH PART J1.5 OF BCA. TO BE FITTED IN ACCORD. WITH MANUFACTURES SPECIFICATION.

J2. EXTERNAL GLAZING.

PROVIDE SINGLE LEAF GLAZING-OR SIMILAR TO PROVIDE MIN. U VALUE AND MIN. SHGC VALUE, ALL EXTERNAL OFFICE GLAZING. AS PER THE LEGEND BELOW.

ALL GLAZING TO BE IN ACCORDANCE WITH AS1288-1999 AND AS2047.

J3. BUILDING SEALING. ALL WINDOWS TO COMPLY WITH AS 2047.

ROOFS, EXTERNAL WALLS, EXTERNAL FLOORS AND ANY OPENINGS SUCH AS A WINDOW, DOOR OR THE LIKE SHALL BE ENCLOSED BY INTERNAL LINING SYSTEMS THAT ARE CLOSE FITTING AT CEILING, WALL AND FLOOR JUNCTIONS OR SEALED BY CAULKING, SKIRTING, ARCHITRAVES, CORNICES OR THE LIKE IN ALL CONDITIONED SPACES.

SELF CLOSING DEVICE TO MAIN ENTRANCE DOORS IF MANUALLY OPERATED. PROVIDE RUBBER COMPRESSIBLE STRIP SEALS OR SIMILAR TO ENTIRE PERIMETER OF DOOR FRAMES EXCLUDING FIRE OR SMOKE DOORS.

ALL EXHAUST FANS SHALL BE FITTED WITH SELF CLOSING DAMPER OR SIMILAR APPROVED

J4. AIR MOVEMENT.

NOT APPLICABLE

J5. HVAC SYSTEMS.

AIR CONDITIONING AND VENTILATION SYSTEMS TO COMPLY WITH PART J5 OF THE BCA 2014. MECHANICAL ENGINEER/CONTRACTOR TO PROVIDE BUILDING SURVEYOR WITH CERTIFICATE OF COMPLIANCE.

J6. ARTIFICIAL LIGHTING AND POWER

ARTIFICIAL LIGHTING AND POWER SYSTEMS TO COMPLY WITH PART J6 OF THE BCA 2014. ELECTRICAL ENGINEER/CONTRACTOR TO PROVIDE BUILDING SURVEYOR WITH CERTIFICATE OF COMPLIANCE.


NOTE: INSTALL ALL LIGHTING POWER CONTROL DEVICES INCLUDING TIMERS, TIME SWITCHES, MOTION DETECTORS AND DAYLIGHT CONTROL DEVICES IN ACCORDANCE WITH J6.1-6.6 AND SPECIFICATION J6 OF THE BCA.

ARTIFICIAL LIGHTING TO THE EXTERNAL PERIMETER OF THE BUILDING TO BE CONTROLLED BY DAYLIGHT SENSORS AND HAVE A MAX 40LUMENS/W.


Wall Legend

to ceiling)


- (P1) 150mm Thick Concrete Panel Wall 150mm Thick Concrete Panel Wall with "Foil Board Ultra 20-" insulation Panel or similar to all external walls only to achieve R2.8 min. Refer to detail for further information. (floor
- Solid partition internal walls (metal stud & plasterboard) to 2700mm high (floor
- Solid partition external walls (metal stud & plasterboard) full height with "Bulk Insulation" b/w studs or similar. Provide compressed sheet and alucobond cladding as noted on the elevations.
- "6mm Viridian Evantage Grey (#2) or similar approved in 150mm Capral 419 Flushline single glazed frames to provide min. U value 3.8 and min. SHGC value 0.41. to external office glazing where nominated on floor plans and elevations.

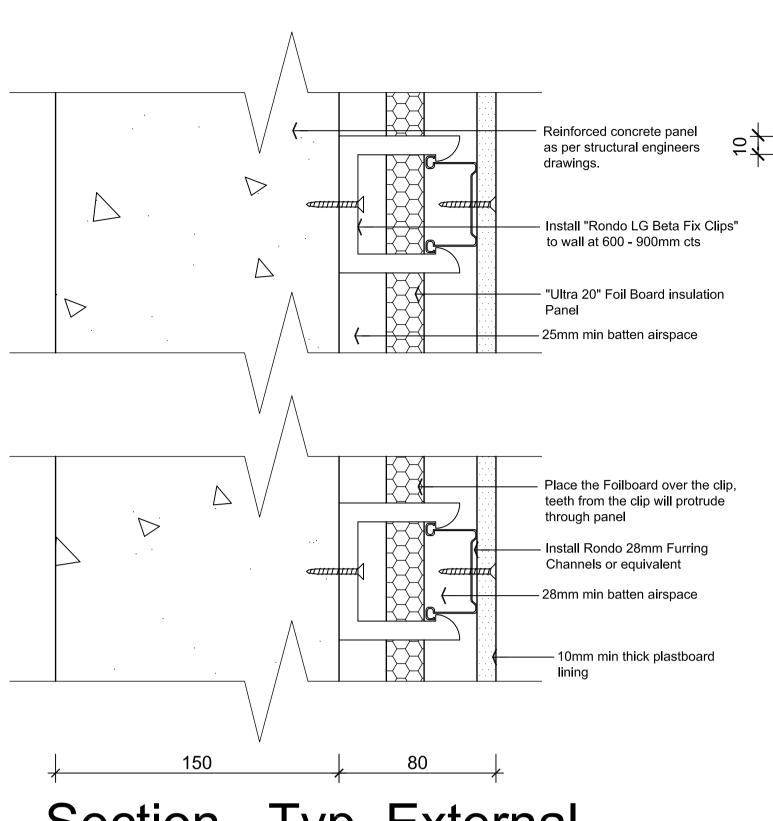


Section - Typ. External Wall Treatment "P2"

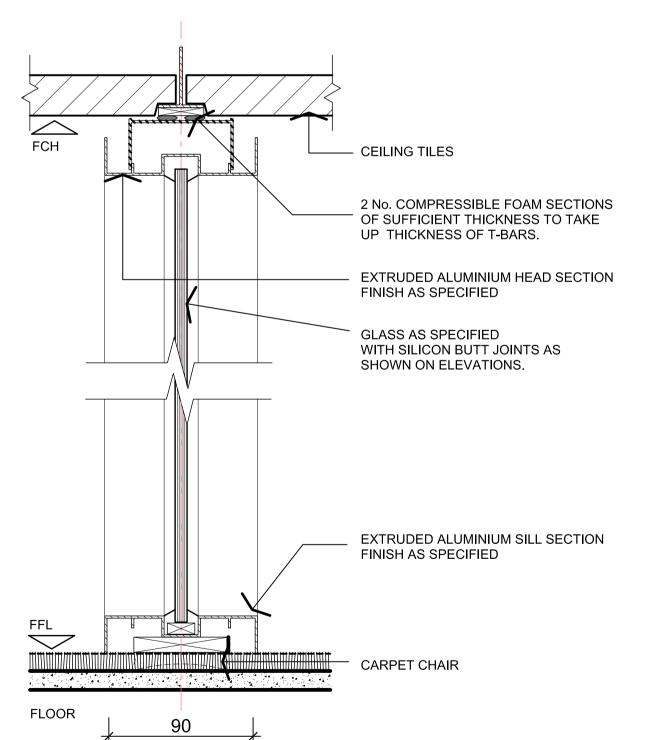


Section - Glazed Partition "G2"

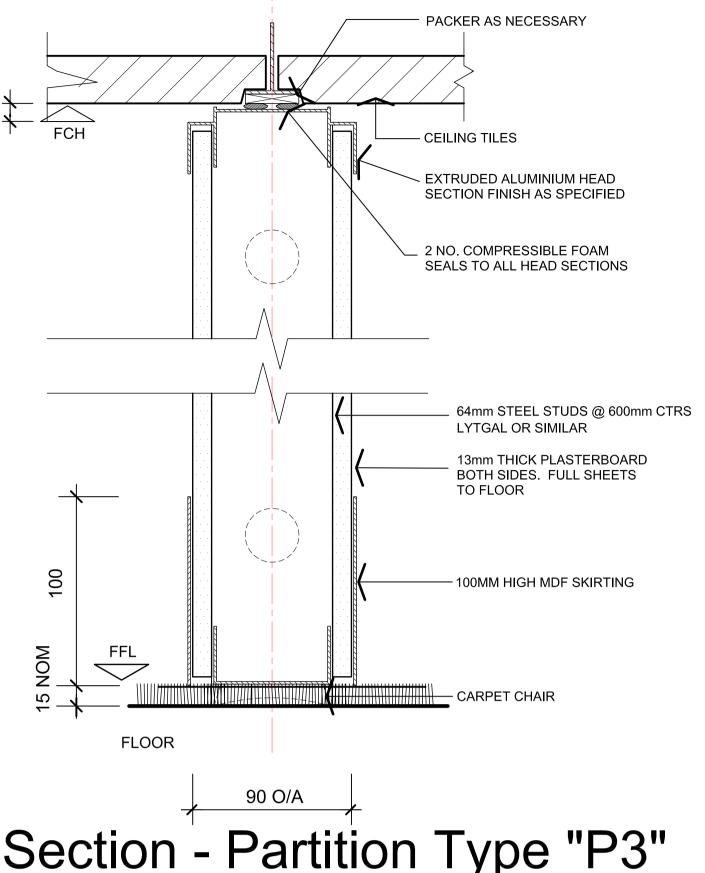


Section - Partition Type "P3"

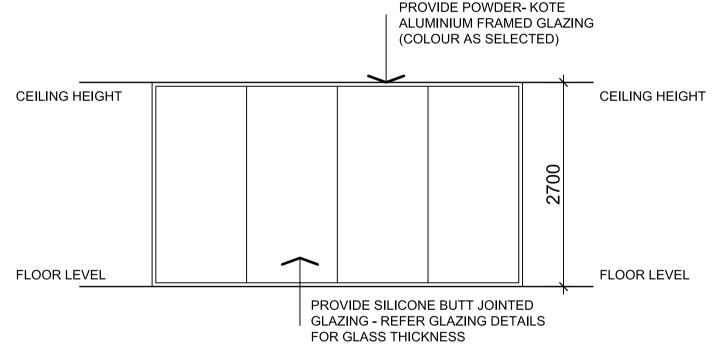



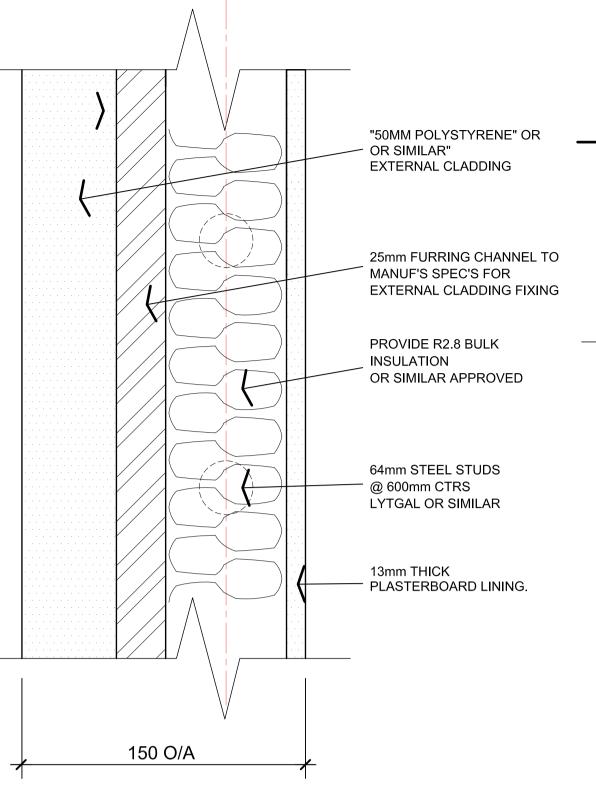

Section - Typ. External Wall Treatment "P4"

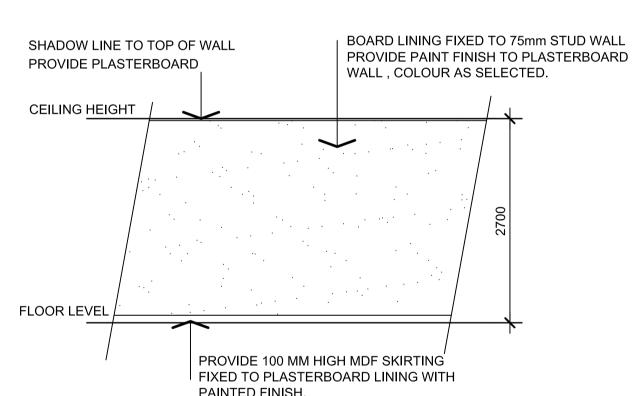

Full height Plasterboard lined partition Wall (P2/3)

—Stainless steel sink to builders range. Wall tiles to spec's. — Ceasarstone bench top to builders range. Laminated cupboard doors to builders range. Bench to sit on stainless steel kicker to manuf's −Dishwasher in Under Bench spec's. _ position shown

Indicative Tea Room **Bench Elevation**

PROVIDE 13 MM THICK PLASTER

Plan Detail -

Wall Junction

Perimeter

COMPRESSABLE FOAM TAPE SEAL

10mm TIMBER SHADOWLINE

LINE OF PERIMETER WALL

PLASTERBOARD PARTITION


PROVIDE R2.5 CSR. SOUNDSCREEN

INSULATION OR SIMILAR APPROVED

BLACK PAINT FINISH

25mm MDF CAPPING

PIECE AND FILLER

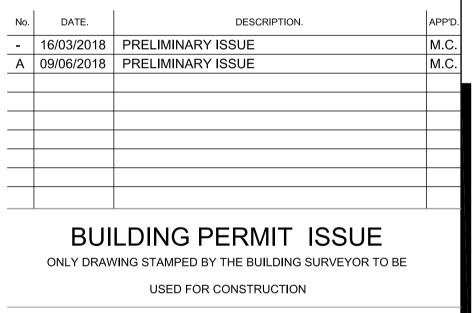

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PROPOSED WAREHOUSE & OFFICE DEVELOPMENT AT: LOT 11 HARRISON COURT **MELTON CARABOTT NOMINEES** DRAWING TITLE WALL TYPE & PART J **COMPLIANCE NOTES** DATE SCALE MAR 2018 AS A12 SHOWN CHECKED JOB NO. DRAWN 171208 M.C.



