


SUBDIVISION PLAN SCALE 1:200







						Project.	PROPOSED NEW RESIENCE AT LOT 1 PLOUGHMANS ESTATE	Job No. 23-044
7							ORANGE NSW 2800	Dwg No. 01 Issue.
	No.	Description			Date	Title.	SUB-DIVISION PLAN	Drawings 06
	Scale:	S NOTED @ A3.	Drawn: J.B.	Date: 31	/08/2023	Client.	CONTEMPORARY HOMES	© - Bassmann Drafting Services

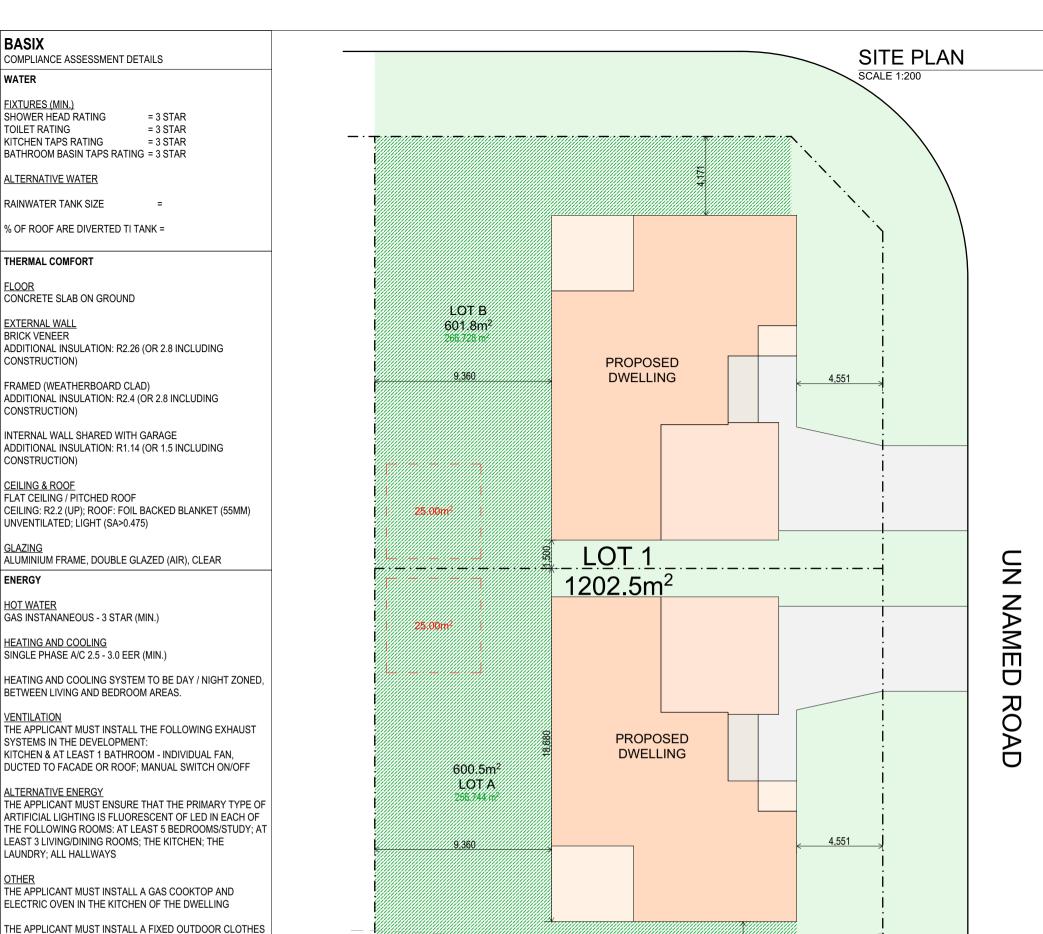

EASMENT TO DRAIN SEWAGE & WATER








23-044

02

AREAS 145.0m² (15.6sq) 38.4m² (4.1sq) 17.4m² (1.9sq) 3.3m² (0.4sq) FLOOR AREA: GARAGE: ALFRESCO: PORCH: TOTAL: 204.1m² (22.0sq)

FLOOR PLAN - LOT A

SCALE 1:100

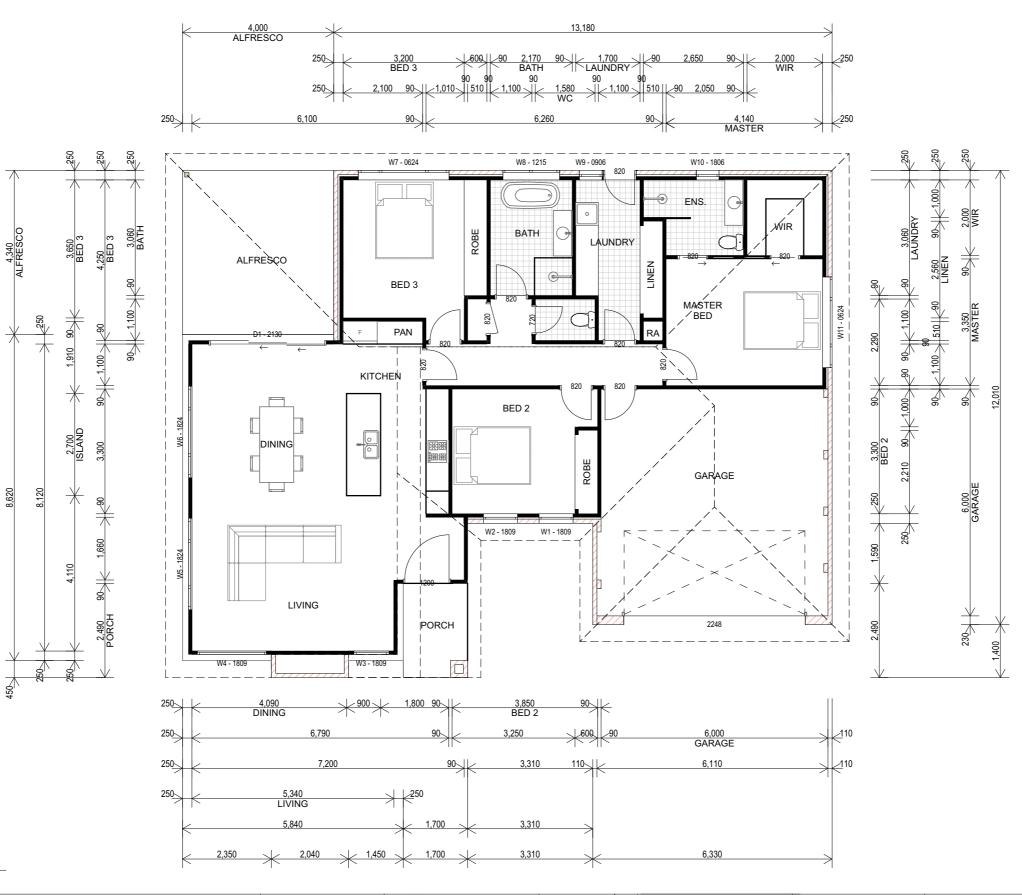

MECHANICAL VENTILATION:
A MECHANICAL VENTILATION SYSTEM
COMPLYING WITH AS 1668.2 & AS / NZS 3666.1
MUST BE INSTALLED TO ANY HABITABLE ROOM
WHICH DOES NOT HAVE NATURAL
VENTILATION COMPLYING WITH PART H4P5 OF
THE NCC

WC DOOR NOTE:
INWARD SWINGING WC DOORS TO BE READILY
REMOVABLE FROM THE OUTSIDE OF THE
SANITARY COMPARTMENT IN ACCORDANCE
WITH PART F4D8 OF THE BCA

DENOTES THE LOCATION OF SMOKE
ALARMS IN ACCORDANCE WITH PART
H3D6 OF THE NCC. SMOKE ALARMS
MUST COMPLY WITH AS 3786.

STAIR NOTE: NEW STAIRS BUILT IN ACCORDANCE WITH THE REQUIREMENTS OF PART D3 OF THE NCC 2022.

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23-044

RISERS = MAX.-190mm MIN.- 115mm GOING = MAX.-355mm MIN.- 250mm 2R + G = MAX.-700mm MIN.- 550mm Job No.


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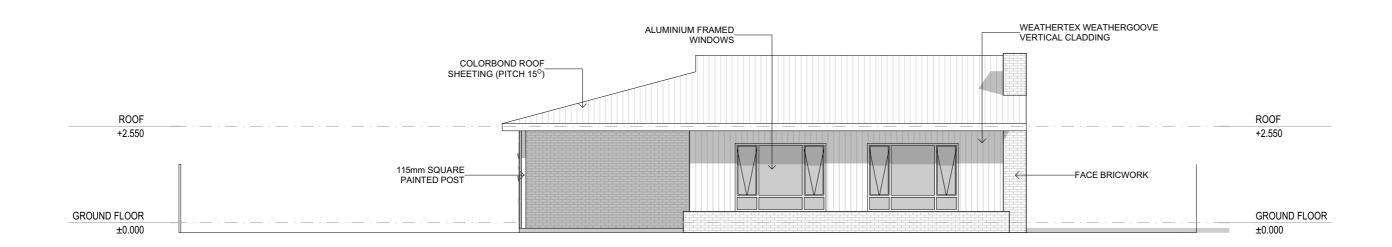
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					Project	PROPOSED NEW RESIENCE AT LOT 1 PLOUGHMANS ESTATE ORANGE NSW 2800	Job No. Dwg No. 03
No. Amendi	Description			Date	Title.	LOT A FLOOR PLAN	Drawings 14
		Drawn: J.B.	Date: 31	/08/2023	Client.	CONTEMPORARY HOMES	© - Bassmann



NORTH ELEVATION SCALE 1:100



EAST ELEVATION

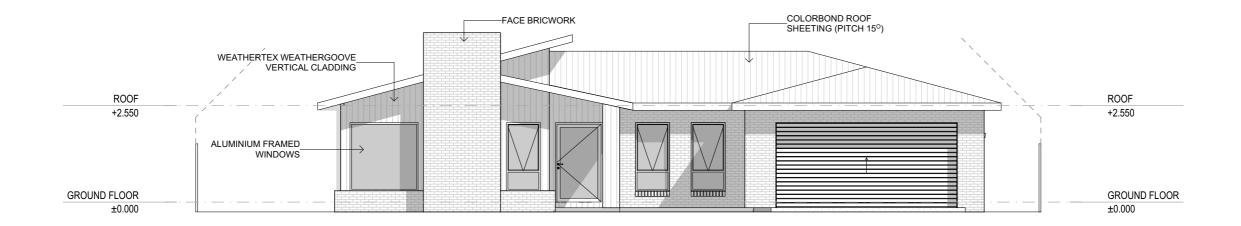
SCALE 1:100



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BUILDING DESIGNERS ASSOCIATION OF AUSTRALIA


CONTEMPORARY HOMES Excellence in Quality and Design

-						Project.	PROPOSED NEW RESIENCE AT LOT 1 PLOUGHMANS ESTATE	Job No.	23-044
F							ORANGE NSW 2800	Dwg No. 04	Issue.
2	No.	Description			Date	Title.	=: =: /A =: 0.10	Drawings 14	
1	Amendments		·				ELEVATIONS	in set: 14	
5	Scale:	S NOTED @ A3.	Drawn: J.B.	Date: 31/	/08/2023	Client.	CONTEMPORARY HOMES	© - Bassmann	Drafting Services

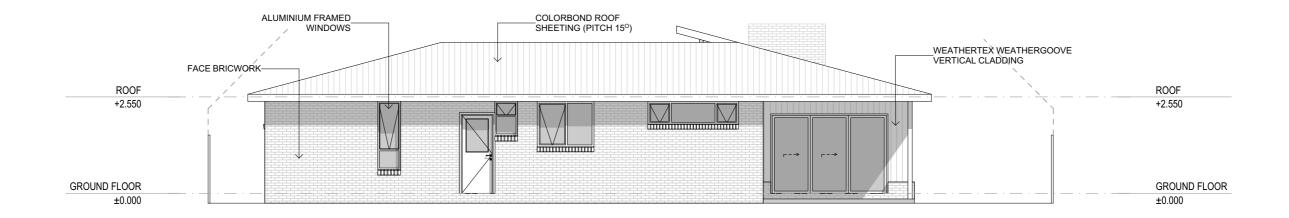

SOUTH ELEVATION

SCALE 1:100

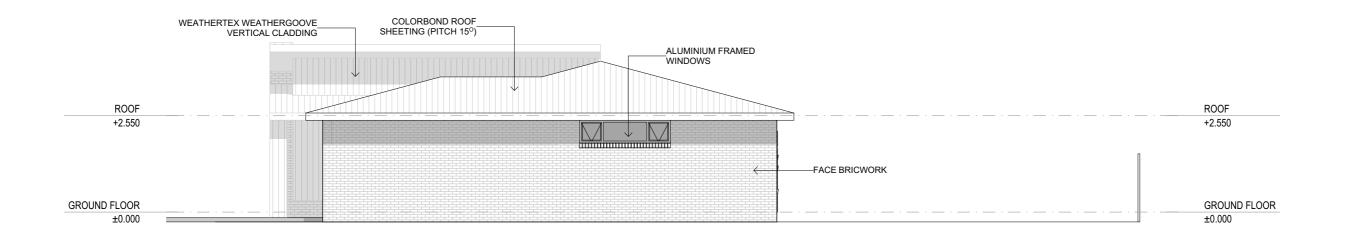

WEST ELEVATION

SCALE 1:100







14	

F						Project.	PROPOSED NEW RESIENCE AT LOT 1 PLOUGHMANS ESTATE	Job No.	23-044
F							ORANGE NSW 2800	Dwg No. 05	Issue.
2	No.	Description			Date	Title.	EL EL/ATIONIO	Drawings 14	
1	Amendr	ments					ELEVATIONS	in set:	
٤	Scale:	S NOTED @ A3.	Drawn: J.B.	Date: 31	/08/2023	Client.	CONTEMPORARY HOMES	© - Bassmann	Drafting Services

WINDOW NO.	D1 - 2130	W1 - 1809	W2 - 1809	W3 - 1809	W4 - 1809	W5 - 1824
W x H SIZE	3,100×2,100	900×1,800	900×1,800	900×1,800	1,800×1,800	2,400×1,800
FRAME	Aluminium	Aluminium	Aluminium	Aluminium	Aluminium	Aluminium
OPENING		Awning	Awning	Awning	Awning	Awning
GLAZING	Double / Clear					
EXTERNAL VIEW						

WINDOW NO.	W7 - 0624	W8 - 1215	W9 - 0906	W10 - 1806	W11 - 0624	W12 - 1809
W x H SIZE	2,400×600	1,500×1,200	600×900	600×1,800	2,400×600	900×1,800
FRAME	Aluminium	Aluminium	Aluminium	Aluminium	Aluminium	Aluminium
OPENING	Awning	Awning	Awning	Awning	Awning	Awning
GLAZING	Double / Clear					
EXTERNAL VIEW						

WINDOW SCHEDULE

GENERAL

- ALL DIMENSIONS ARE IN MILLIMETRES UNLESS NOTED OTHERWISE
- DO NOT SCALE FROM DRAWING, IF IN DOUBT ASK.
- ALL DIMENSIONS AND LEVELS ARE TO BE CONFIRMED ON SITE PRIOR TO CONSTRUCTION. IT IS THE RESPONSIBILITY OF THE BUILDER TO VERIFY DOCUMENTS AS TO THEIR ACCURACY
- THESE PLANS ARE TO BE READ IN CONJUCTION WITH ENGINEERS DETAILS.
- THE CONSTRUCTION OF ANY STAIRS & BALUSTRADES SHALL COMPLY WITH PART 3.9.1 OF THE
- ALL STRUCTURAL ELEMENTS ARE TO BE DESGNED BY A PRACTISING STRUCTURAL ENGINEER.
- CONCRETE SLAB & FOOTINGS TO BE DESIGNED IN ACCORDANCE WITH AS2870.
- ALL TIMBER USED IN THE DEVELOPMENT IS TO BE STRICTLY IN ACCORDANCE WITH THE PROVISIONS OF AS1684. NATIONAL TIMBER FRAMING CODE. UNLESS A CERTIFICATE FROM A PRACTISING STRUCTURAL ENGINEER IS SUBMITTED TO COUNCIL CERTIFYING THAT THE BUILDING HAS BEEN DESIGNED TO WITHSTAND THE MOST ADHERE COMBINATION OF LOADS TO WHICH IT WILL BE SUBJECTED

STATUTORY REQUIREMENTS

- ALL WORK TO BE CARRIED OUT IN ACCORDANCE WITH THE NCC. CONDITIONS IMPOSED BY THE LOCAL AUTHORITY & THE COMMITMENTS OUTLINED IN THE RELEVANT BASIX CERTIFICATE.
- THE BUILDER IS TO COMPLY WITH THE REQUIREMENTS OF THE LEGALLY CONSTITUTED AUTHORITIES HAVING JUROSDICTION OVER THE BUILDING WORKS & THE PROVISIONS OF THE HOME
- PRIOR TO COMMENCEMENT OF BUILDING WORK, THE BUILDER SHOULD PROVIDE TEMPORARY TOILET FACILITIES FOR THE USE OF SUBCONTRACTORS. WHERE THE LOCAL AUTHORITY REQUIRES TEMPORARY TOILET TO BE CONNECTED TO SEWER MAINS, THE ADDITIONAL COST SHALL BE TO THE OWNERS EXPENSE, ON COMPLETION THE BUILDER SHALL REMOVE AS REQUIRED.

WITH AS / NZS 3600.3

- NATIONAL CONSTRUCTION CODE (NCC) REQUIRMENTS:
 ALL EARTHWORKS SHALL BE IN ACCORDANCE WITH PART H1D3 OR AS DESIGNED BY A PRACTICING STRUCTURAL ENGINEER.
 - FOOTINGS AND SLABS SHALL BE IN ACCORDANCE WITH PART H1D4 OR AS DESIGNED BY A
 - PRACTICING STRUCTURAL ENGINEER.
 AN APPROPRIATE TERMITE MANAGEMENT SYSTEM SHALL BE PROVIDED IN ACCORDANCE WITH PART H1D3 AND MUST COMPLY WITH AS 3660.1.
 - ALL MASONRY WORK SHALL BE IN ACCORDANCE WITH PART H1D5 AND COMPLY WITH AS 3700 OR AS 4773.1 AND AS 4773.2.
 - ALL STEEL FRAMING SHALL BE DESIGNED AND CONSTRUCTED IN ACCORDANCE WITH EITHER NASH STANDARD RESIDENTIAL AND LOW-RISE STEEL FRAMING PART 1 AND PART 2, AS 4100 OR AS/NZS 4600.
 - ALL TIMBER FRAMING SHALL BE DESIGNED AND CONSTRUCTED IN ACCORDANCE WITH AS 1720.1, AS 1720.5, AS 1684 AND/OR AS 1860.2 AS APPROPRIATE.
 - ROOF TRUSSES SHALL BE DESIGNED IN ACCORDANCE WITH AS 1720 AND ERECTED, FIXED AND BRACED IN ACCORDANCE WITH MANUFACTURERS INSTRUCTIONS.
 - ALL STRUCTURAL STEEL MEMBERS SHALL BE DESIGNED BY A PRACTICING STRUCTURAL ENGINEER AND CONSTRUCTED IN ACCORDANCE WITH AS 4100.
 - ALL ROOF AND WALL CLADDING SHALL BE IN ACCORDANCE WITH PART H1D7.
 - ALL WINDOWS, GLAZED ASSEMBLIES AND GLAZED DOORS SHALL BE DESIGNED, CONSTRUCTED AND INSTALLED IN ACCORDANCE WITH AS 2047 AND AS 1288. - CLASS 1 BUILDING CONSTRUCTION IN A FLOOD HAZARD AREA SHALL BE \CONSTRUCTED IN
 - ACCORDANCE WITH THE ABCB STANDARD FOR CONSTRUCTION OF BUILDINGS IN FLOOD HAZARD AREAS
 - ALL DECKS/BALCONIES ATTACHED TO EXTERNAL WALLS USING A WHALING PLATE SHALL BE IN ACCORDANCE WITH PART H1D11.
 - ALL PILED FOOTINGS SHALL BE DESIGNED AND INSTALLED IN ACCORDANCE WITH AS 2159. A STORMWATER DRAINAGE SYSTEM SHALL BE DESIGNED AND CONSTRUCTED IN ACCORDANCE

- MAINS POWERED INTERCONNECTED SMOKE DETECTORS SHALL BE INSTALLED IN ACCORDANCE WITH PART H3D6 AND COMPLY WITH AS 3786.
- WATERPROOFING OF WET AREAS SHALL BE IN ACCORDANCE WITH PART H4D2 AND COMPLY WITH AS 3740.
- IF REQUIRED, ARTIFICIAL LIGHTING SHALL BE IN ACCORDANCE WITH PART H4D6 OR AS/NZS
- MECHANICAL VENTILATION SYSTEMS SHALL BE INSTALLED IN ACCORDANCE WITH AS 1668.2.
- IF REQUIRED, MECHANICAL VENTILATION SHALL BE PROVIDED TO SANITARY COMPARTMENTS, LAUNDRIES, KITCHENS AND BATHROOMS AND SHALL BE IN ACCORDANCE WITH PART H4D7(2).

PREFABRICATED TIMBER ROOF TRUSSES

PLASTERBOARD CORNICE

PLASTERBOARD LINING.

R2.5 (MIN.) WALL INSULATION

TIMBER WALL FRAMING

CONCRETE SLAB TO ENGINEERS DESIGN

SELECTED SKIRTING BOARD

R4.0 (MIN.)

CEILING INSULATION

WAFFLE POD

ROOF PITCH

22.5°

EAVE WIDTH

450

SELECTED ROOF SHEETING

GUTTER

FASCIA

F.C. SOFFIT LINING

SARKING

TIMBER BEAD

WEATHERTEX SELF-LOK WEATHERBOARDS

SARKING MATERIAL

PROVIDE WEEP HOLES AT 900mm CENTRES.

WATERPROOF MEMBRANE

'Z' FLASHING FACE BRICKWORK

FLASHING

D.P.C.

TYPICAL DETAIL

450mm EAVE - SCALE - 1:20

- PLIABLE BUILDING MEMBRANES INSTALLED TO EXTERNAL WALLS MUST COMPLY WITH AS 4200.1, BE INSTALLED IN ACCORDANCE WITH AS 4200.2, BE LOCATED ON THE EXTERIOR SIDE OF THE PRIMARY INSULATION LAYER AND HAVE A PERMEABILITY OF NOT LESS THAN 1.14 µg/N.s.
- CONDENSATION MANAGEMENT SHALL BE IN ACCORDANCE WITH PART H4D9
- STAIRWAYSAND RAMPS SHALL BE IN ACCORDANCE WITH PART H5D2. BARRIERS AND HANDRAILS SHALL BE IN ACCORDANCE WITH PART H5D3.
- HEATING APPLIANCES AND FIREPLACES SHALL BE INSTALLED IN ACCORDANCE WITH PART
- ALL PLUMBING WORK SHALL BE IN ACCORDANCE WITH THE PLUMBING CODE OF AUSTRALIA AND COMPLY WITH THE REQUIREMENTS OF THE RELEVANT SUPPLY AUTHORITY AND AS 3500 AND BE CARRIED OUT BY A LICENSED PLUMBER.
- ALL ELECTRICAL WORK SHALL COMPLY WITH THE REQUIREMENTS OF THE RELEVANT SUPPLY AUTHORITY AND AS 3000 AND BE CARRIED OUT BY A LICENSED ELECTRICIAN.
- ALL GAS INSTALLATIONS SHALL COMPLY WITH THE REQUIREMENTS OF THE RELEVANT SUPPLY AUTHORITY AND BE CARRIED OUT BY A LICENSED GAS FITTER.
- INSTALLATION OF WALL AND FLOOR TILES SHALL COMPLY WITH AS 3958.1
- DRIVEWAY ACCESS SHALL COMPLY WITH AS / NZS 2890 1












					Project.	PROPOSED NEW RESIENCE AT LOT 1 PLOUGHMANS ESTATE	Job No.	23-044
						ORANGE NSW 2800	Dwg No. 06	Issue.
No. Amenda	Description ments			Date	Title.	WINDOW SCHEDULE	Drawings 14	
Scale:	AS NOTED @ A3.	Drawn: J.B.	Date: 31	/08/2023	Client.	CONTEMPORARY HOMES	© - Bassmann I	Orafting Services

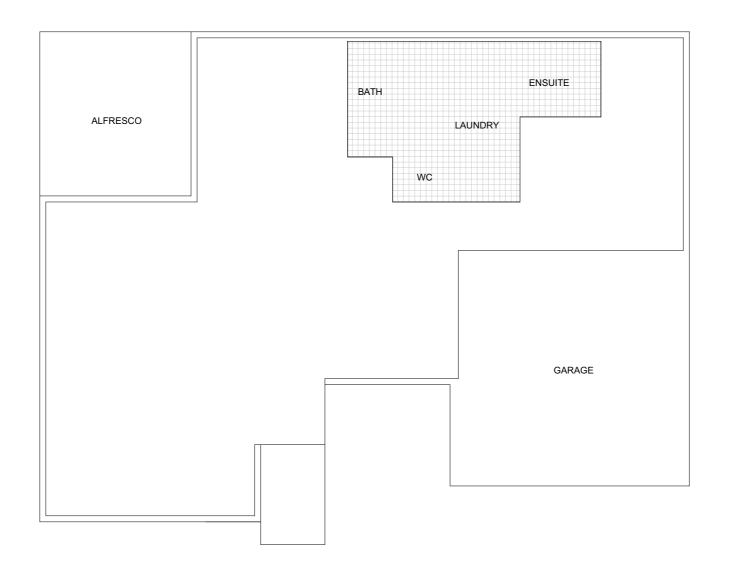

CONCRETE PLAN SCALE 1:100







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F					Project.	PROPOSED NEW RESIENCE AT LOT 1 PLOUGHMANS ESTATE	Job No.	23-044
						ORANGE NSW 2800	Dwg No. 07	Issue.
N	No.	Description		Date	Title.	CONODETE DI ANI	Drawings 14	
A	Amendi	ments				CONCRETE PLAN	in set:	
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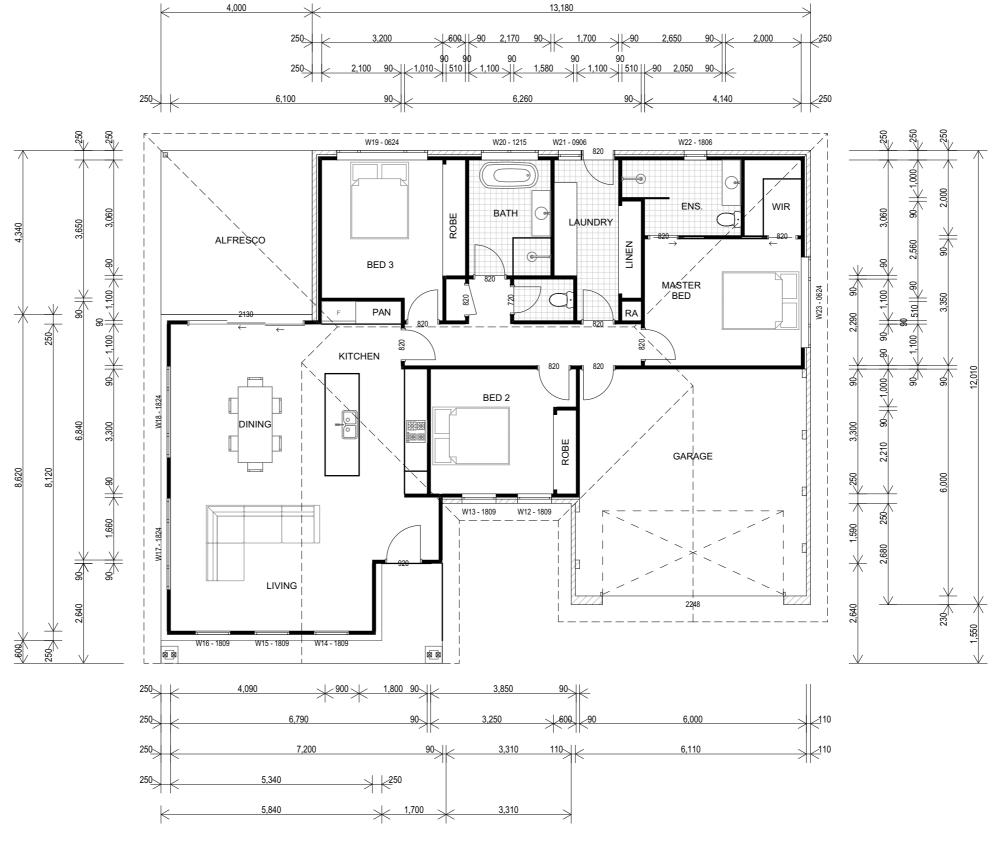


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-					Project.	PROPOSED NEW RESIENCE AT LOT 1 PLOUGHMANS ESTATE	Job No.	23-044
F						ORANGE NSW 2800	Dwg No. 08	Issue.
2	No.	Description		Date	Title.	\//=\//0	Drawings 14	
I	Amendr	ments				VIEWS	in set: 14	
5	Scale:	S NOTED @ A3. Drawn: J.B.	Date: 31	/08/2023	Client.	CONTEMPORARY HOMES	© - Bassmann	Drafting Services

AREAS

FLOOR AREA: 145.0m² (15.6sq) GARAGE: 38.4m² (4.1sq) ALFRESCO: 17.4m² (1.9sq) PORCH: 3.3m² (0.4sq) TOTAL: 204.1m² (22.0sq)



FLOOR PLAN - LOT B

SCALE 1:100



BUILDING DESIGNERS
ASSOCIATION OF AUSTRALIA

CONTEMPORARY HOMES Excellence in Quality and Design



						Project.	PROPOSED NEW RESIENCE AT LOT 1 PLOUGHMANS ESTATE ORANGE NSW 2800
	No.	Description			Date	Title.	LOT D EL COD DI ANI
N	Amenda	nents					LOT B FLOOR PLAN
14	Scale:	S NOTED @ A3.	J.B.	Date: 31/	08/2023	Client.	CONTEMPORARY HOMES

2022.

RISERS = MAX.-190mm
MIN.- 115mm
GOING = MAX.-355mm
MIN.- 250mm
2R + G = MAX.-700mm
MIN.- 550mm

2R + G = MAX - 700mm MIN - 550mm Job No. 23-044

MECHANICAL VENTILATION:
A MECHANICAL VENTILATION SYSTEM
COMPLYING WITH AS 1668.2 & AS / NZS 3666.1
MUST BE INSTALLED TO ANY HABITABLE ROOM
WHICH DOES NOT HAVE NATURAL
VENTILATION COMPLYING WITH PART H4P5 OF
THE NCC

WC DOOR NOTE:
INWARD SWINGING WC DOORS TO BE READILY
REMOVABLE FROM THE OUTSIDE OF THE
SANITARY COMPARTMENT IN ACCORDANCE
WITH PART F4D8 OF THE BCA

DENOTES THE LOCATION OF SMOKE
ALARMS IN ACCORDANCE WITH PART
H3D6 OF THE NCC. SMOKE ALARMS
MUST COMPLY WITH AS 3786.


Dwg No. 09

Drawings 14

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NORTH ELEVATION SCALE 1:100



EAST ELEVATION

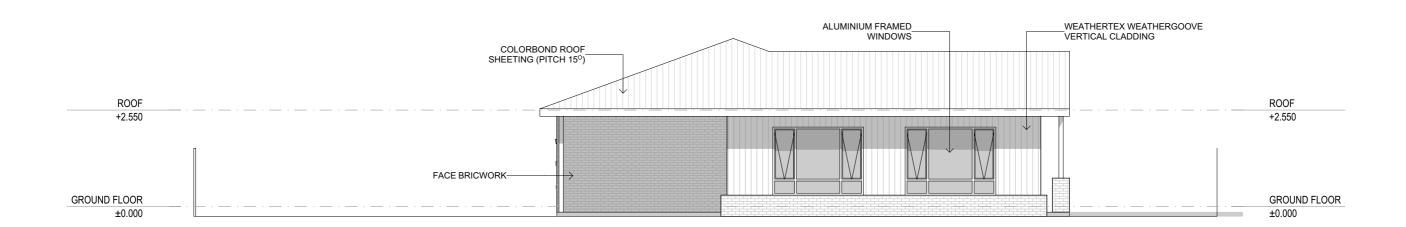SCALE 1:100









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						Project	AT LOT 1 PLOUGHMANS ESTATE	Job No.	23-044
							ORANGE NSW 2800	Dwg No. 10	Issue.
	No.	Description			Date	Title.	ELEVATIONS	Drawings 14	
ı	Amend	ments					LLLVATIONO	m set-	
	Scale:	AS NOTED @ A3.	Drawn: J.B.	Date: 31	/08/2023	Client.	CONTEMPORARY HOMES	© - Bassmann	Drafting Services

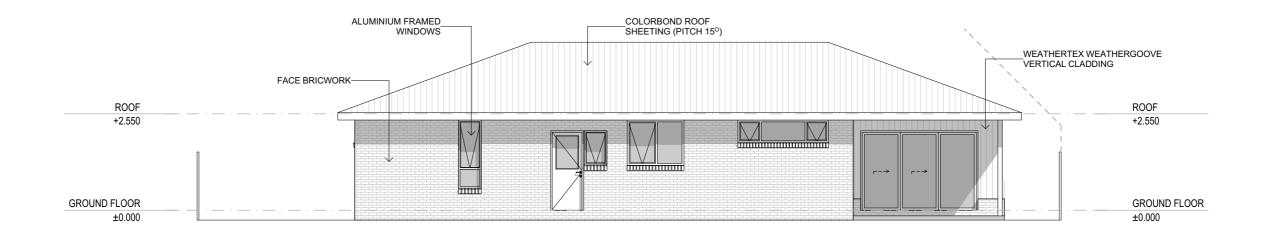

SOUTH ELEVATION

SCALE 1:100

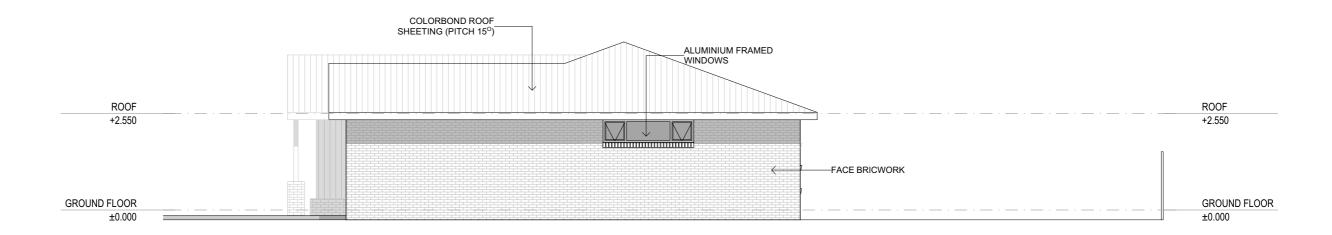

WEST ELEVATION SCALE 1:100







Ŧ						Project.	PROPOSED NEW RESIENCE AT LOT 1 PLOUGHMANS ESTATE	Job No.	23-044	
F							ORANGE NSW 2800	Dwg No. 11	Issue.	
2	No.	Description			Date	Title.	EL EL/ATIONO	Drawings 14		
1	Amendr	ments					ELEVATIONS	in set:		
5	cale:	S NOTED @ A3.	Drawn: J.B.	Date: 31	/08/2023	Client.	CONTEMPORARY HOMES	© - Bassmann	Drafting Services	

WINDOW NO.	W12 - 1809	W13 - 1809	W14 - 1809	W15 - 1809	W16 - 1809	W17 - 1824
W x H SIZE	900×1,800	900×1,800	900×1,800	900×1,800	900×1,800	2,400×1,800
FRAME	Aluminium	Aluminium	Aluminium	Aluminium	Aluminium	Aluminium
OPENING	Awning	Awning	Awning	Awning	Awning	Awning
GLAZING	Double / Clear					
EXTERNAL VIEW						

WINDOW NO.	W18 - 1824	W19 - 0624	W20 - 1215	W21 - 0906	W22 - 1806	W23 - 0624
W x H SIZE	2,400×1,800	2,400×600	1,500×1,200	600×900	600×1,800	2,400×600
FRAME	Aluminium	Aluminium	Aluminium	Aluminium	Aluminium	Aluminium
OPENING	Awning	Awning	Awning	Awning	Awning	Awning
GLAZING	Double / Clear					
EXTERNAL VIEW						



GENERAL

- ALL DIMENSIONS ARE IN MILLIMETRES UNLESS NOTED OTHERWISE
- DO NOT SCALE FROM DRAWING, IF IN DOUBT ASK.
- ALL DIMENSIONS AND LEVELS ARE TO BE CONFIRMED ON SITE PRIOR TO CONSTRUCTION. IT IS THE RESPONSIBILITY OF THE BUILDER TO VERIFY DOCUMENTS AS TO THEIR ACCURACY
- THESE PLANS ARE TO BE READ IN CONJUCTION WITH ENGINEERS DETAILS.
- THE CONSTRUCTION OF ANY STAIRS & BALUSTRADES SHALL COMPLY WITH PART 3.9.1 OF THE
- ALL STRUCTURAL ELEMENTS ARE TO BE DESGNED BY A PRACTISING STRUCTURAL ENGINEER.
- CONCRETE SLAB & FOOTINGS TO BE DESIGNED IN ACCORDANCE WITH AS2870.
- ALL TIMBER USED IN THE DEVELOPMENT IS TO BE STRICTLY IN ACCORDANCE WITH THE PROVISIONS OF AS1684. NATIONAL TIMBER FRAMING CODE. UNLESS A CERTIFICATE FROM A PRACTISING STRUCTURAL ENGINEER IS SUBMITTED TO COUNCIL CERTIFYING THAT THE BUILDING HAS BEEN DESIGNED TO WITHSTAND THE MOST ADHERE COMBINATION OF LOADS TO WHICH IT WILL BE SUBJECTED

STATUTORY REQUIREMENTS

- ALL WORK TO BE CARRIED OUT IN ACCORDANCE WITH THE NCC. CONDITIONS IMPOSED BY THE LOCAL AUTHORITY & THE COMMITMENTS OUTLINED IN THE RELEVANT BASIX CERTIFICATE.
- THE BUILDER IS TO COMPLY WITH THE REQUIREMENTS OF THE LEGALLY CONSTITUTED AUTHORITIES HAVING JUROSDICTION OVER THE BUILDING WORKS & THE PROVISIONS OF THE HOME
- PRIOR TO COMMENCEMENT OF BUILDING WORK, THE BUILDER SHOULD PROVIDE TEMPORARY TOILET FACILITIES FOR THE USE OF SUBCONTRACTORS. WHERE THE LOCAL AUTHORITY REQUIRES TEMPORARY TOILET TO BE CONNECTED TO SEWER MAINS, THE ADDITIONAL COST SHALL BE TO THE OWNERS EXPENSE, ON COMPLETION THE BUILDER SHALL REMOVE AS REQUIRED.

- NATIONAL CONSTRUCTION CODE (NCC) REQUIRMENTS:
 ALL EARTHWORKS SHALL BE IN ACCORDANCE WITH PART H1D3 OR AS DESIGNED BY A PRACTICING STRUCTURAL ENGINEER.
 - FOOTINGS AND SLABS SHALL BE IN ACCORDANCE WITH PART H1D4 OR AS DESIGNED BY A
 - PRACTICING STRUCTURAL ENGINEER.
 AN APPROPRIATE TERMITE MANAGEMENT SYSTEM SHALL BE PROVIDED IN ACCORDANCE WITH PART H1D3 AND MUST COMPLY WITH AS 3660.1.
 - ALL MASONRY WORK SHALL BE IN ACCORDANCE WITH PART H1D5 AND COMPLY WITH AS 3700 OR AS 4773.1 AND AS 4773.2.
 - ALL STEEL FRAMING SHALL BE DESIGNED AND CONSTRUCTED IN ACCORDANCE WITH EITHER NASH STANDARD RESIDENTIAL AND LOW-RISE STEEL FRAMING PART 1 AND PART 2, AS 4100 OR AS/NZS 4600.
 - ALL TIMBER FRAMING SHALL BE DESIGNED AND CONSTRUCTED IN ACCORDANCE WITH AS 1720.1, AS 1720.5, AS 1684 AND/OR AS 1860.2 AS APPROPRIATE.
 - ROOF TRUSSES SHALL BE DESIGNED IN ACCORDANCE WITH AS 1720 AND ERECTED, FIXED AND BRACED IN ACCORDANCE WITH MANUFACTURERS INSTRUCTIONS.
 - ALL STRUCTURAL STEEL MEMBERS SHALL BE DESIGNED BY A PRACTICING STRUCTURAL ENGINEER AND CONSTRUCTED IN ACCORDANCE WITH AS 4100.
 - ALL ROOF AND WALL CLADDING SHALL BE IN ACCORDANCE WITH PART H1D7.
 - ALL WINDOWS, GLAZED ASSEMBLIES AND GLAZED DOORS SHALL BE DESIGNED, CONSTRUCTED AND INSTALLED IN ACCORDANCE WITH AS 2047 AND AS 1288. - CLASS 1 BUILDING CONSTRUCTION IN A FLOOD HAZARD AREA SHALL BE \CONSTRUCTED IN
 - ACCORDANCE WITH THE ABCB STANDARD FOR CONSTRUCTION OF BUILDINGS IN FLOOD HAZARD AREAS
 - ALL DECKS/BALCONIES ATTACHED TO EXTERNAL WALLS USING A WHALING PLATE SHALL BE IN ACCORDANCE WITH PART H1D11.
 - ALL PILED FOOTINGS SHALL BE DESIGNED AND INSTALLED IN ACCORDANCE WITH AS 2159. A STORMWATER DRAINAGE SYSTEM SHALL BE DESIGNED AND CONSTRUCTED IN ACCORDANCE WITH AS / NZS 3600.3

- MAINS POWERED INTERCONNECTED SMOKE DETECTORS SHALL BE INSTALLED IN ACCORDANCE WITH PART H3D6 AND COMPLY WITH AS 3786.
- WATERPROOFING OF WET AREAS SHALL BE IN ACCORDANCE WITH PART H4D2 AND COMPLY WITH AS 3740.

PREFABRICATED TIMBER ROOF TRUSSES

PLASTERBOARD CORNICE

PLASTERBOARD LINING.

R2.5 (MIN.) WALL INSULATION

TIMBER WALL FRAMING

CONCRETE SLAB TO ENGINEERS DESIGN

SELECTED SKIRTING BOARD

R4.0 (MIN.)

CEILING INSULATION

WAFFLE POD

ROOF PITCH

22.5°

EAVE WIDTH

450

SELECTED ROOF SHEETING

GUTTER

FASCIA

F.C. SOFFIT LINING

SARKING

TIMBER BEAD

WEATHERTEX SELF-LOK WEATHERBOARDS

SARKING MATERIAL

PROVIDE WEEP HOLES AT 900mm CENTRES.

WATERPROOF MEMBRANE

'Z' FLASHING FACE BRICKWORK

FLASHING

D.P.C.

TYPICAL DETAIL 450mm EAVE - SCALE - 1:20

- IF REQUIRED, ARTIFICIAL LIGHTING SHALL BE IN ACCORDANCE WITH PART H4D6 OR AS/NZS
- MECHANICAL VENTILATION SYSTEMS SHALL BE INSTALLED IN ACCORDANCE WITH AS 1668.2.
- IF REQUIRED, MECHANICAL VENTILATION SHALL BE PROVIDED TO SANITARY COMPARTMENTS, LAUNDRIES, KITCHENS AND BATHROOMS AND SHALL BE IN ACCORDANCE WITH PART H4D7(2).
- PLIABLE BUILDING MEMBRANES INSTALLED TO EXTERNAL WALLS MUST COMPLY WITH AS 4200.1, BE INSTALLED IN ACCORDANCE WITH AS 4200.2, BE LOCATED ON THE EXTERIOR SIDE OF THE PRIMARY INSULATION LAYER AND HAVE A PERMEABILITY OF NOT LESS THAN 1.14 µg/N.s.
- CONDENSATION MANAGEMENT SHALL BE IN ACCORDANCE WITH PART H4D9
- STAIRWAYSAND RAMPS SHALL BE IN ACCORDANCE WITH PART H5D2. BARRIERS AND HANDRAILS SHALL BE IN ACCORDANCE WITH PART H5D3.
- HEATING APPLIANCES AND FIREPLACES SHALL BE INSTALLED IN ACCORDANCE WITH PART
- ALL PLUMBING WORK SHALL BE IN ACCORDANCE WITH THE PLUMBING CODE OF AUSTRALIA AND COMPLY WITH THE REQUIREMENTS OF THE RELEVANT SUPPLY AUTHORITY AND AS 3500 AND BE CARRIED OUT BY A LICENSED PLUMBER.
- ALL ELECTRICAL WORK SHALL COMPLY WITH THE REQUIREMENTS OF THE RELEVANT SUPPLY AUTHORITY AND AS 3000 AND BE CARRIED OUT BY A LICENSED ELECTRICIAN.
- ALL GAS INSTALLATIONS SHALL COMPLY WITH THE REQUIREMENTS OF THE RELEVANT SUPPLY AUTHORITY AND BE CARRIED OUT BY A LICENSED GAS FITTER.
- INSTALLATION OF WALL AND FLOOR TILES SHALL COMPLY WITH AS 3958.1
- DRIVEWAY ACCESS SHALL COMPLY WITH AS / NZS 2890.1












					Project.	PROPOSED NEW RESIENCE AT LOT 1 PLOUGHMANS ESTATE	Job No.	23-044
						ORANGE NSW 2800	Dwg No. 12	Issue.
No. Amenda	Description			Date	Title.	WINDOW SCHEDULE	Drawings 14	
Scale:	S NOTED @ A3.	rawn: J.B.	Date: 31	/08/2023	Client.	CONTEMPORARY HOMES	© - Bassmann	Orafting Services

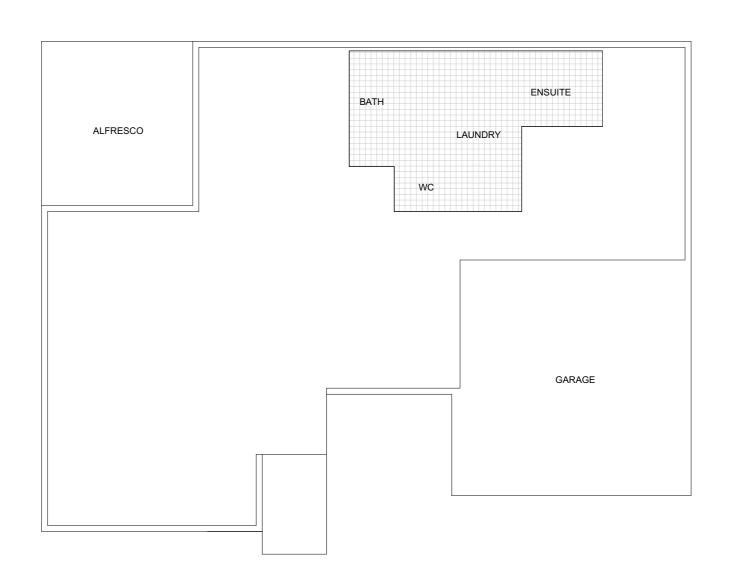

CONCRETE PLAN SCALE 1:100







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F				Project.	PROPOSED NEW RESIENCE AT LOT 1 PLOUGHMANS ESTATE	Job No.	23-044
					ORANGE NSW 2800	Dwg No. 13	Issue.
2	No.	Description	Date	Title.		Drawings 14	
I	Amendr	ments			CONCRETE PLAN	in set: 14	
8	Scale:	AS NOTED @ A3. Drawn: J.B.	31/08/2023	Client.	CONTEMPORARY HOMES	© - Bassmann D	rafting Services



LOT B FACADE





			Project.	PROPOSED NEW RESIENCE AT LOT 1 PLOUGHMANS ESTATE	Job No.	23-044
				ORANGE NSW 2800	Dwg No. 14	Issue.
No.	Description	Date	Title.	VIEWS	Drawings 14	
Amend	ments			VILVO	m sec	
Scale:	AS NOTED @ A3. Drawn: J.B.	08/2023	Client.	CONTEMPORARY HOMES	© - Bassmann Dr	rafting Services