

DA No. DA0246/2020

Approval has been granted subject to conditions in the Development Consent accompanying this plan.


These plans may be modified by conditions of consent. Please refer to consent documents for details.

Shellharbour  
CITY COUNCIL


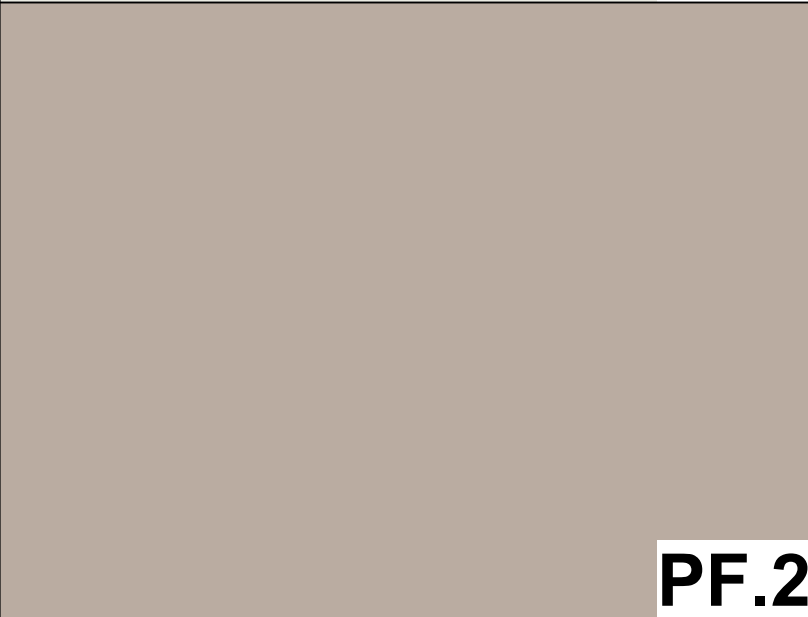

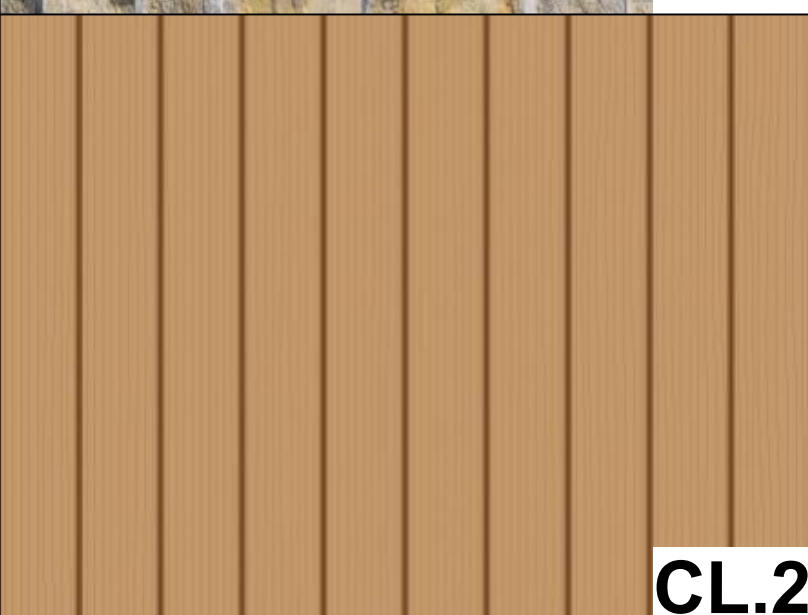
# PROPOSED DUAL OCCUPANCY DEVELOPMENT


4 WOLLONGONG STREET, SHELLHARBOUR - LOT 1 | D.P 21994

PREPARED FOR SHELLHARBOUR CITY COUNCIL



Subject Site  
4 Wollongong Street, Shellharbour  
Lot 1 | D.P 21994

	MATERIALS AND FINISHES	
DULUX WHISPER WHITE	 PF.1	
DULUX BLIND DATE OR SIMILAR	 PF.2	
SANDSTONE CLADDING OR SIMILAR	 CL.1	
TIMBER CLADDING OR SIMILAR	 CL.2	



PF.1 CL.1 CL.2 PF.2

No. 4 sea view

Sheet Index	
Layout ID	Layout Name
01	Cover Page/Material Schedule
02	BASIX Commitments
03	BASIX Obligations
04	Site Plan
05	Site Analysis
06	Erosion & Sediment Control / Demolition Plan
07	Car Parking Plan
08	Ground Floor Plan
09	First Floor Plan
10	Roof Plan
11	Elevations
12	Sections
13	Shadow Diagrams
14	Area Calculation Plan
15	Proposed Plan of Subdivision

## DEVELOPMENT APPLICATION

ISSUE	DESCRIPTION	DATE	NOTES
A	ISSUE FOR DEVELOPMENT APPLICATION LODGEMENT	05/06/20	
B	ISSUE FOR DEVELOPMENT APPLICATION LODGEMENT	16/10/20	
C	REVISED FOR APPROVAL	29/01/21	
D	REVISED FOR APPROVAL	29/01/21	

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DRAWING TITLE

Cover Page/Material Schedule

DRAWING NO.

DA01

SCALE

1:100 @ A1 or 1:200 @ A3



NORTH



Proposed Dual Occupancy  
4 Wollongong Street, Shellharbour

JOB No. 01820_DA	DATE 29/01/2021	DRAWN J.D	CHECKED A.M	SCALE As Shown on A1
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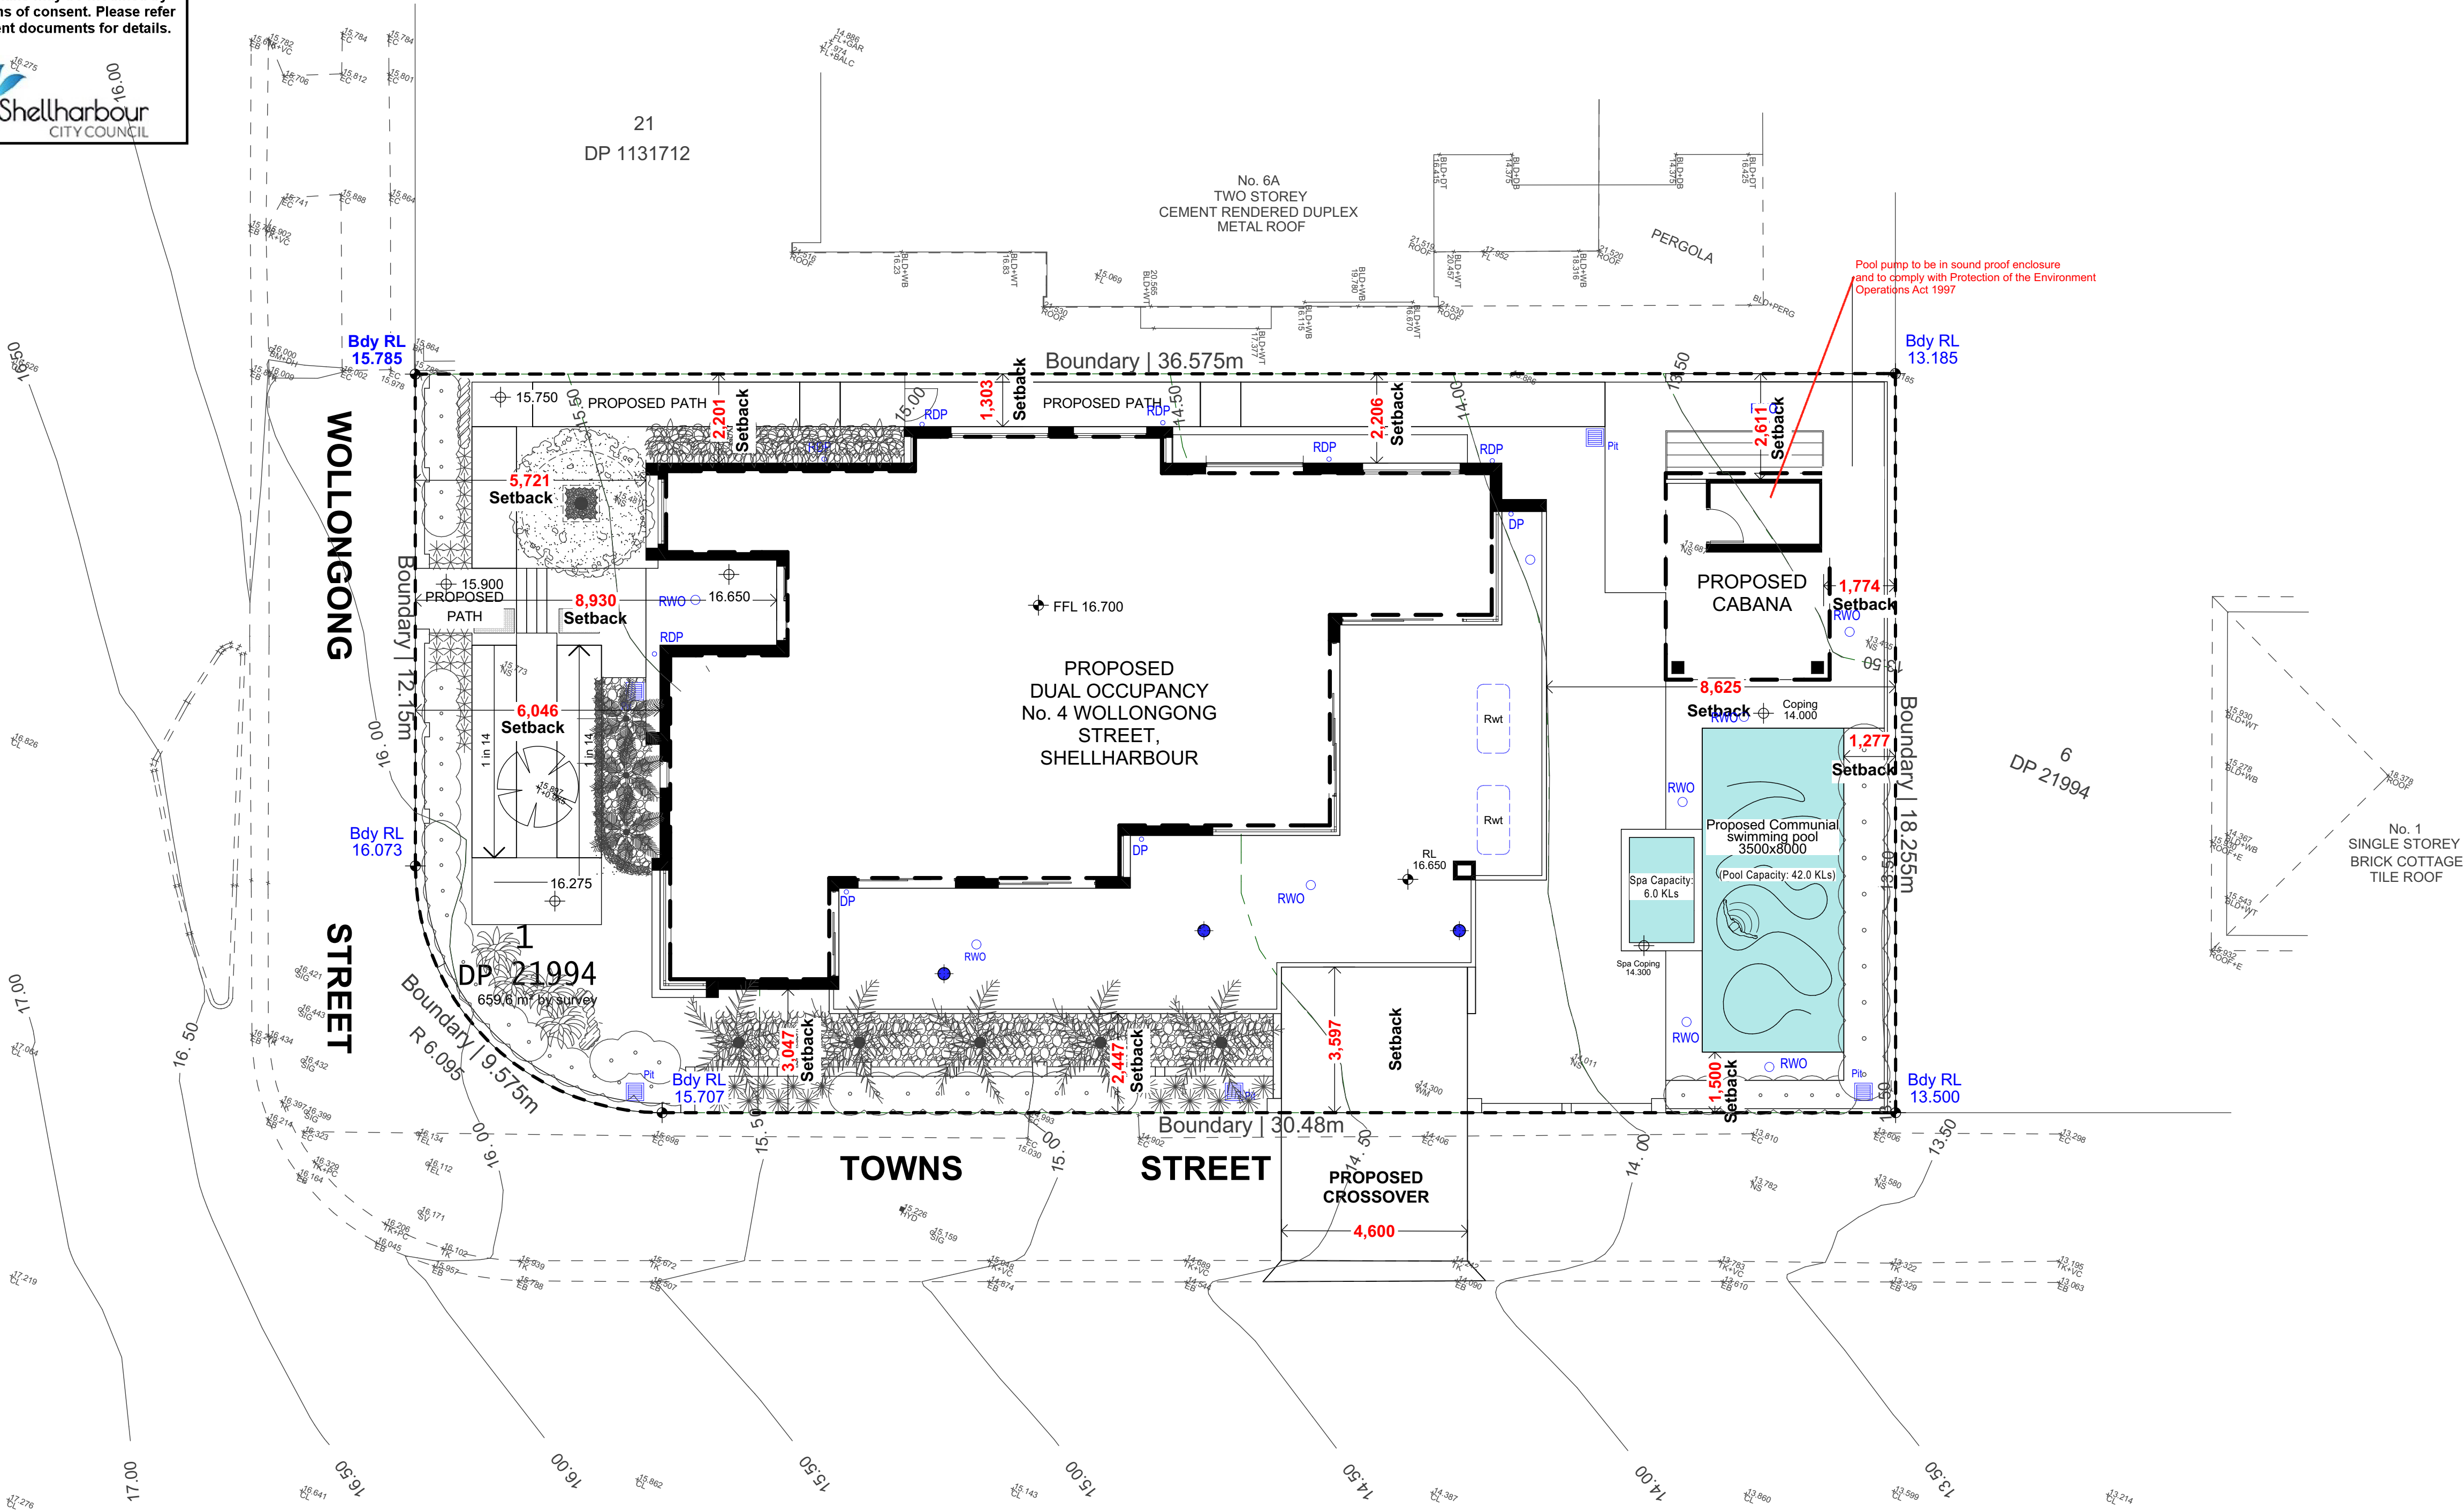


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Shellharbour  
CITY COUNCIL



DEVELOPMENT SUMMARY

PROJECT: PROPOSED DUAL OCCUPANCY  
SITE: 4 WOLLONGONG STREET, SHELLHARBOUR  
LOT 1 | D.P 21994

SITE AREA: 659.6 m<sup>2</sup> (By Calc.)

NUMERICAL CONTROL:	PROPOSED
Ground GFA	164.58 m <sup>2</sup>
First GFA	164.58 m <sup>2</sup>
Total GFA	329.16 m <sup>2</sup>
FSR 0.5:1	0.50:1
LANDSCAPE AREA	162.64m <sup>2</sup>
PRIVATE OPEN SPACE	LOT 1 , 82.67 m <sup>2</sup> LOT 2 , 67.14 m <sup>2</sup>

1 Site Plan  
1:100

DEVELOPMENT APPLICATION

ISSUE	DESCRIPTION	DATE	NOTES	DRAWING TITLE	SCALE	NORTH	PROPOSED Dual Occupancy 4 Wollongong Street, Shellharbour
A	ISSUE FOR DEVELOPMENT APPLICATION LODGEMENT	05/06/20		Site Plan	1:100 @ A1 or 1:200 @ A3		
B	ISSUE FOR DEVELOPMENT APPLICATION LODGEMENT	16/10/20		DRAWING NO			
C	REVISED FOR APPROVAL	29/01/21		DA04			
D	REVISED FOR APPROVAL	29/01/21					








Figure 1: View of Towns Street Facing East



Figure 2: View of Towns Street Facing East



Figure 3: View of Shellharbour Boat Ramp

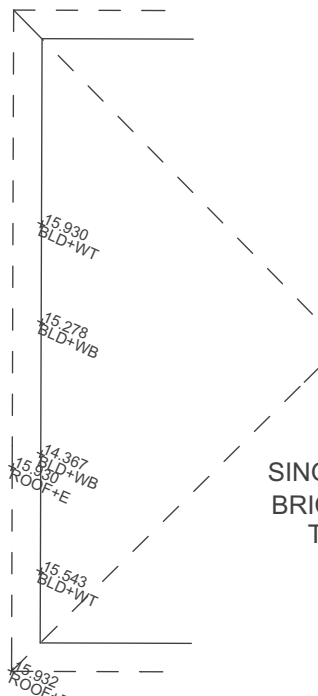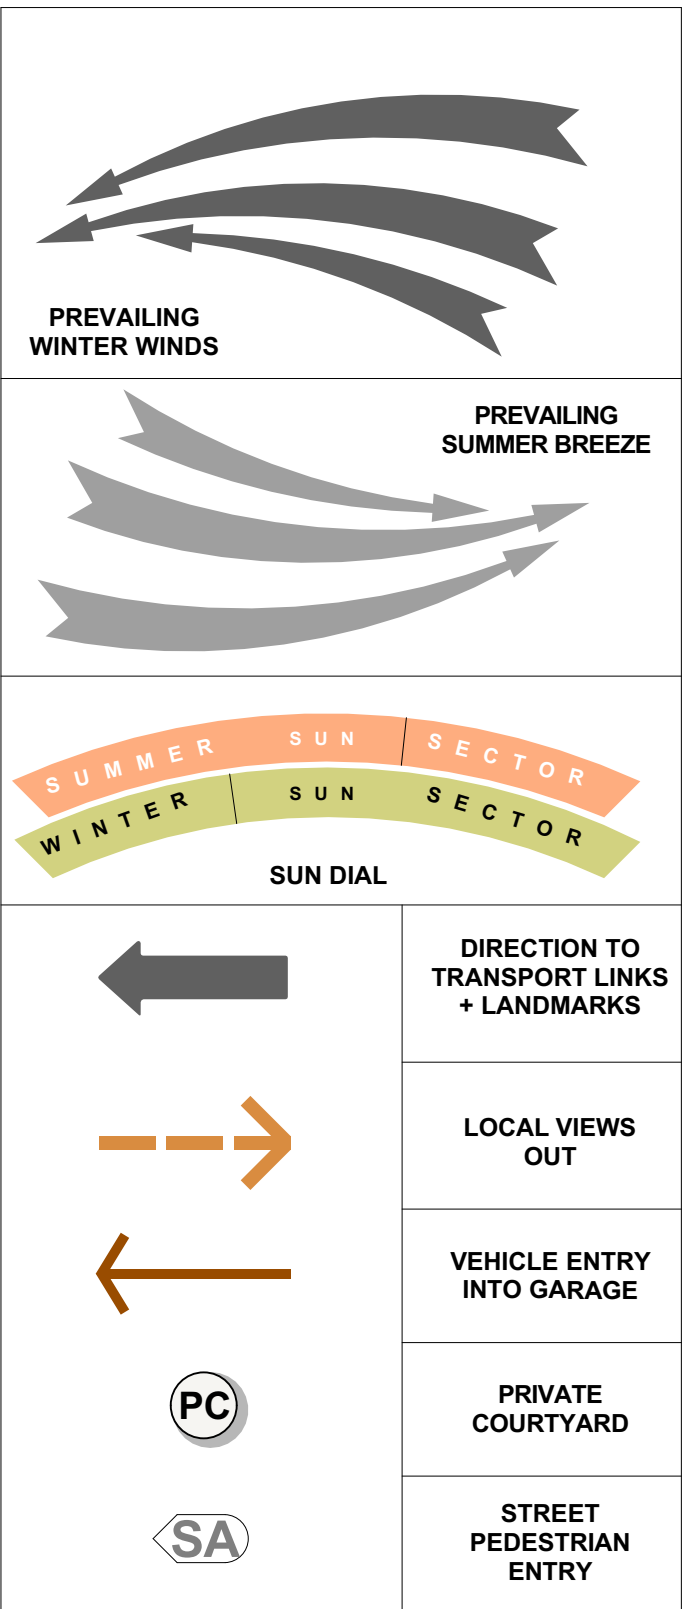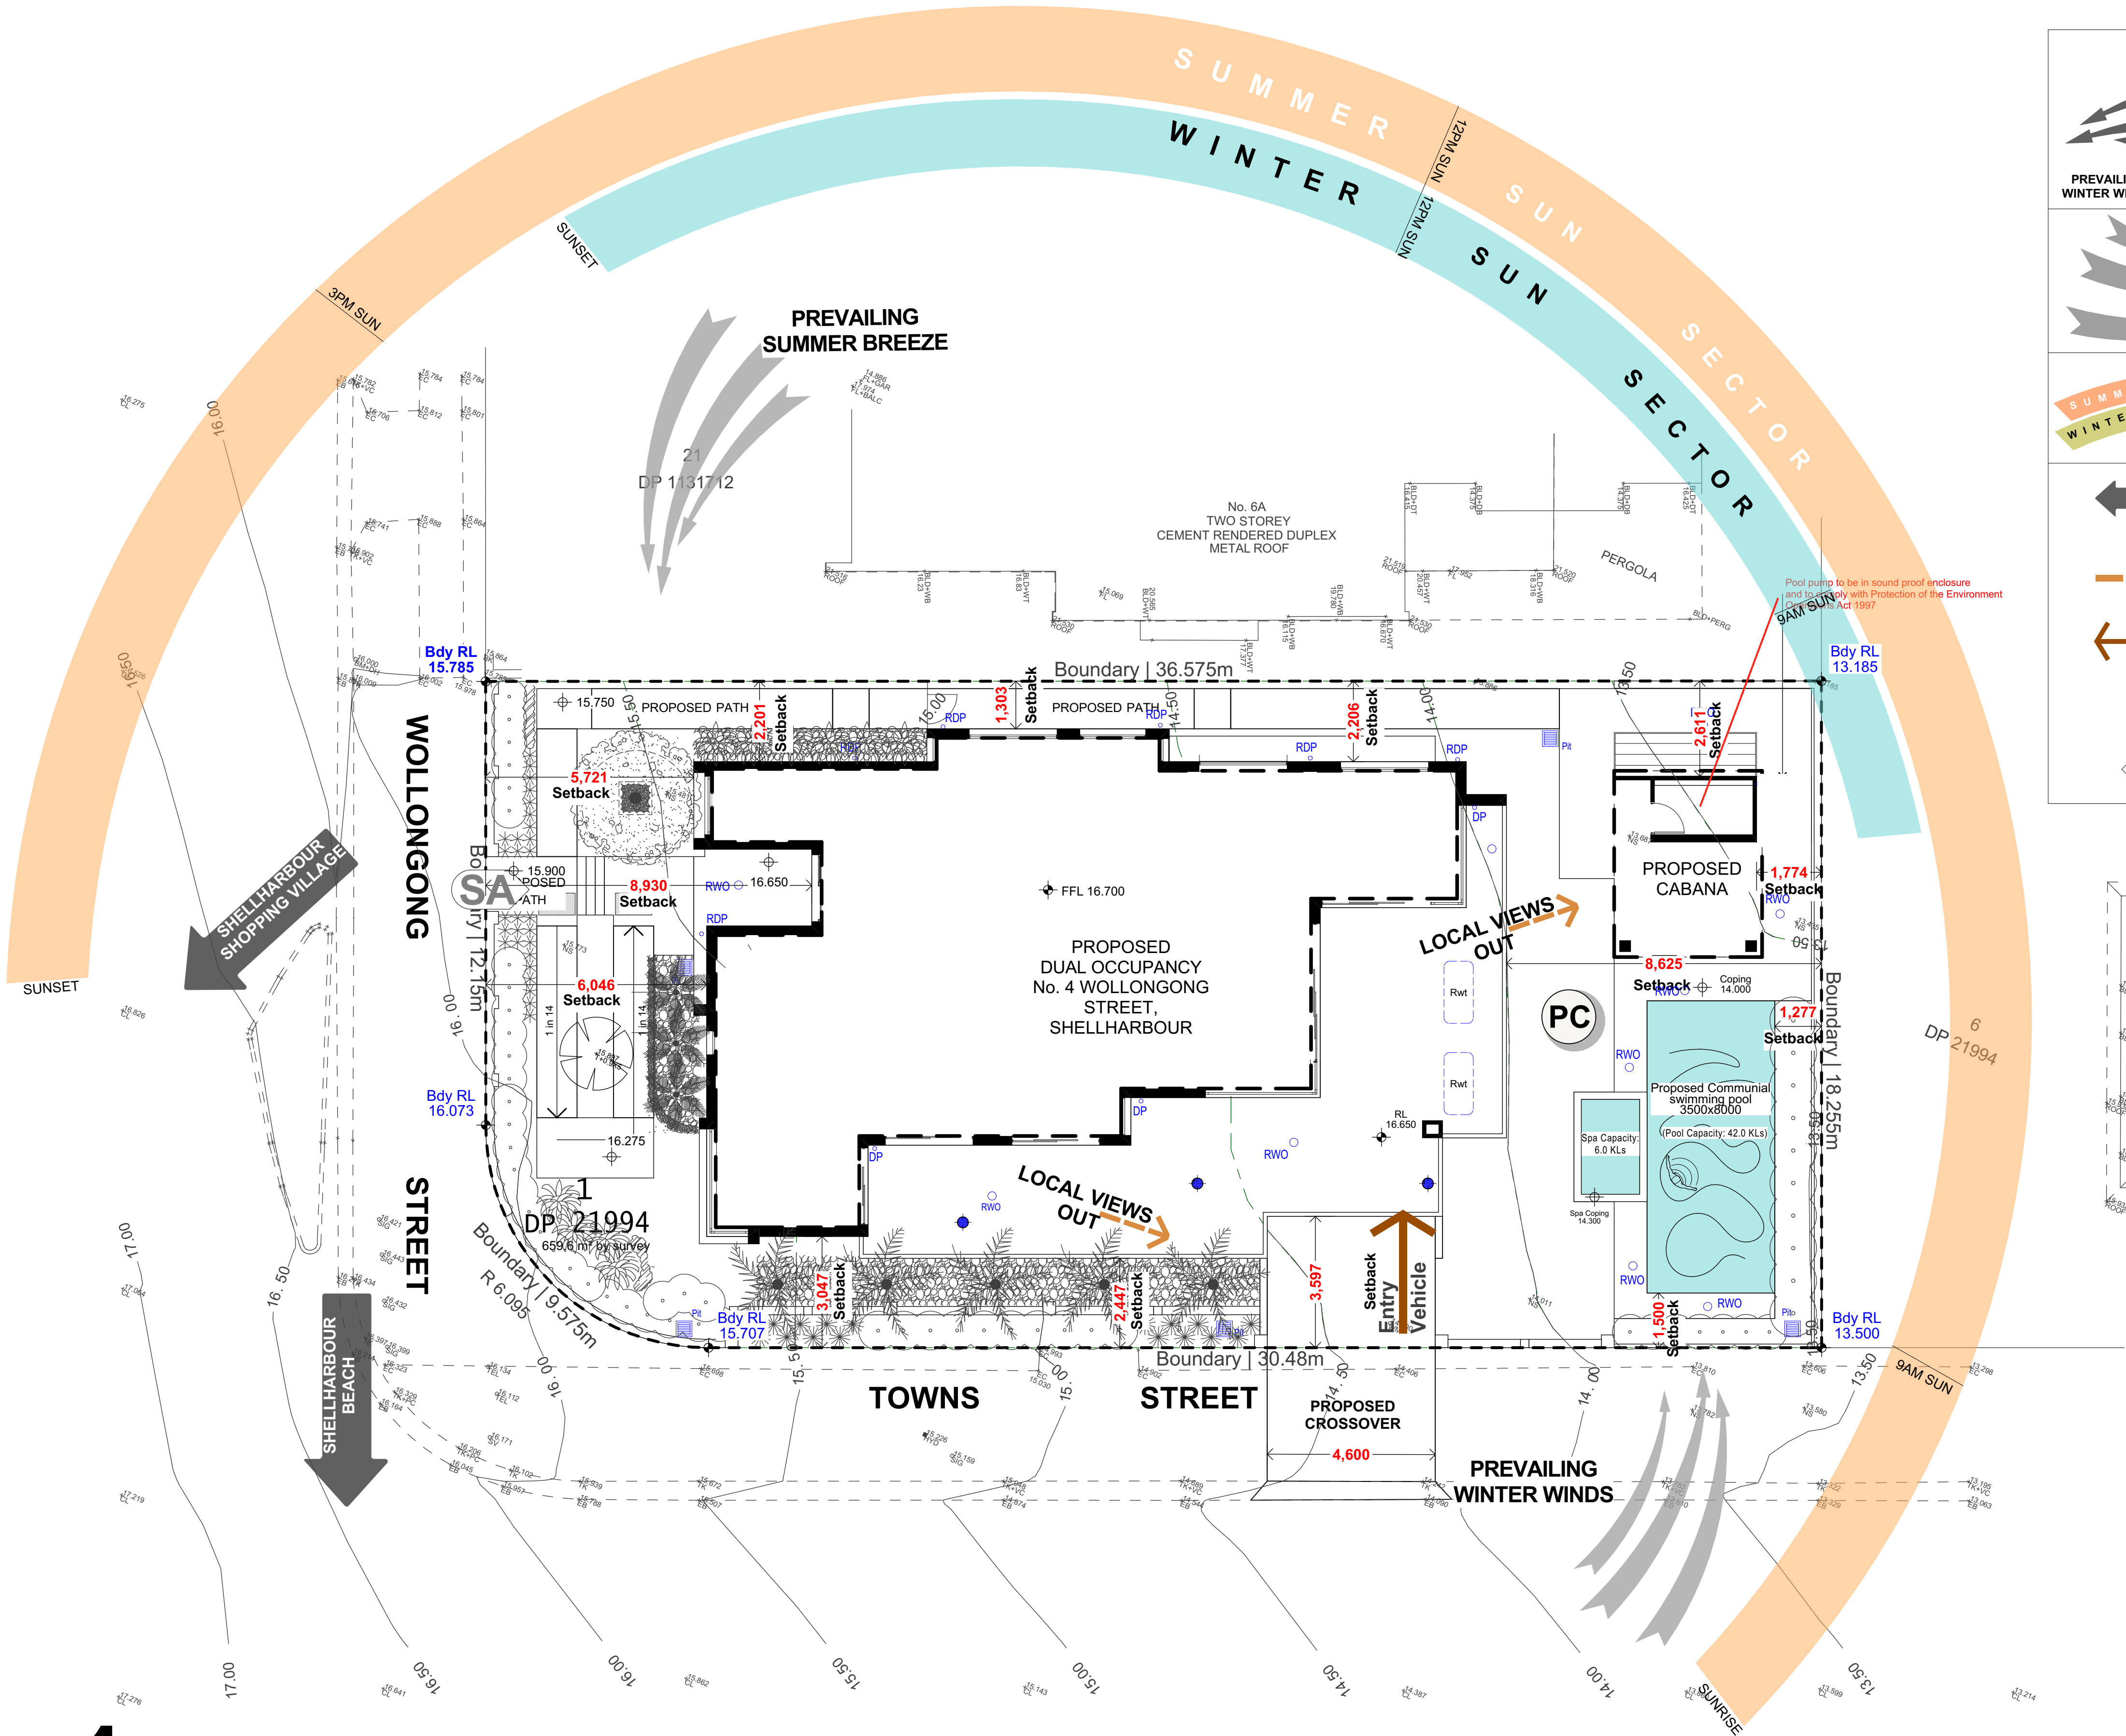

# 1 Site Anaylsis

1:100

## DEVELOPMENT APPLICATION

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D	REVISED FOR APPROVAL	29/01/21	

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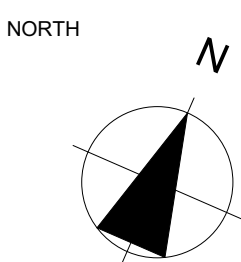
Verify all dimensions on site

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DRAWING TITLE  
**Site Anaylsis**  
DRAWING NO  
**DA05**


SCALE  
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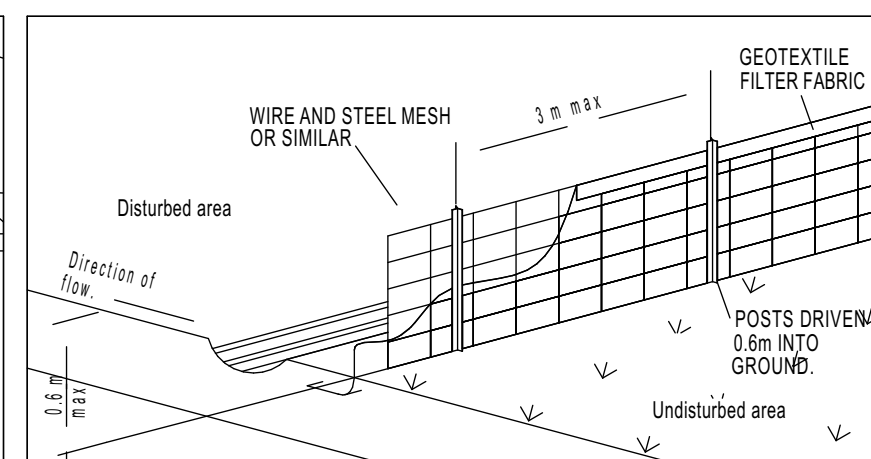
**Proposed Dual Occupancy**  
**4 Wollongong Street, Shellharbour**

JOB No. 01820\_DA DATE 29/01/2021 DRAWN J.D. CHECKED A.M. SCALE As Shown on A1







## SANDBAG KERB INLET SEDIMENT TRAP

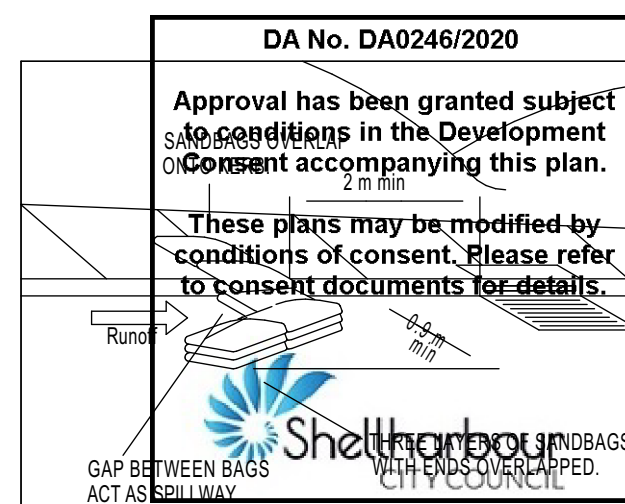


## SEDIMENT FENCE

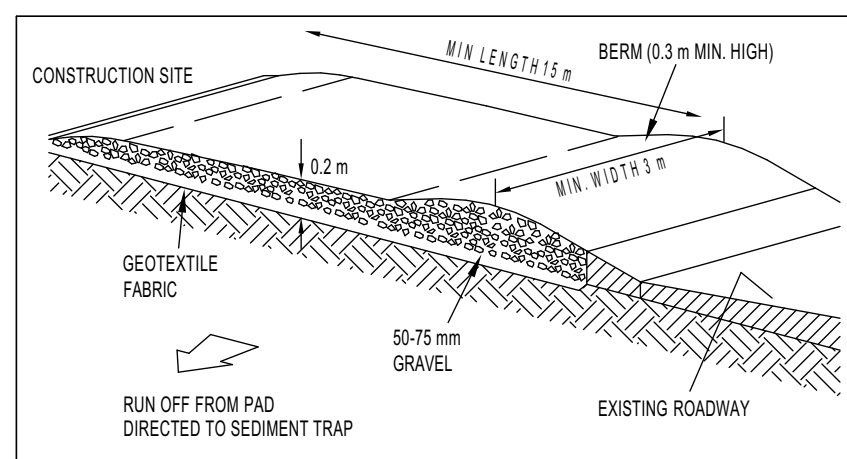


**TEMPORARY  
CONSTRUCTION EXIT**

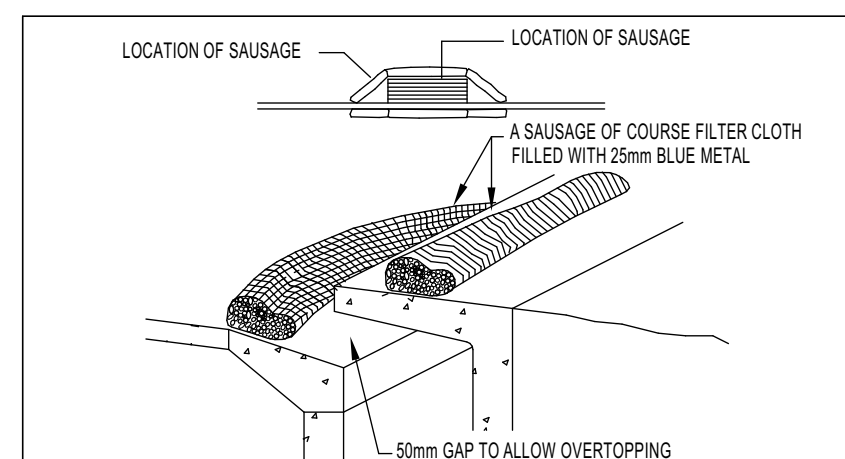


## KERB INLET CONTROL

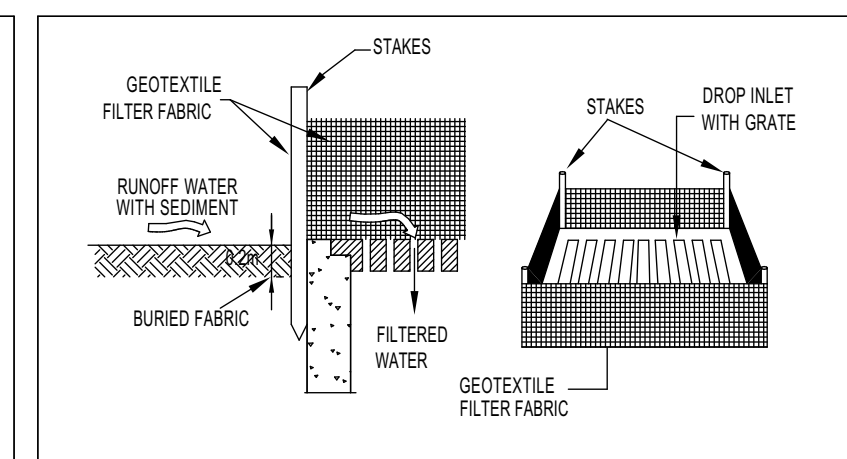


## GEOTEXTILE FILTER FABRIC DROP INLET SEDIMENT TRAP

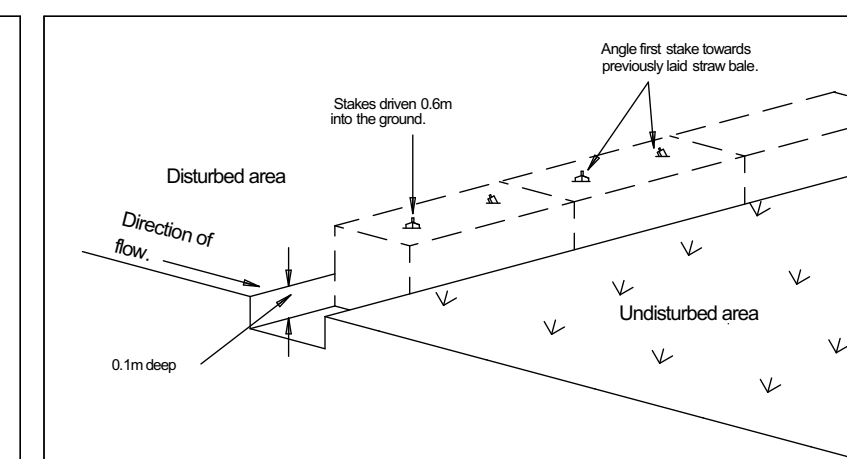

## STRAW BALE SEDIMENT FILTER

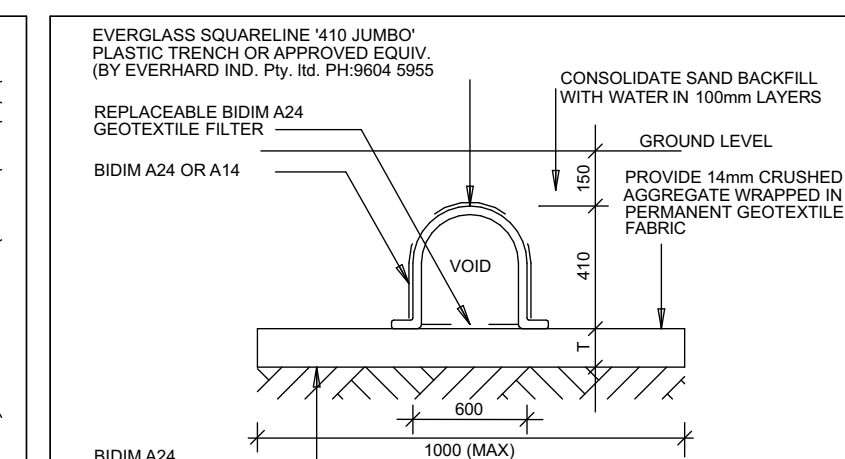

## ABSORPTION TRENCH DETAIL

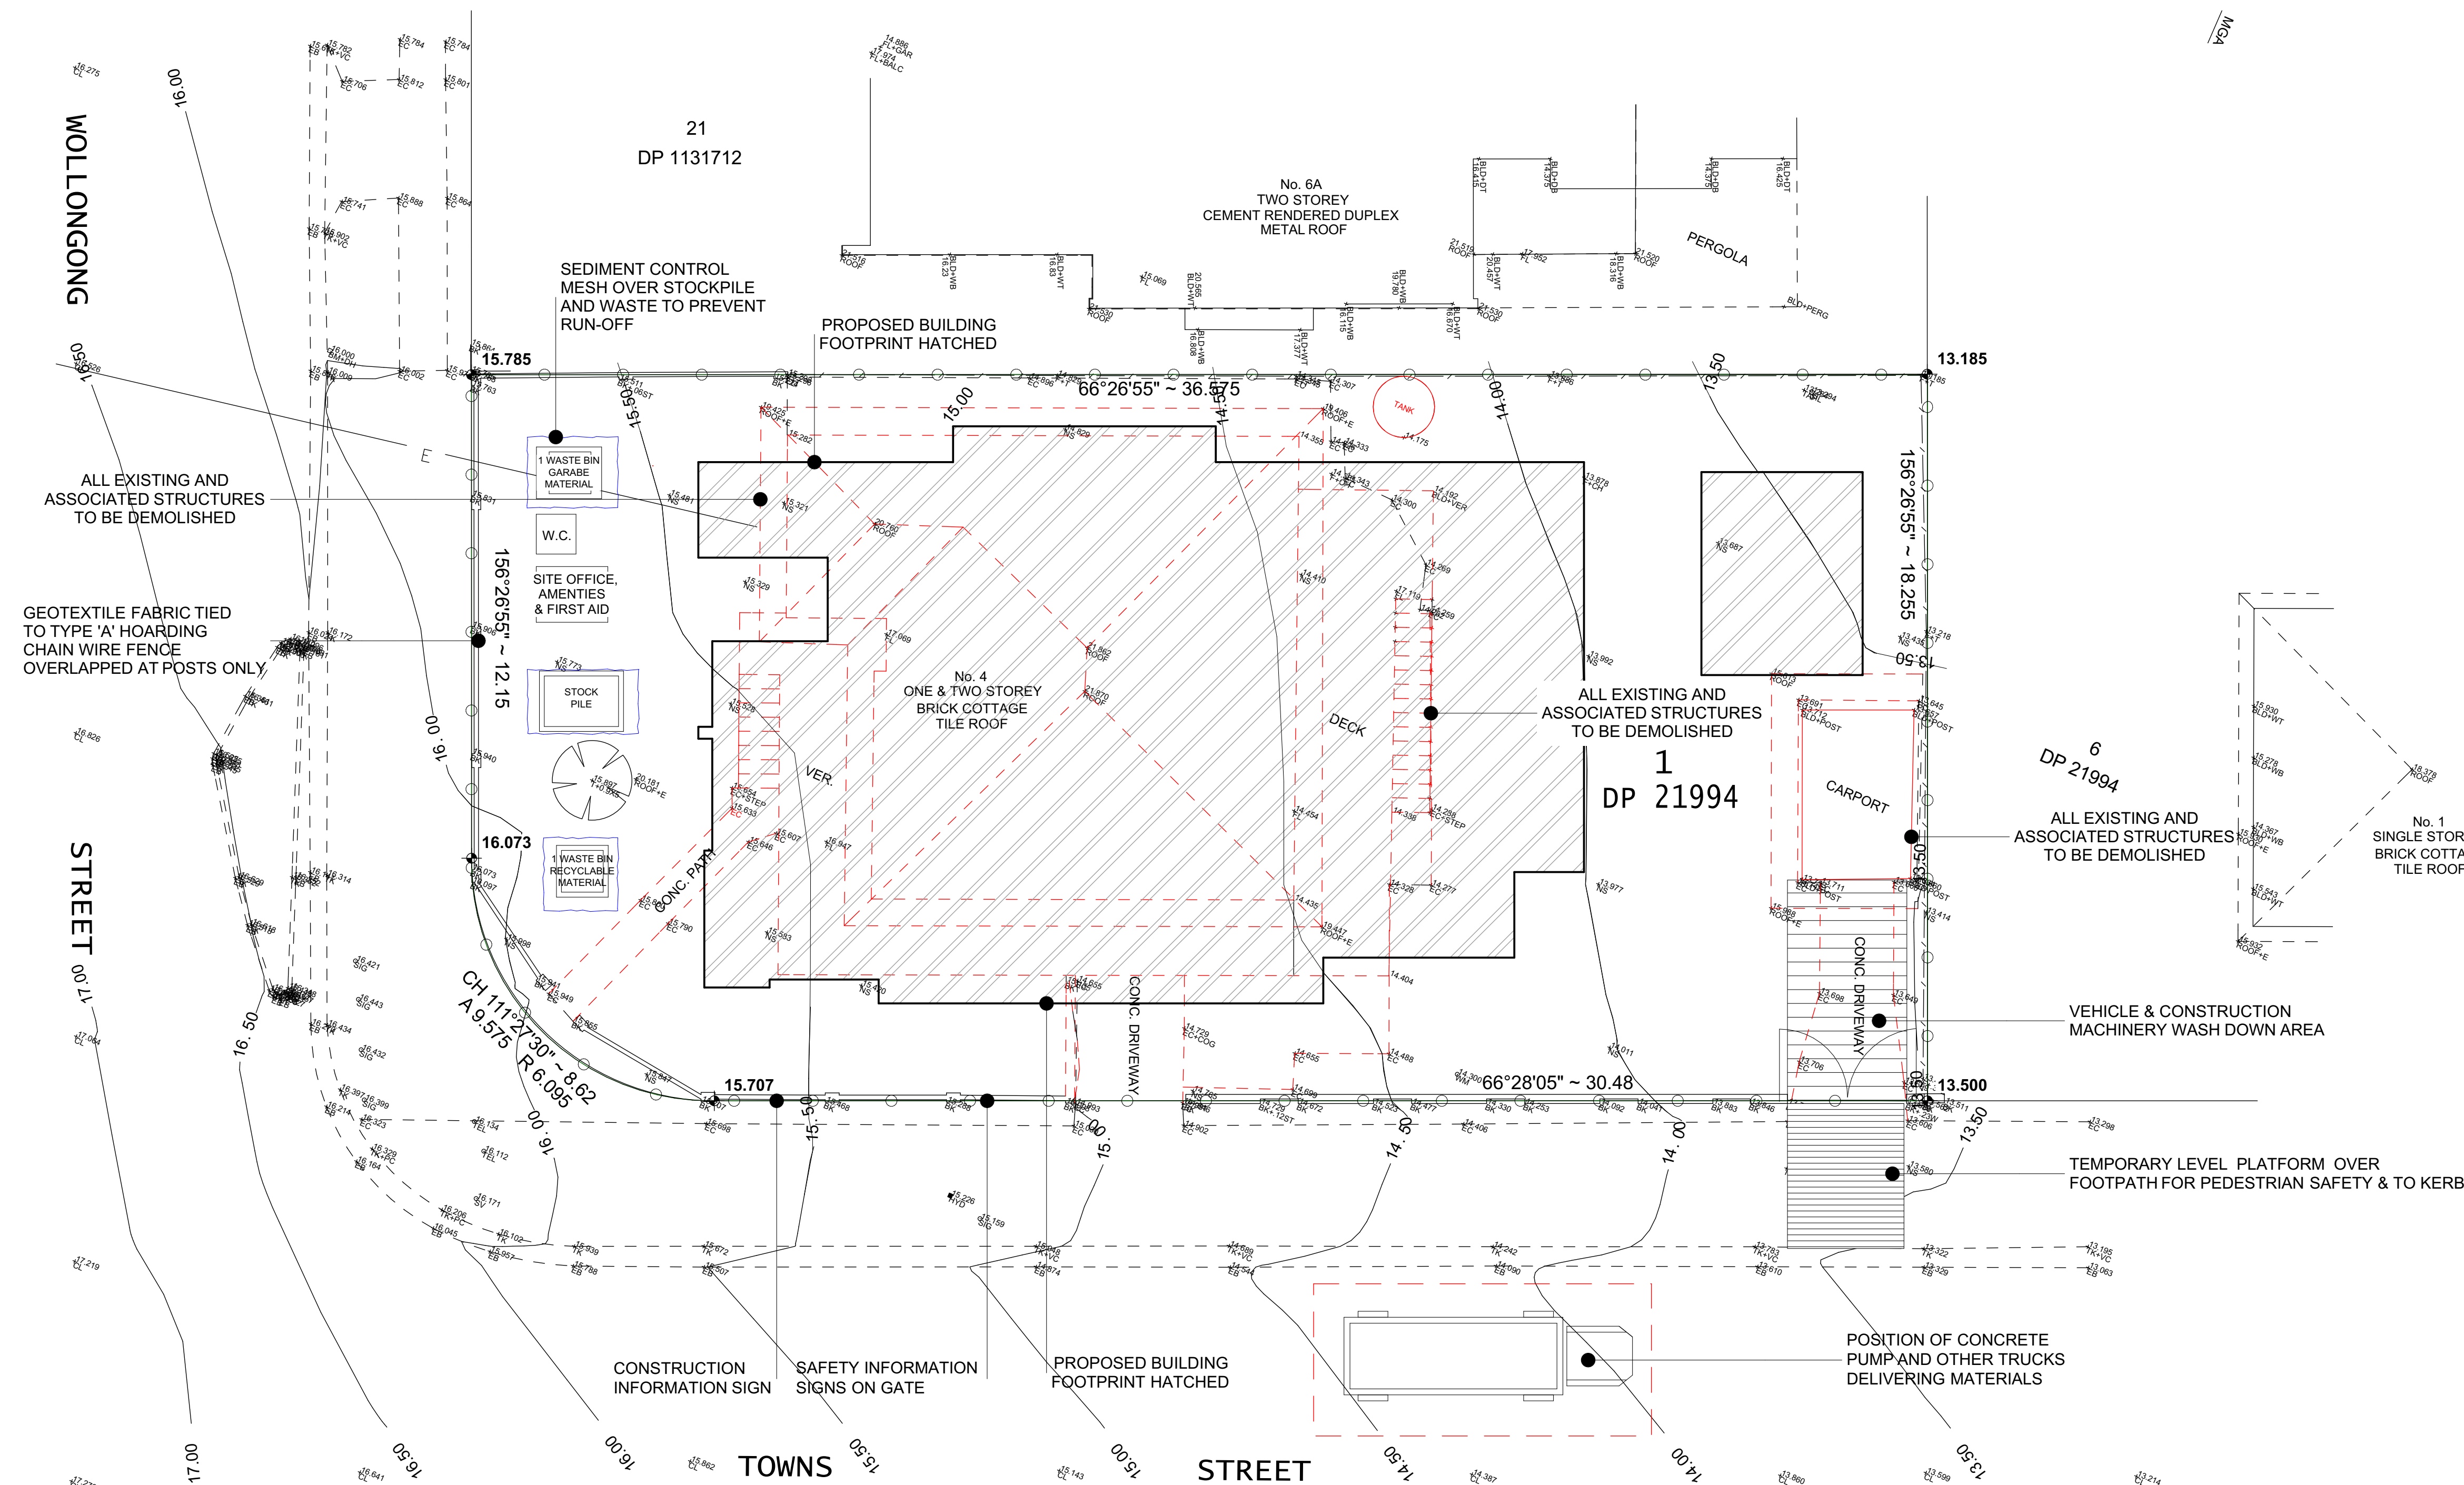


## SEDIMENT CONTROL NOTES

1. All erosion and sedimentation control measures , including revegetation and storage of soil and topsoil , shall be implemented to the standards of the soil conservation of NSW .
2. All drainage works shall be constructed and stabilized as early as possible during development .
3. Sediment traps shall be constructed around all inlet pits , consisting of 300mm wide x 300mm deep trench.
4. All sediment basins and traps shall be cleaned when the structures are a maximum of 60% full of soil materials , including the maintenance period .
5. All disturbed areas shall be revegetated as soon as the relevant works are completed .
6. Soil and topsoil stockpiles shall be located away from drainage lines and area where water may concentrate
7. Filter shall be constructed by stretching a filter fabric ( propex ) or approved equivalent between post at 3.0m centres. fabric shall be buried 150mm along its lower edge

ISSUE	DESCRIPTION	DATE	NOTES	<p><b>DESIGN LINK AUSTRALIA PTY LTD</b>  a Sulte 1, Level 5, 410 Church St, Paramatta, NSW 2150  p PO BOX 3085 North Strathfield NSW 2137  p 02 9744 3116 e info@design-link.com.au</p> <p><b>DESIGN LINK AUSTRALIA PTY LTD</b></p>	<p><b>DA06</b></p>	<p><b>Erosion &amp; Sediment Control / Demolition Plan</b></p>	<p>DRAWING TITLE</p> <p>DRAWING NO</p>	<p>SCALE</p> <p>1:100 @ A1 or 1:200 @ A3</p>	<p>NORTH</p>	<p><b>Proposed Dual Occupancy</b>  4 Wollongong Street, Shellharbour</p>	<p>JOB No. 01820 DA</p> <p>DATE 29/01/2021</p> <p>DRAWN J.D</p> <p>CHECKED A.M</p> <p>SCALE As Shown on A1</p>
A	ISSUE FOR DEVELOPMENT APPLICATION LODGEMENT	05/06/20	<p>The plans, drawings and specifications incorporated in this document shall remain the copyright © of DESIGN LINK AUSTRALIA PTY LTD and must not be used, reproduced or copied wholly or in part without prior written consent of DESIGN LINK AUSTRALIA PTY LTD.</p> <p><b>Figured dimensions shall take preference over scaling.</b>  <i>Verify all dimensions on site</i></p>								
B	ISSUE FOR DEVELOPMENT APPLICATION LODGEMENT	16/10/20									
C	REVISED FOR APPROVAL	29/01/21									
D	REVISED FOR APPROVAL	29/01/21									



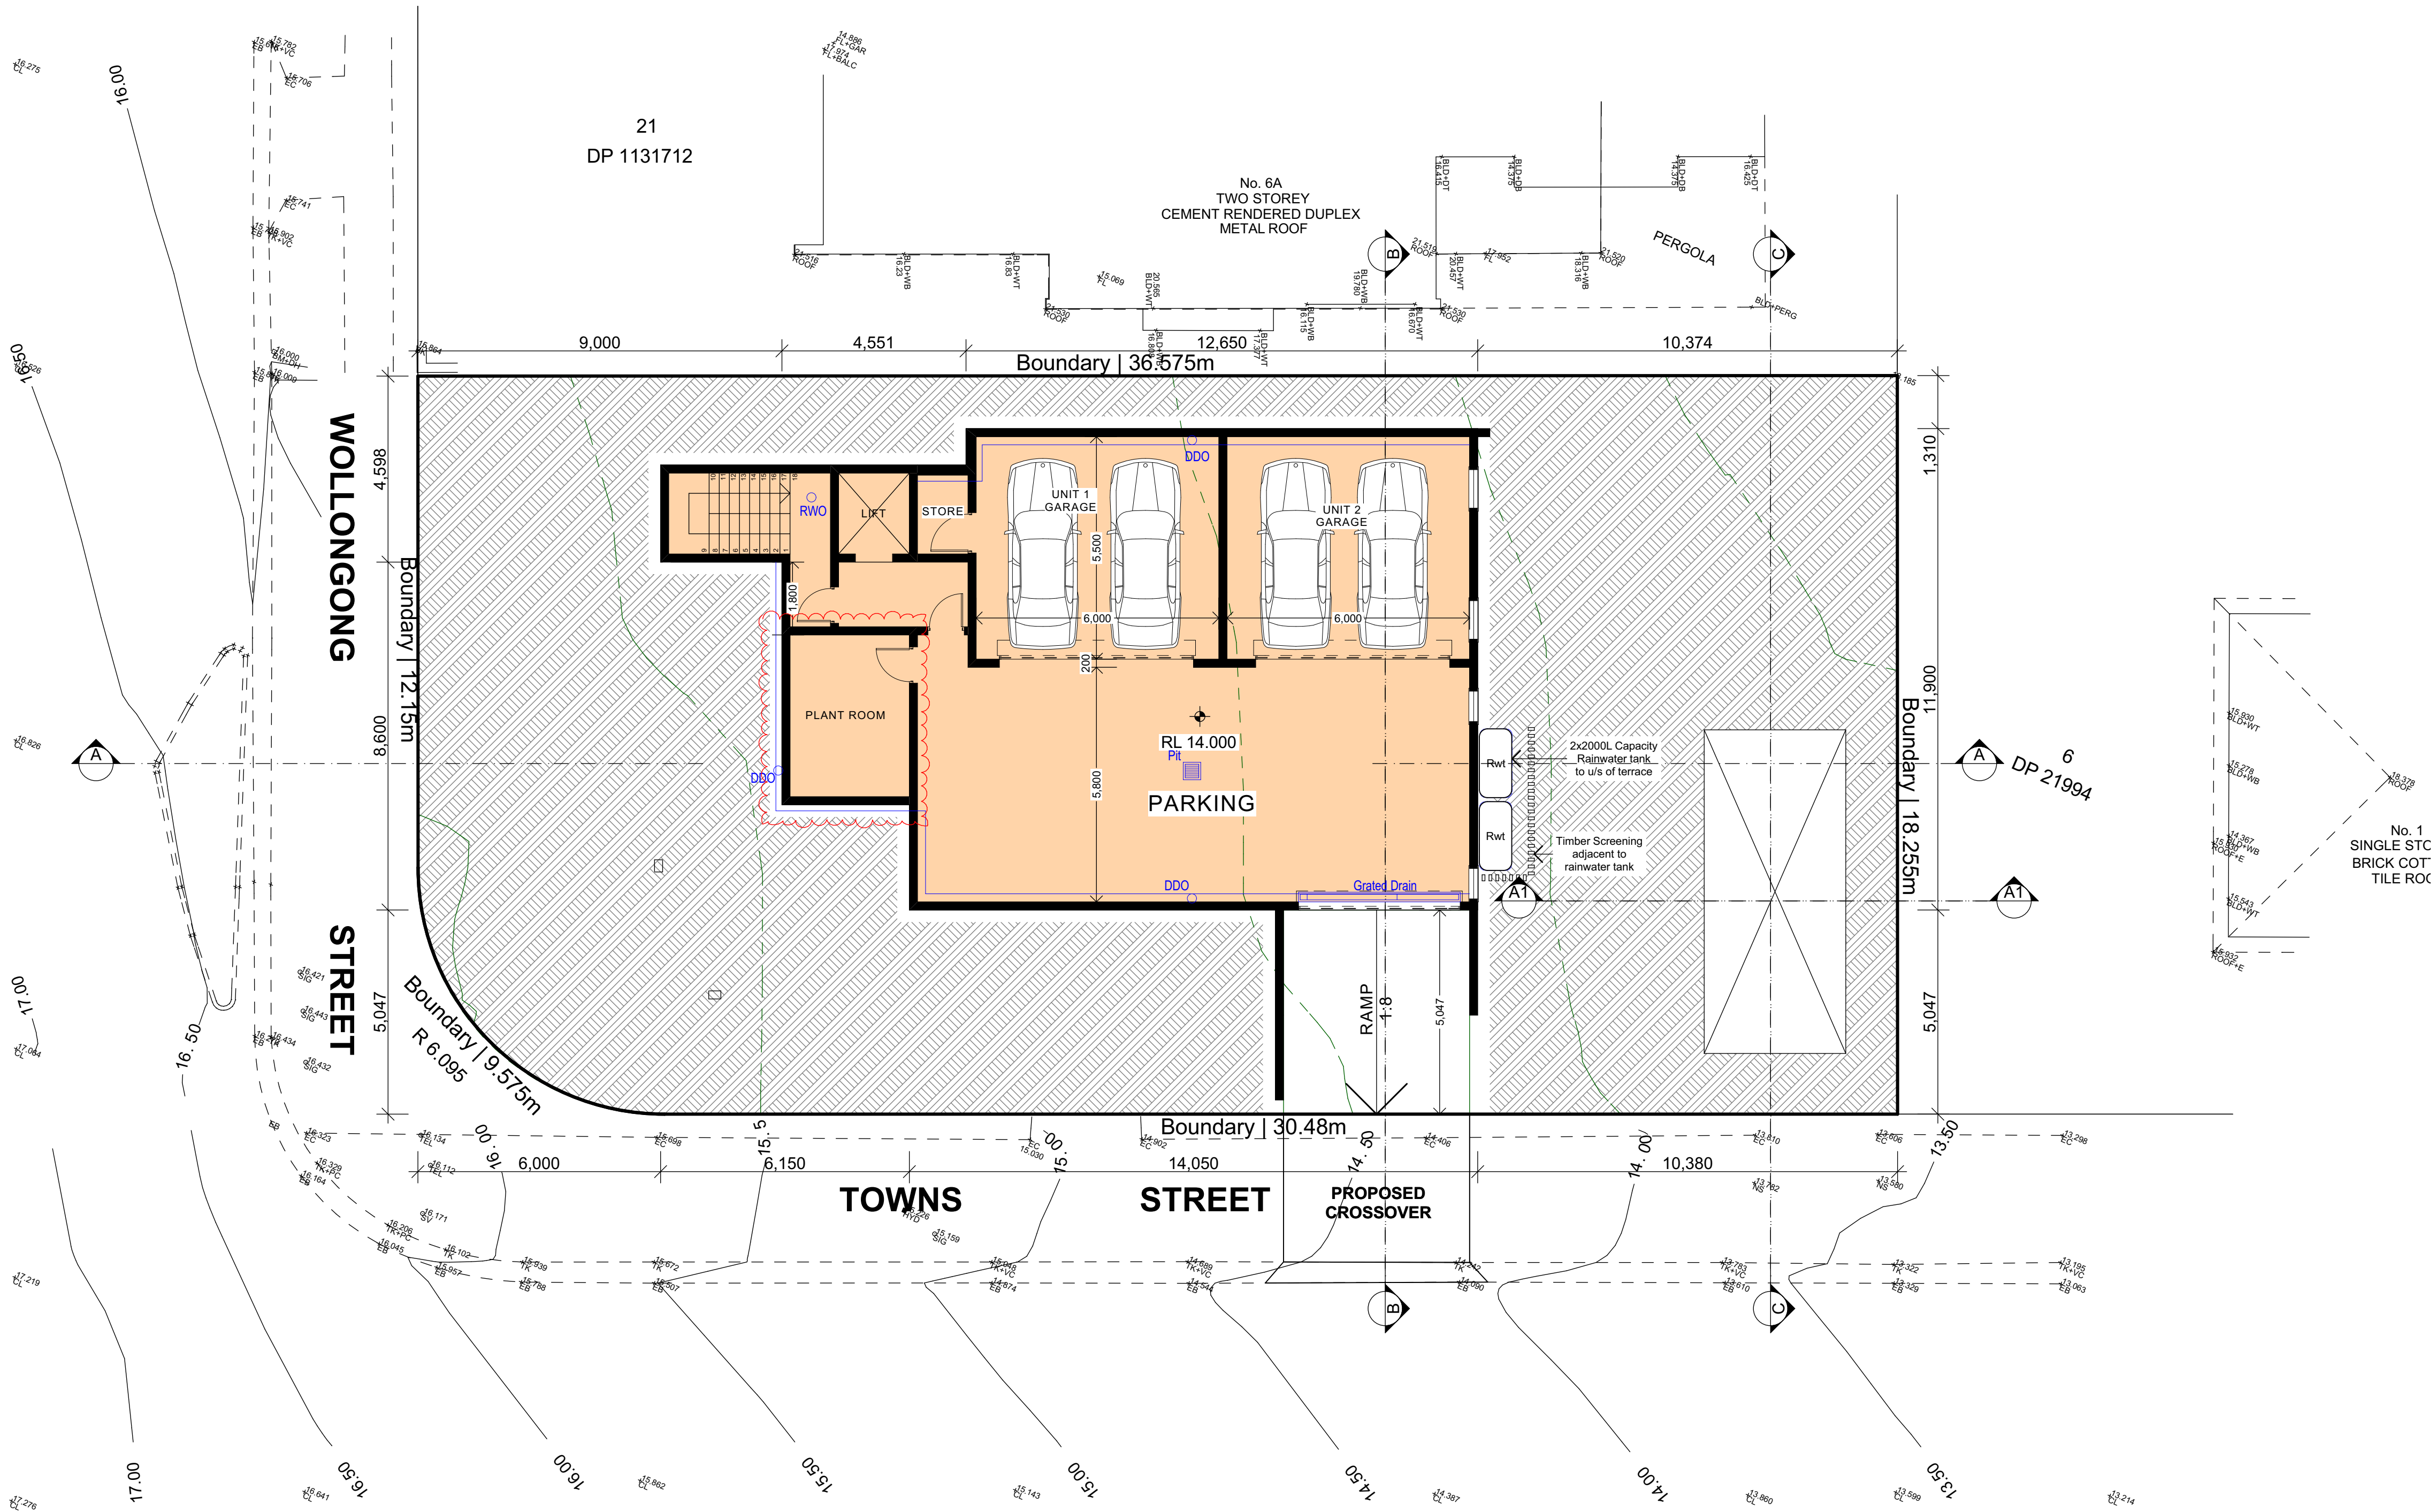


# 1 Car Parking Layout

1:100

## DEVELOPMENT APPLICATION

ISSUE	DESCRIPTION	DATE	NOTES	DESIGN LINK AUSTRALIA PTY LTD		DRAWING TITLE		SCALE	NORTH	Proposed Dual Occupancy 4 Wollongong Street, Shellharbour					
A	ISSUE FOR DEVELOPMENT APPLICATION LODGEMENT	05/06/20	The plans, drawings and specifications incorporated in this document shall remain the copyright © of DESIGN LINK AUSTRALIA PTY LTD and must not be used, reproduced or copied wholly or in part without prior written consent of DESIGN LINK AUSTRALIA PTY LTD.  <b>Figured dimensions shall take preference over scaling. Verify all dimensions on site</b>	a Suite 1, Level 5, 410 Church St, Parramatta, NSW 2150 p PO BOX 3085 North Strathfield NSW 2137 p 02 9744 3116 e info@design-link.com.au		Car Parking Plan		1:100 @ A1 or 1:200 @ A3		JOB No. 01820_DA	DATE 29/01/2021	DRAWN J.D	CHECKED A.M	SCALE As Shown on A1	
B	ISSUE FOR DEVELOPMENT APPLICATION LODGEMENT	16/10/20													
C	REVISED FOR APPROVAL	29/01/21													
D	REVISED FOR APPROVAL	29/01/21													



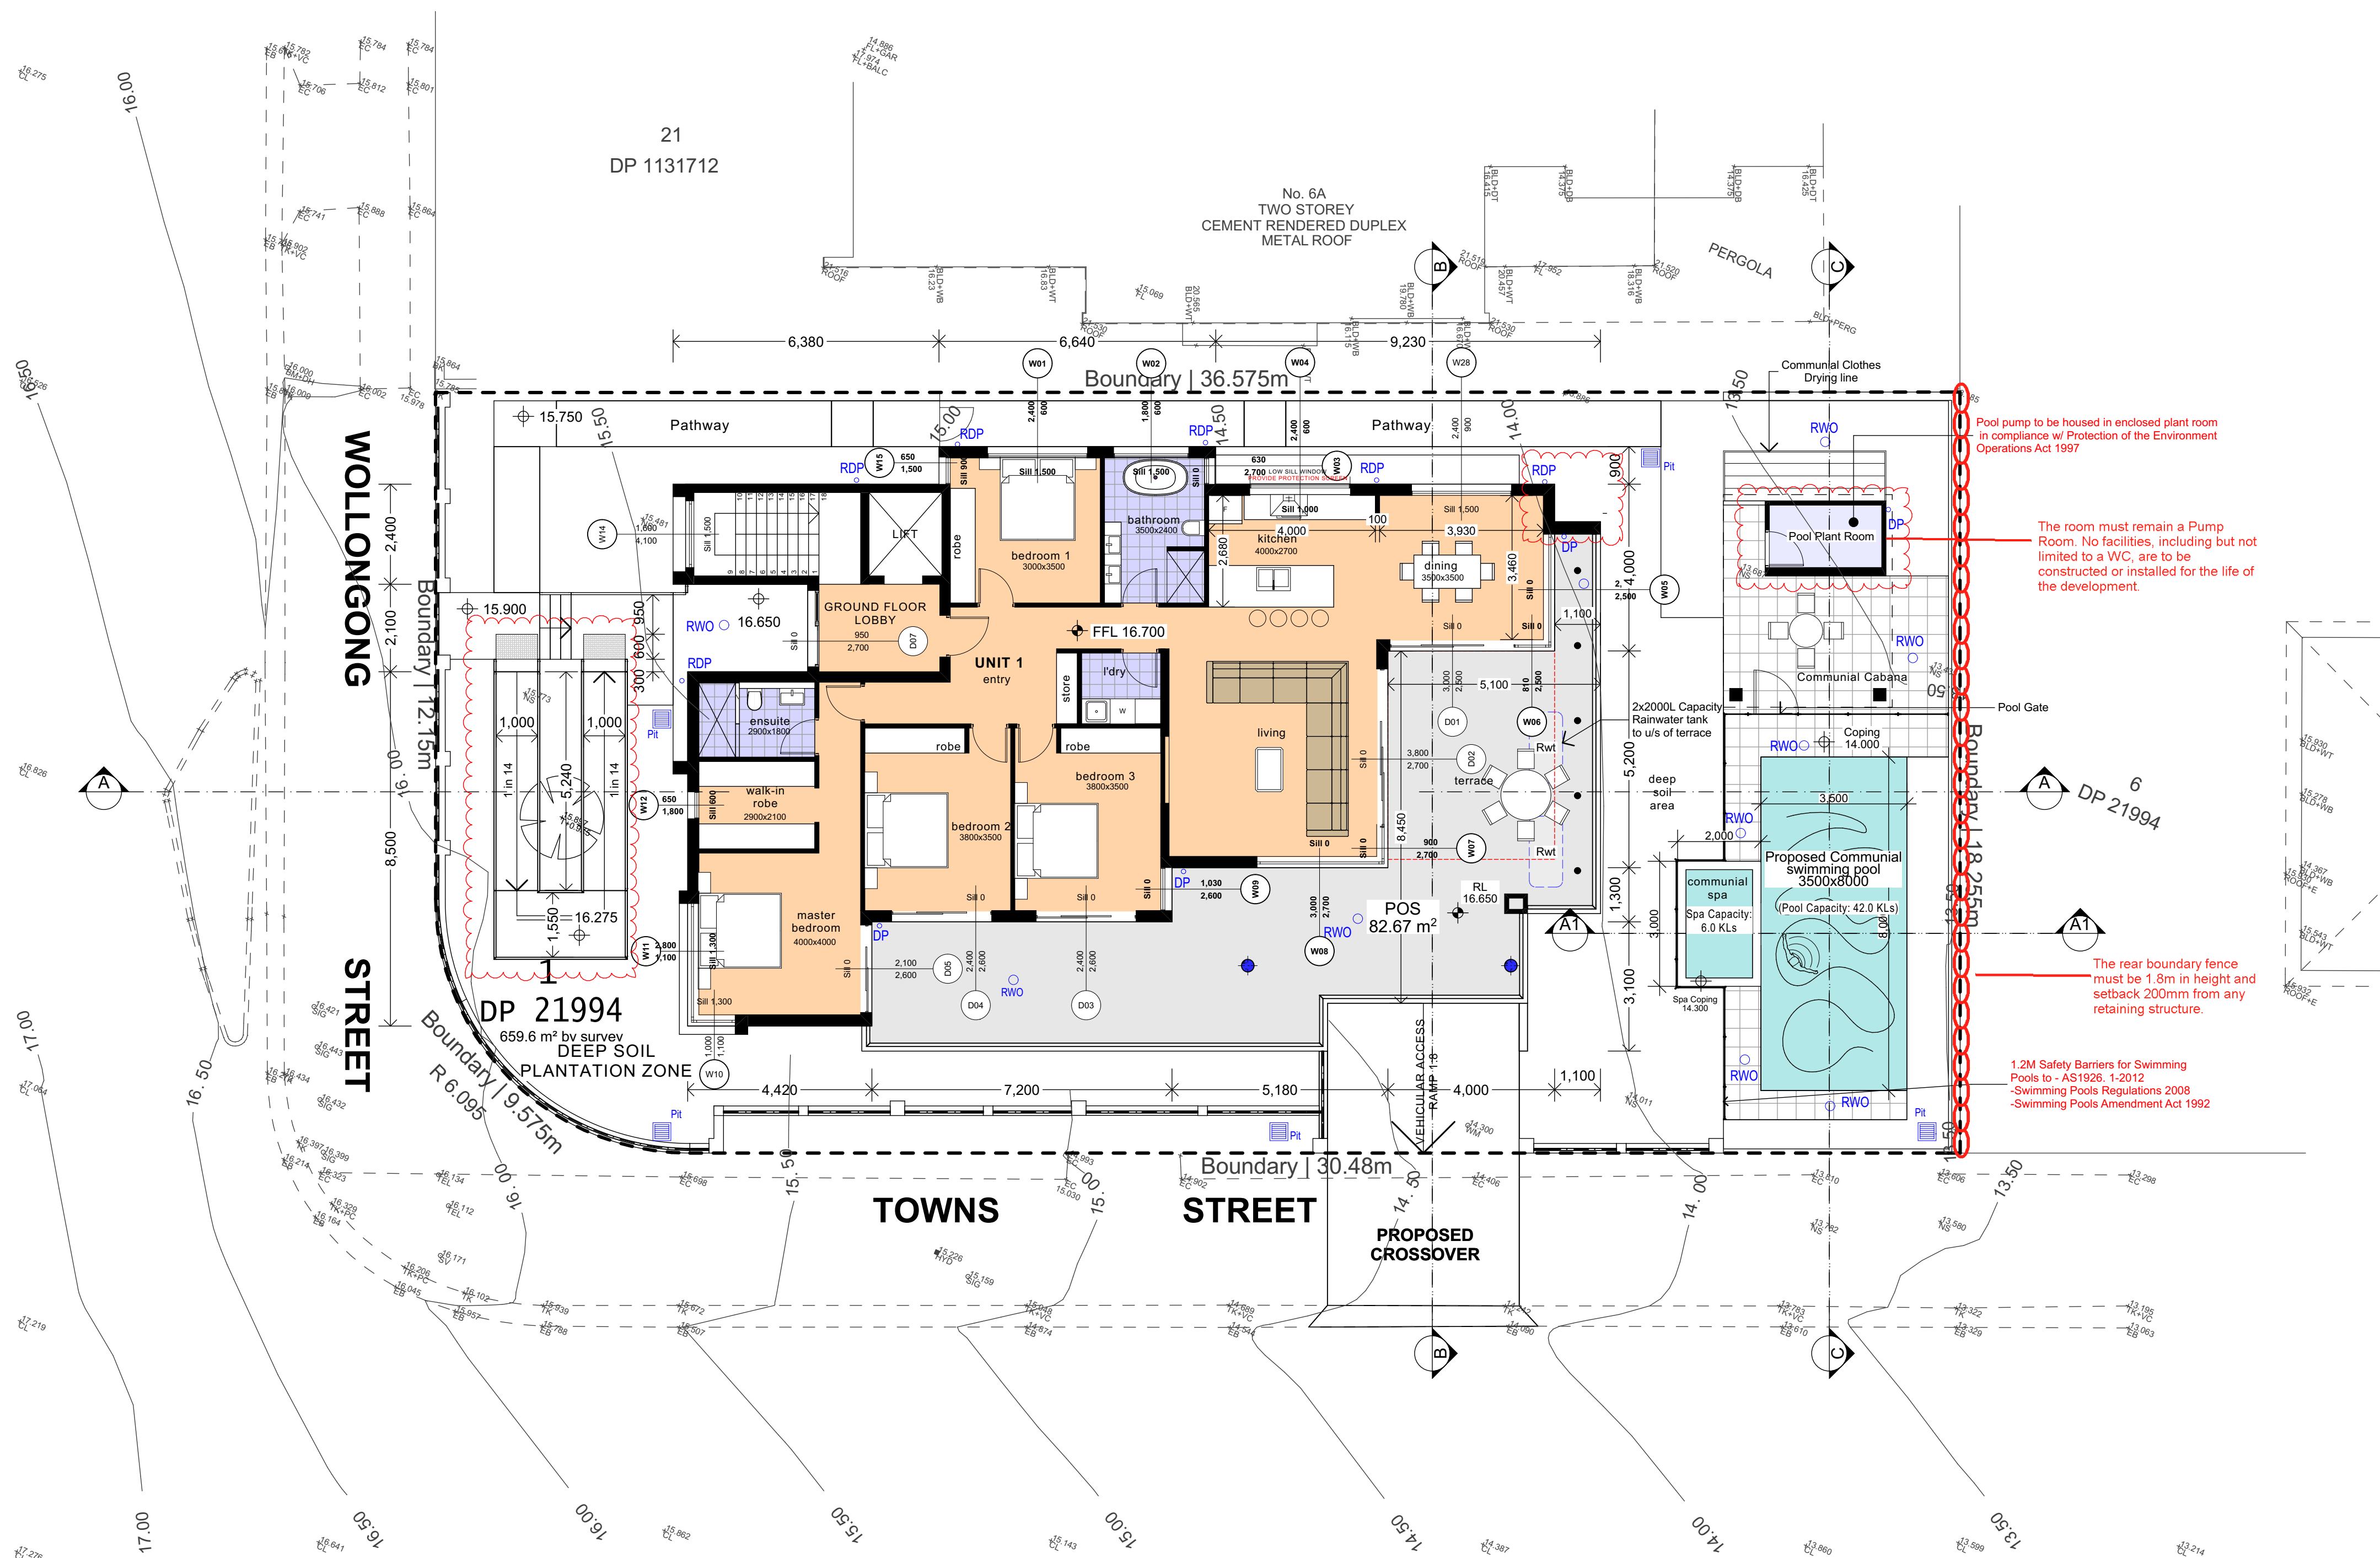


# 1

## Ground Floor Plan

1:100

## DEVELOPMENT APPLICATION

ISSUE	DESCRIPTION	DATE	NOTES	DRAWING TITLE	SCALE	NORTH	PROPOSED DUAL OCCUPANCY 4 Wollongong Street, Shellharbour
A	ISSUE FOR DEVELOPMENT APPLICATION LODGEMENT	05/06/20		Ground Floor Plan	1:100 @ A1 or 1:200 @ A3		
B	ISSUE FOR DEVELOPMENT APPLICATION LODGEMENT	16/10/20					
C	REVISED FOR APPROVAL	29/01/21					
D	REVISED FOR APPROVAL	29/01/21					
Figured dimensions shall take preference over scaling. Verify all dimensions on site				DA08			
DESIGN LINK AUSTRALIA PTY LTD a Suite 1, Level 5, 410 Church St, Parramatta, NSW 2150 p PO BOX 3085 North Strathfield NSW 2137 p 02 9744 3116 e info@design-link.com.au				JOB No. 01820_DA	DATE 29/01/2021	DRAWN J.D.	CHECKED A.M. SCALE As Shown on A1

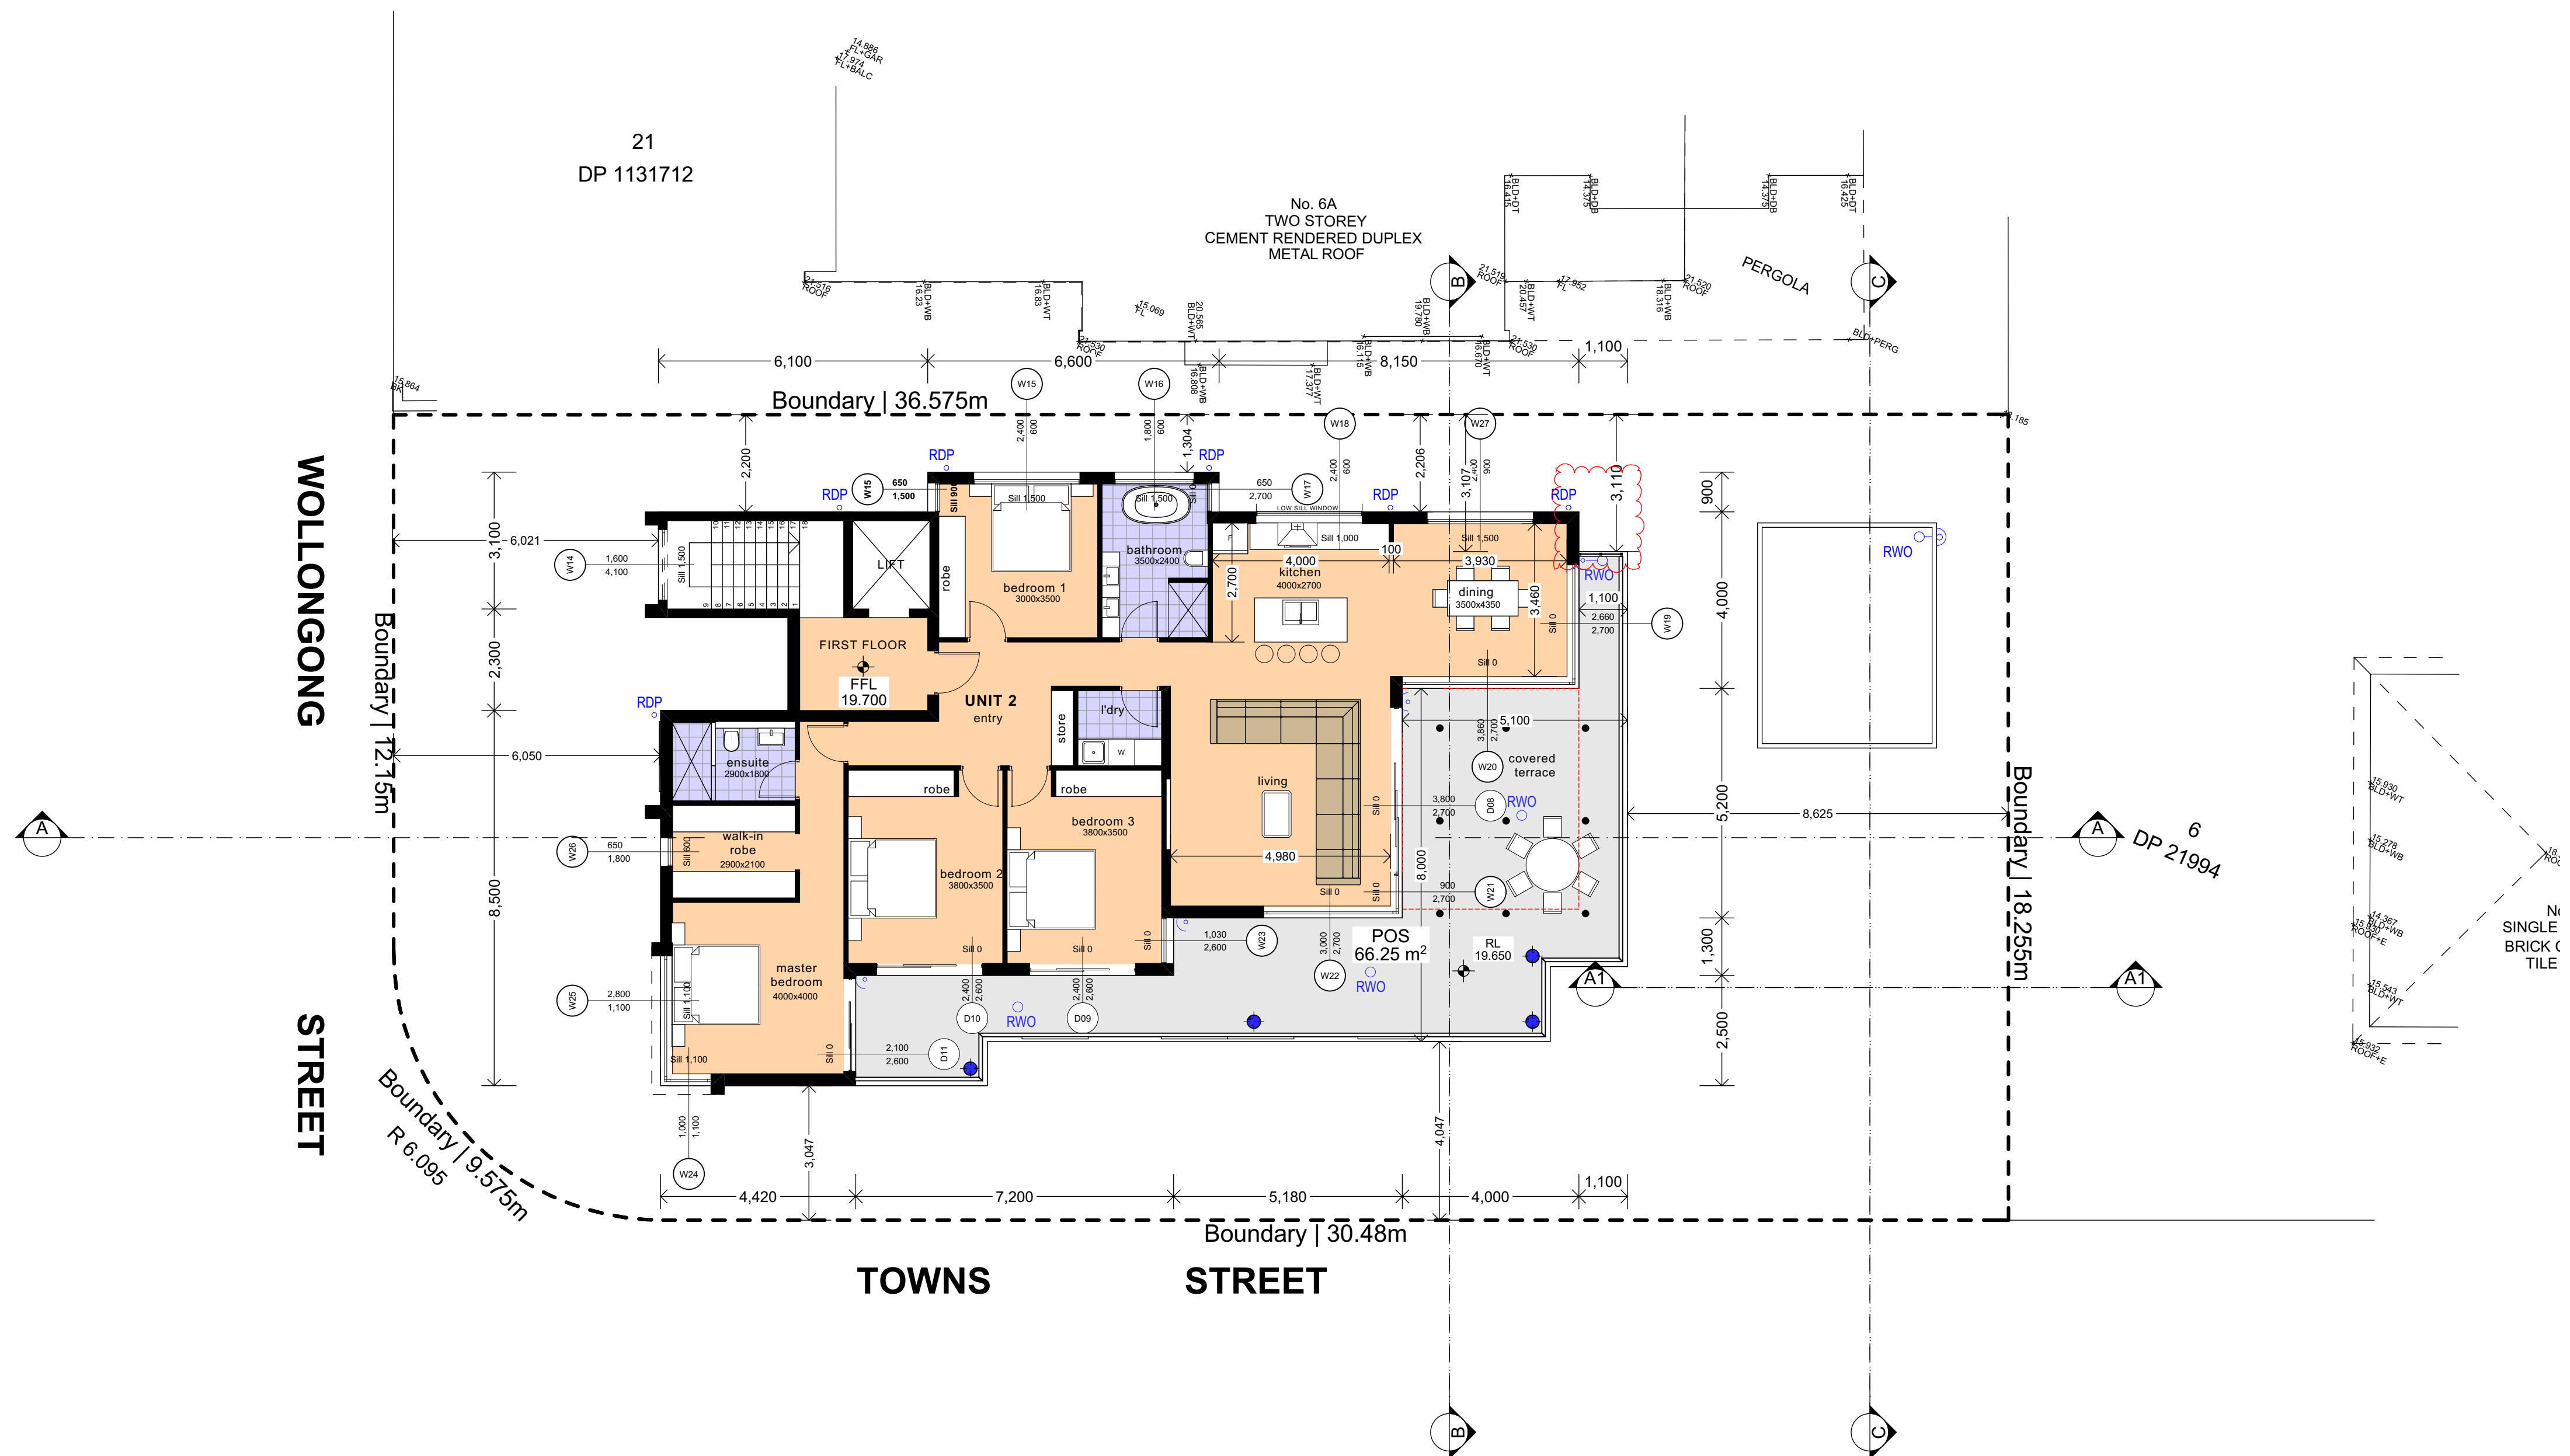

# 1 First Floor Plan


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## DEVELOPMENT APPLICATION

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D	REVISED FOR APPROVAL	29/01/21	

DESIGN LINK AUSTRALIA PTY LTD a Suite 1, Level 5, 410 Church St Parramatta, NSW 2150 p PO BOX 3085 North Strathfield NSW 1585 p 02 9744 3116 e info@designlink.com.au	<b>First Floor Plan</b> DRAWING NO <b>DA09</b>	DRAWING TITLE <b>First Floor Plan</b> DRAWING NO <b>DA09</b>	SCALE 1:100 @ A1 or 1:200 @ A3 0 0.5 1.0 2.0m	NORTH 	<b>Proposed Dual Occupancy</b> 4 Wollongong Street, Shellharbour	JOB No. 01820_DA	DATE 29/01/2021	DRAWN J.D	CHECKED A.M	SCALE As Shown on A1
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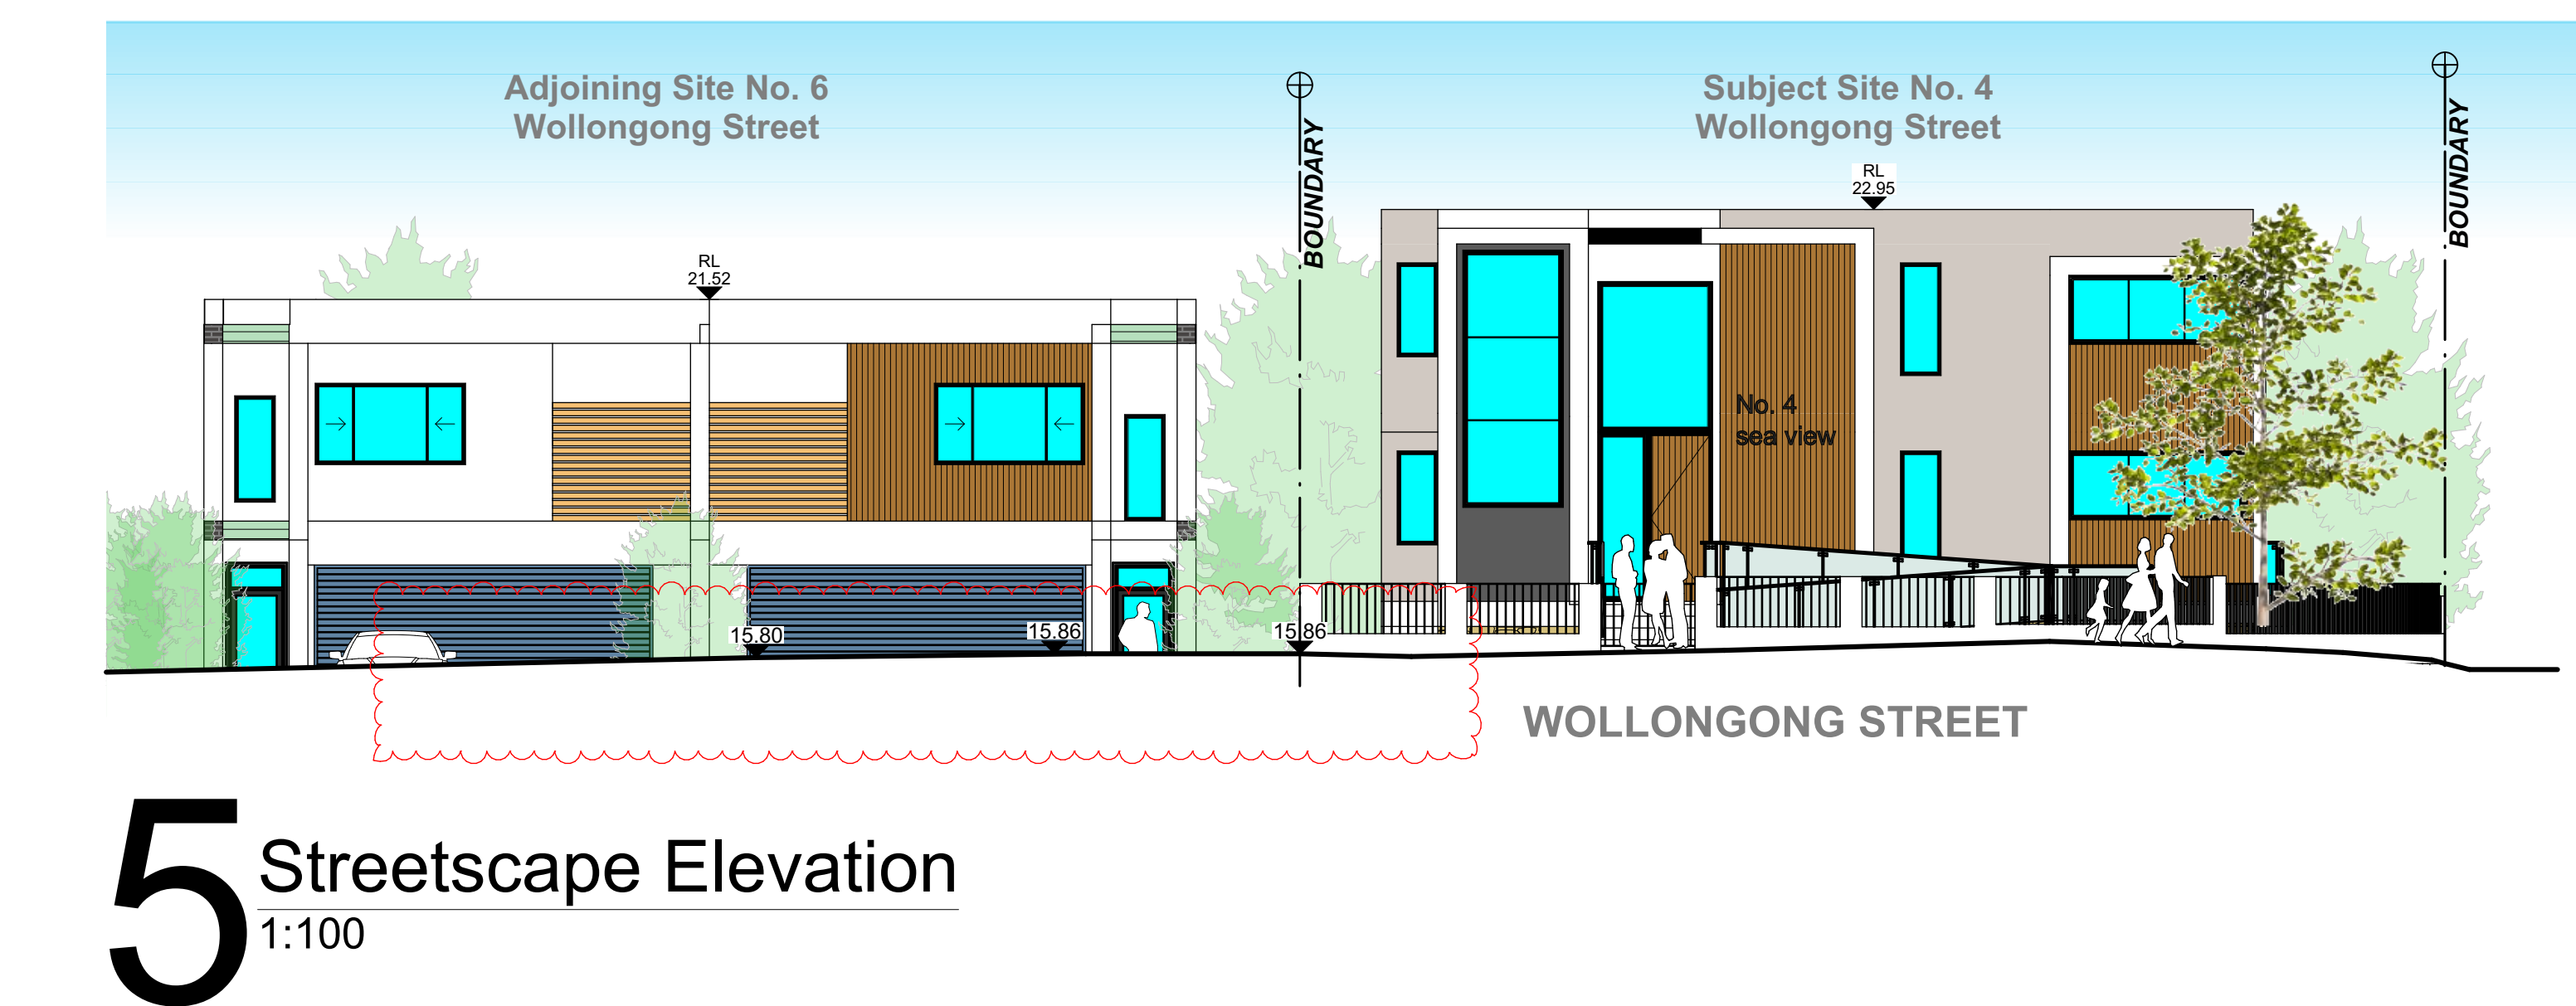
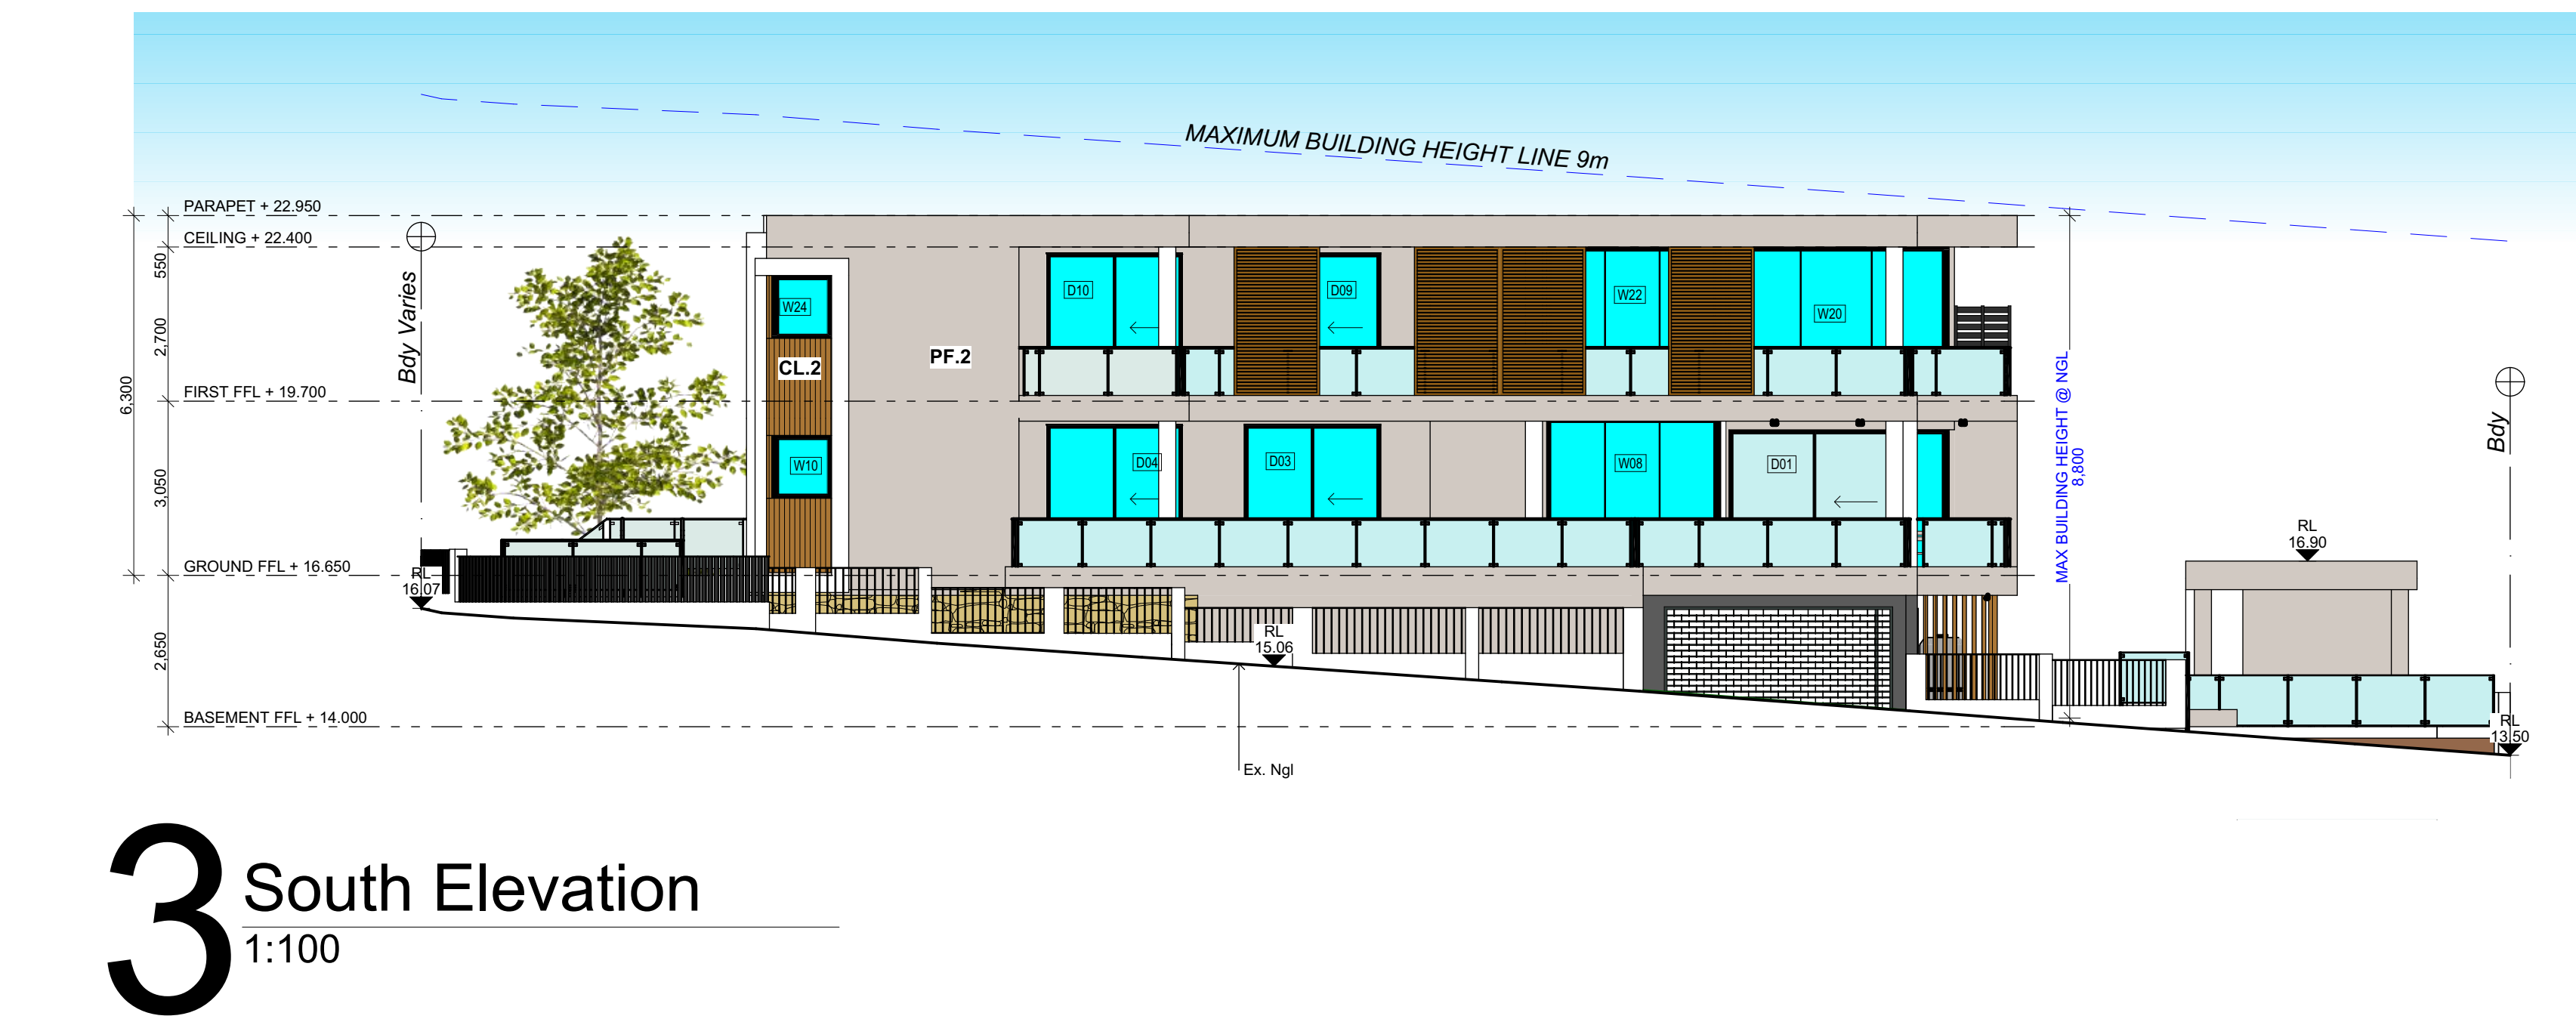
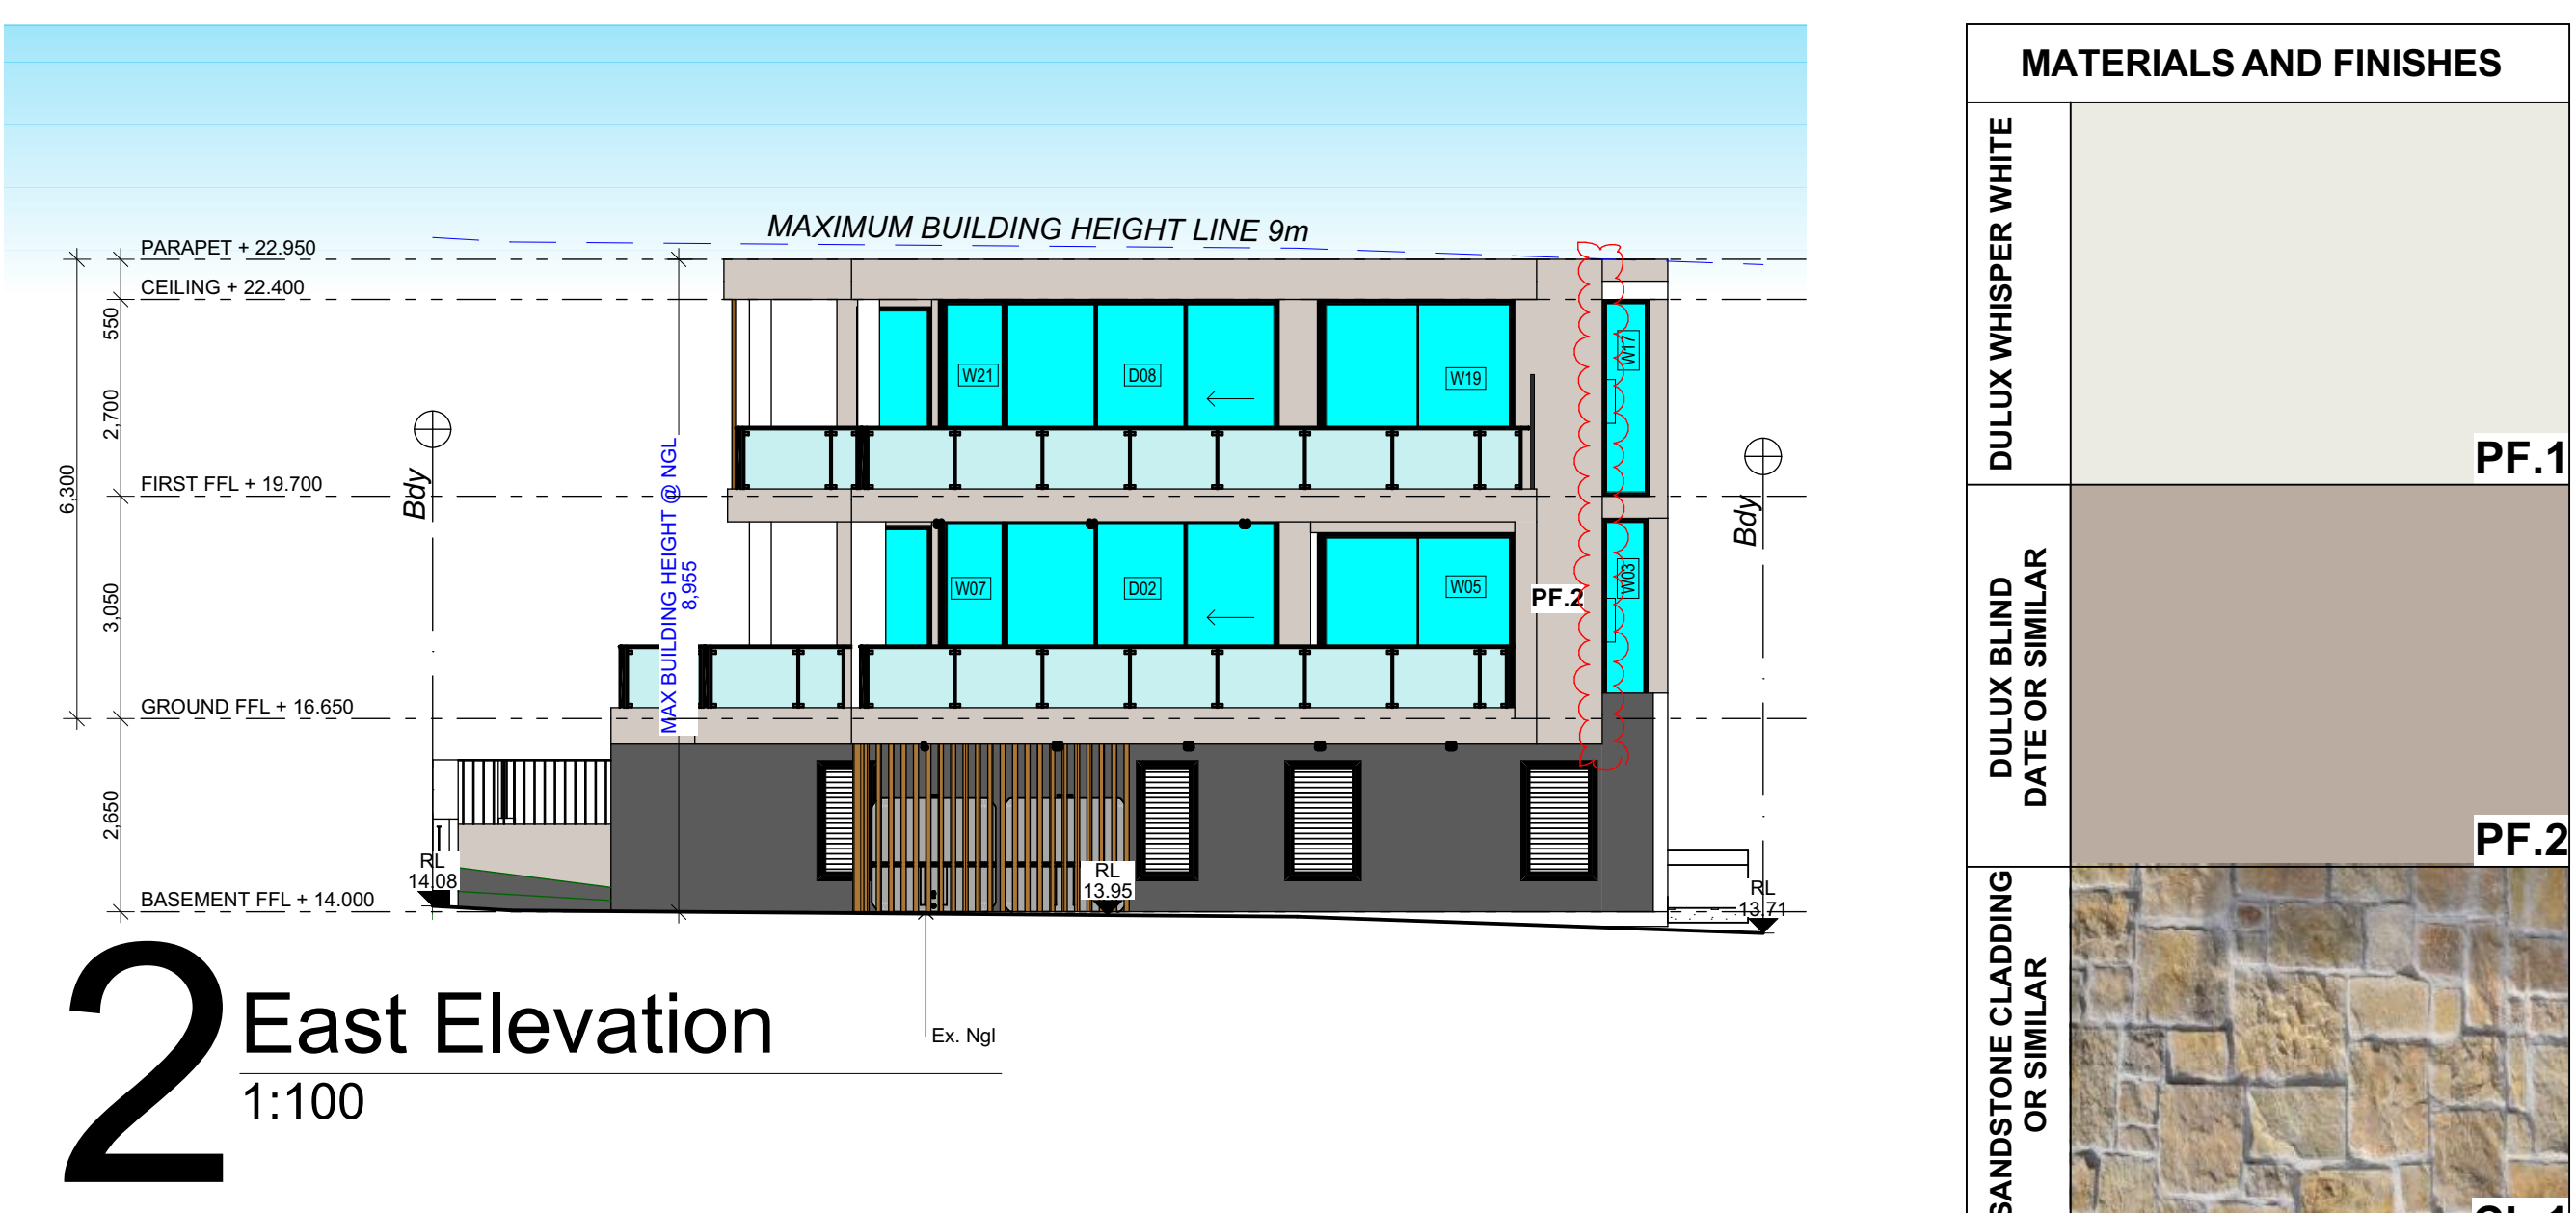
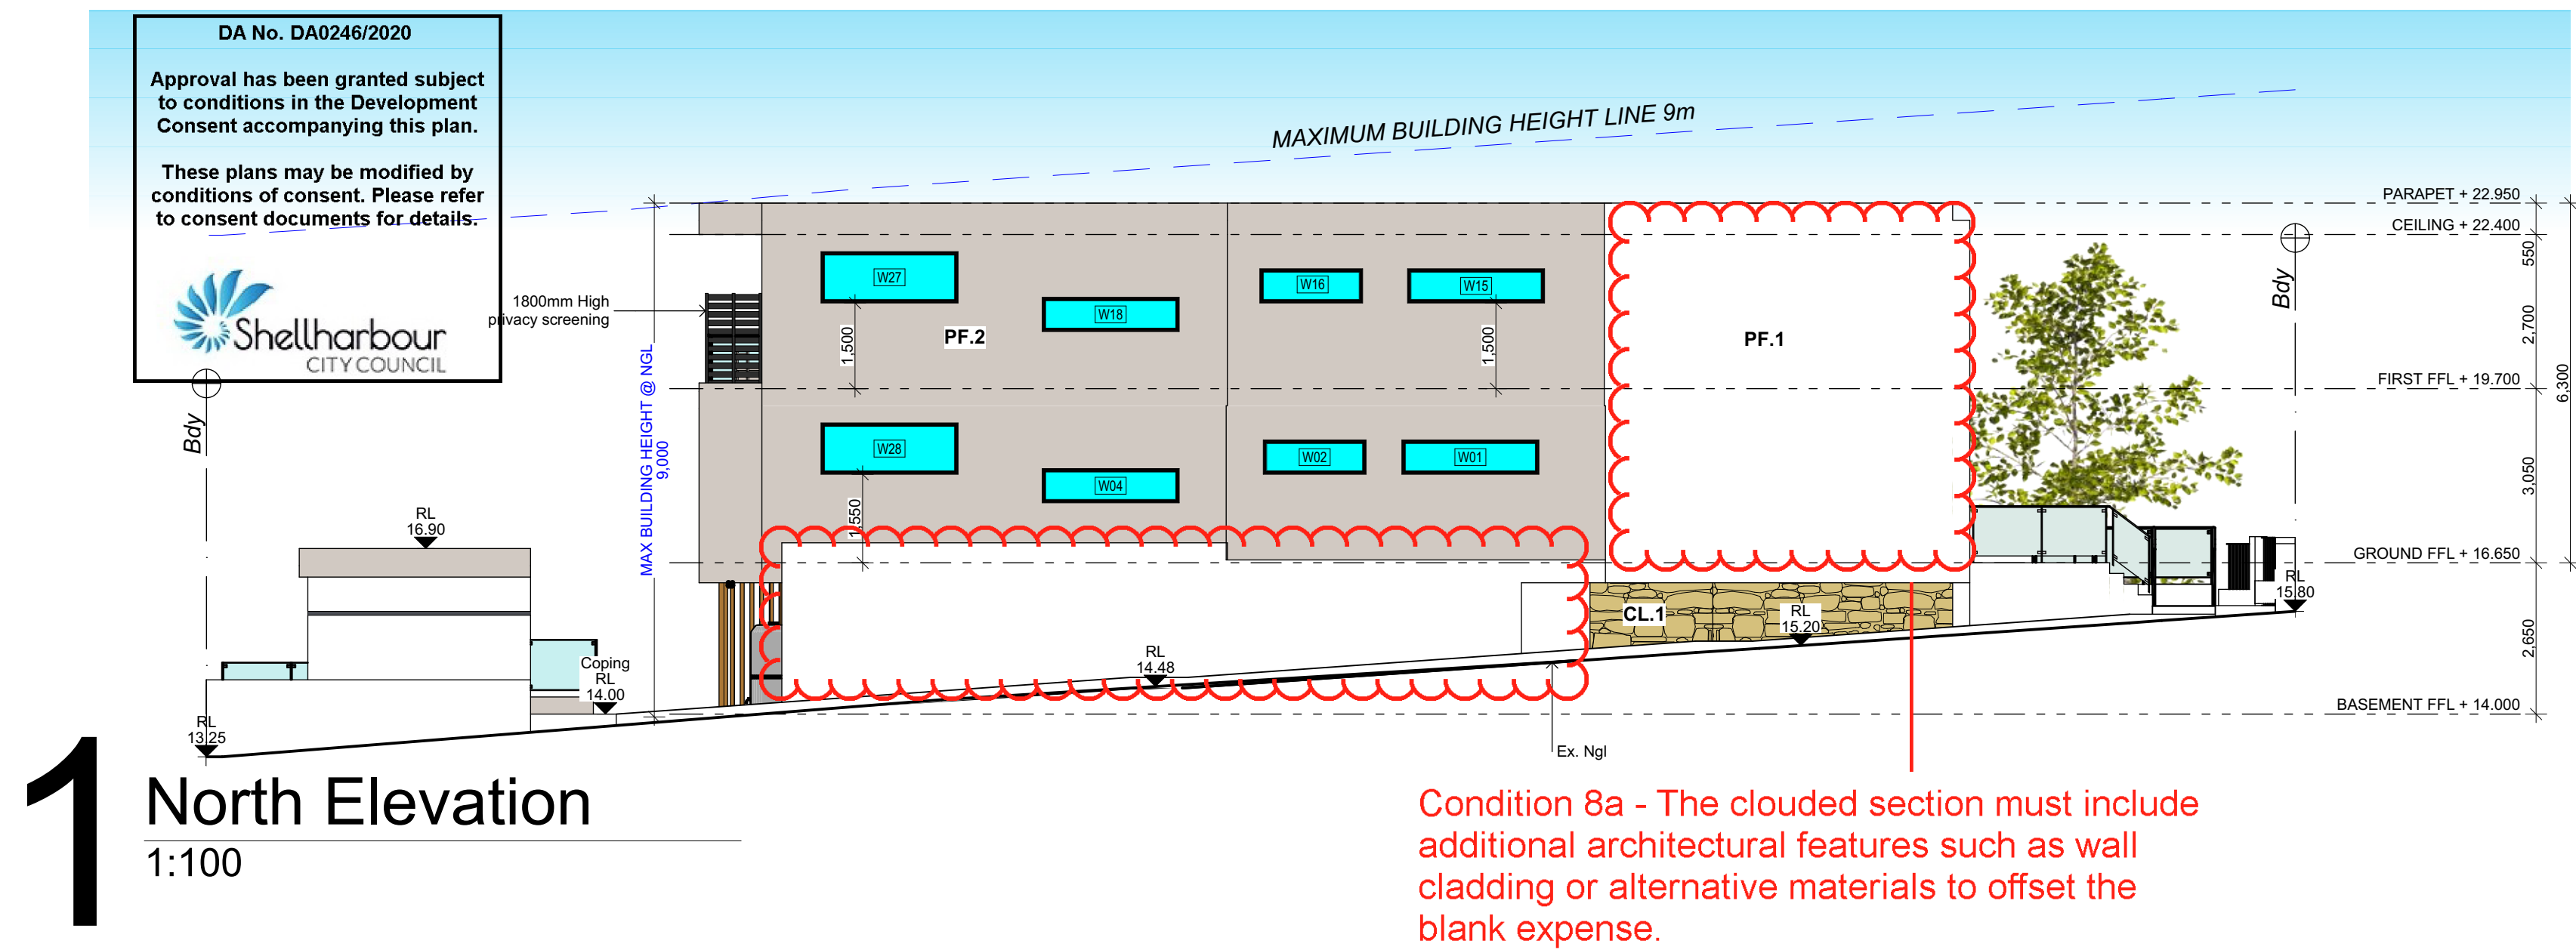
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Roof Plan

1:100

DEVELOPMENT APPLICATION

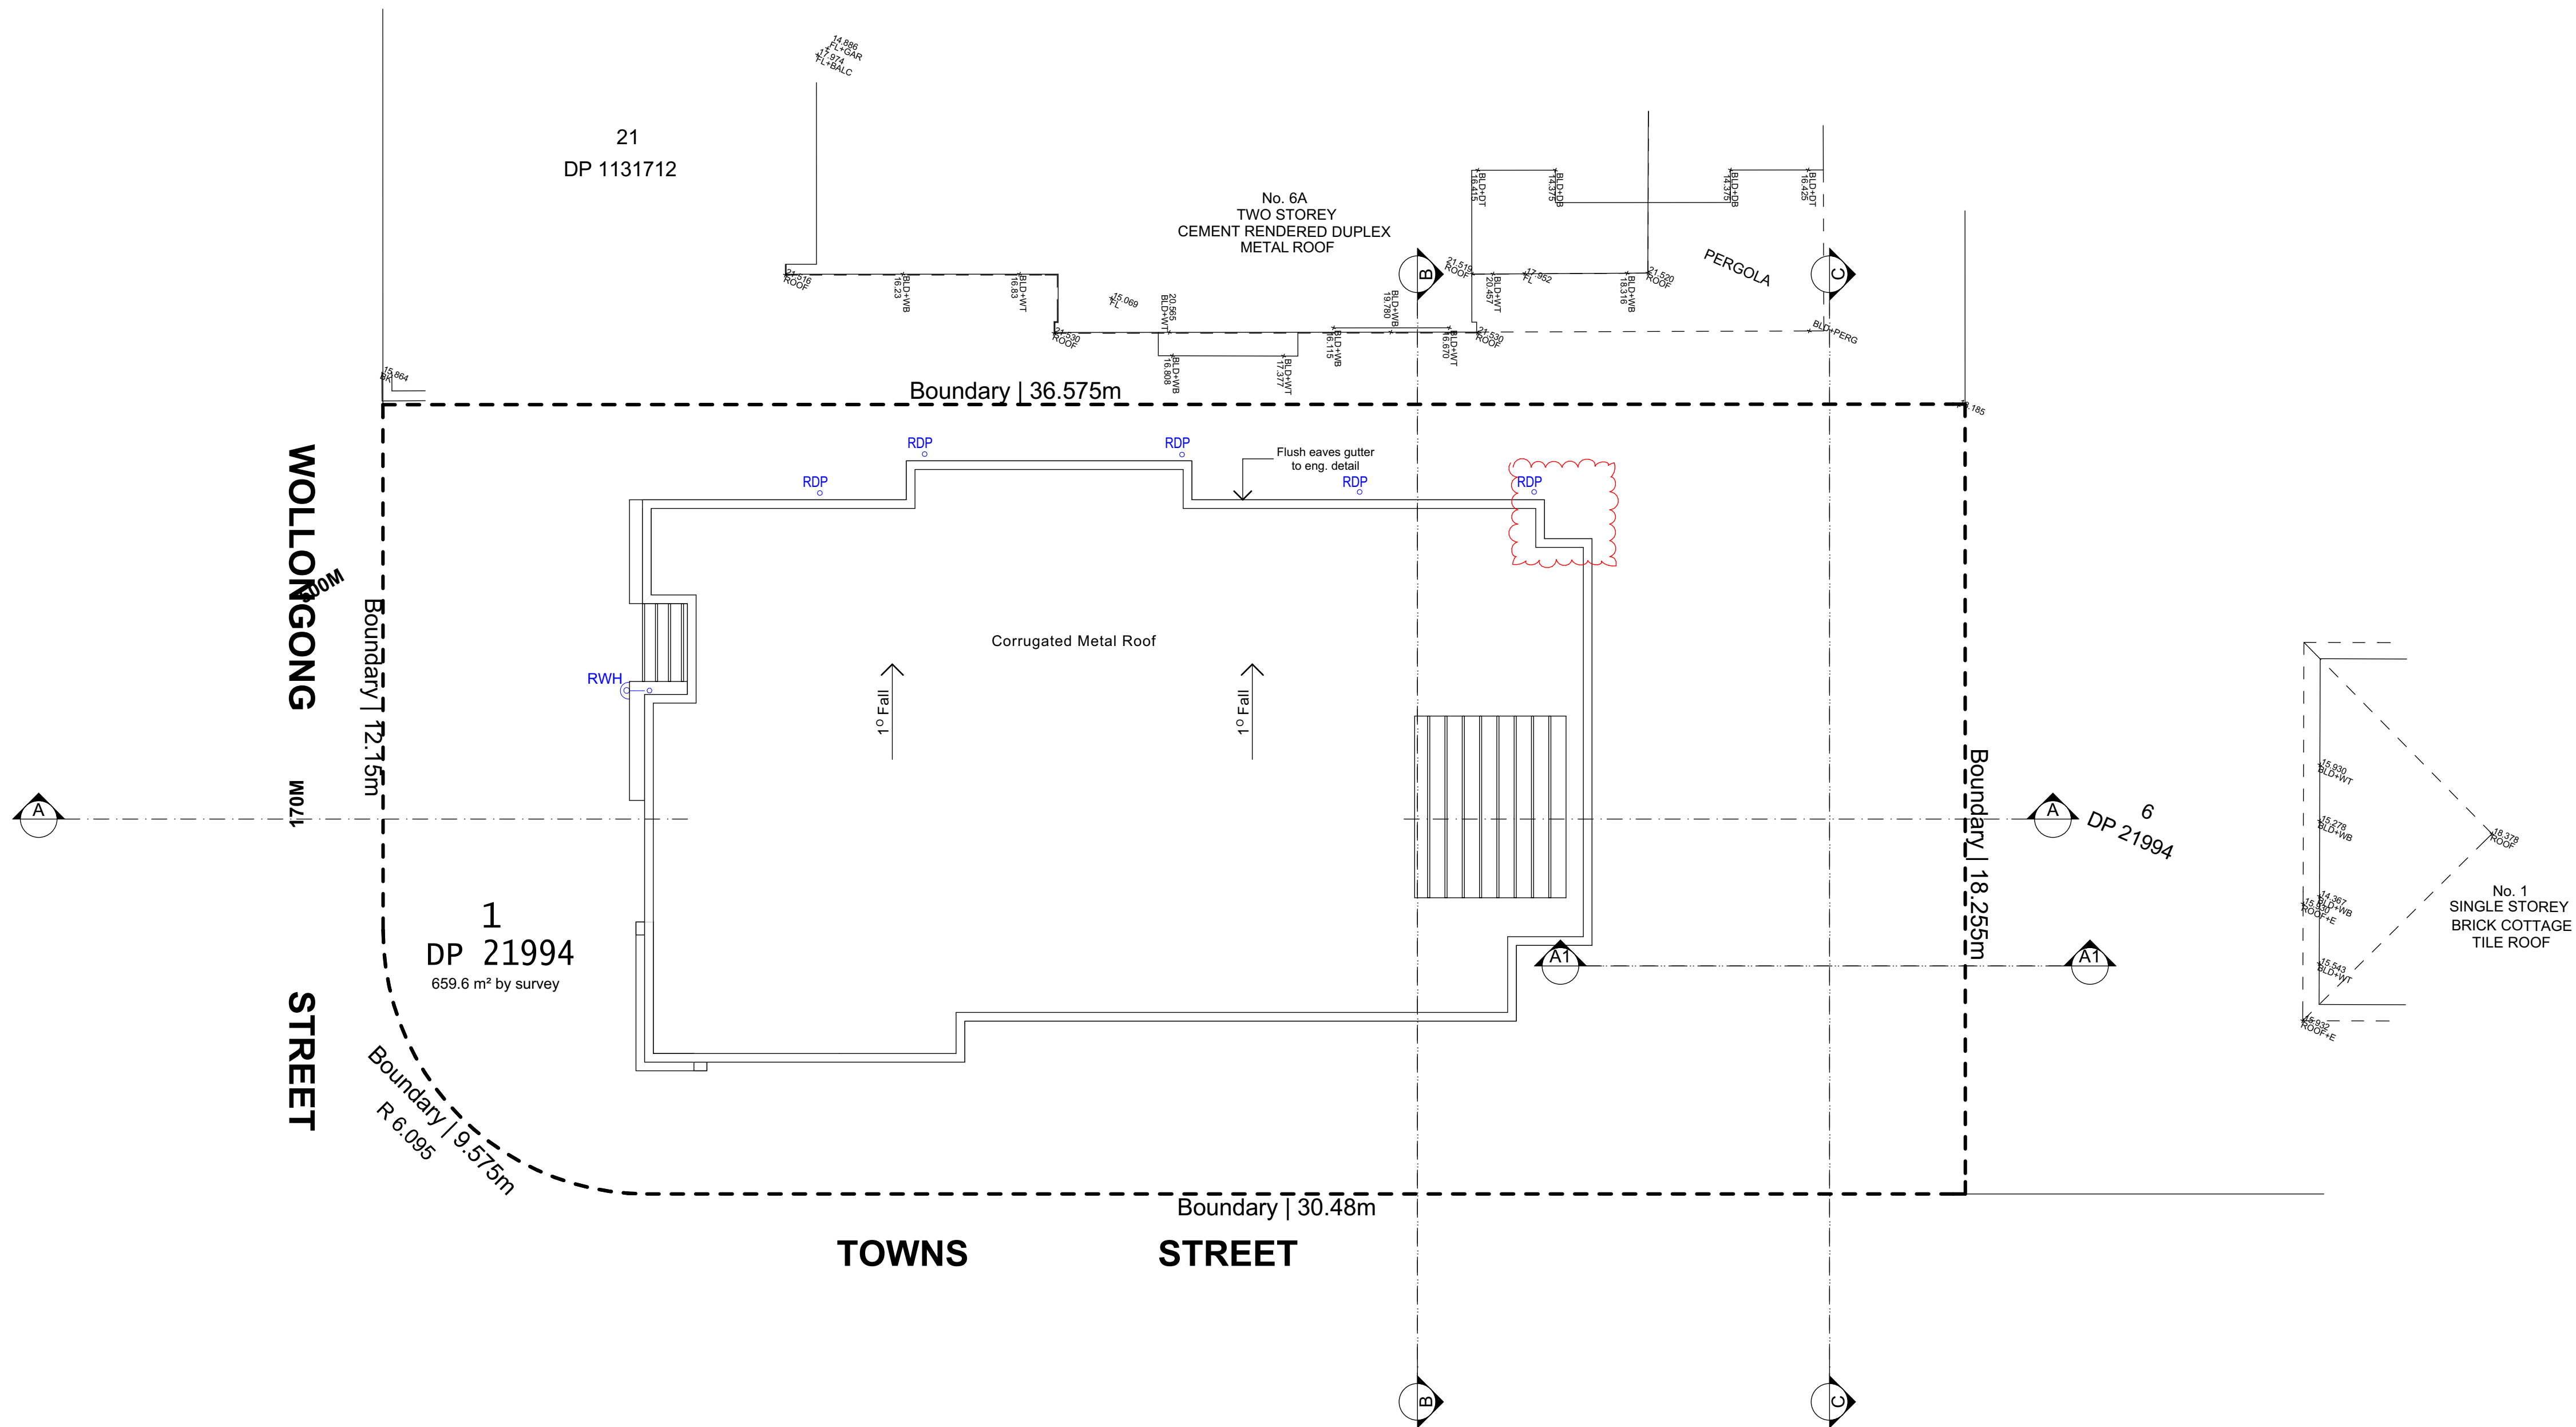




DEVELOPMENT APPLICATION









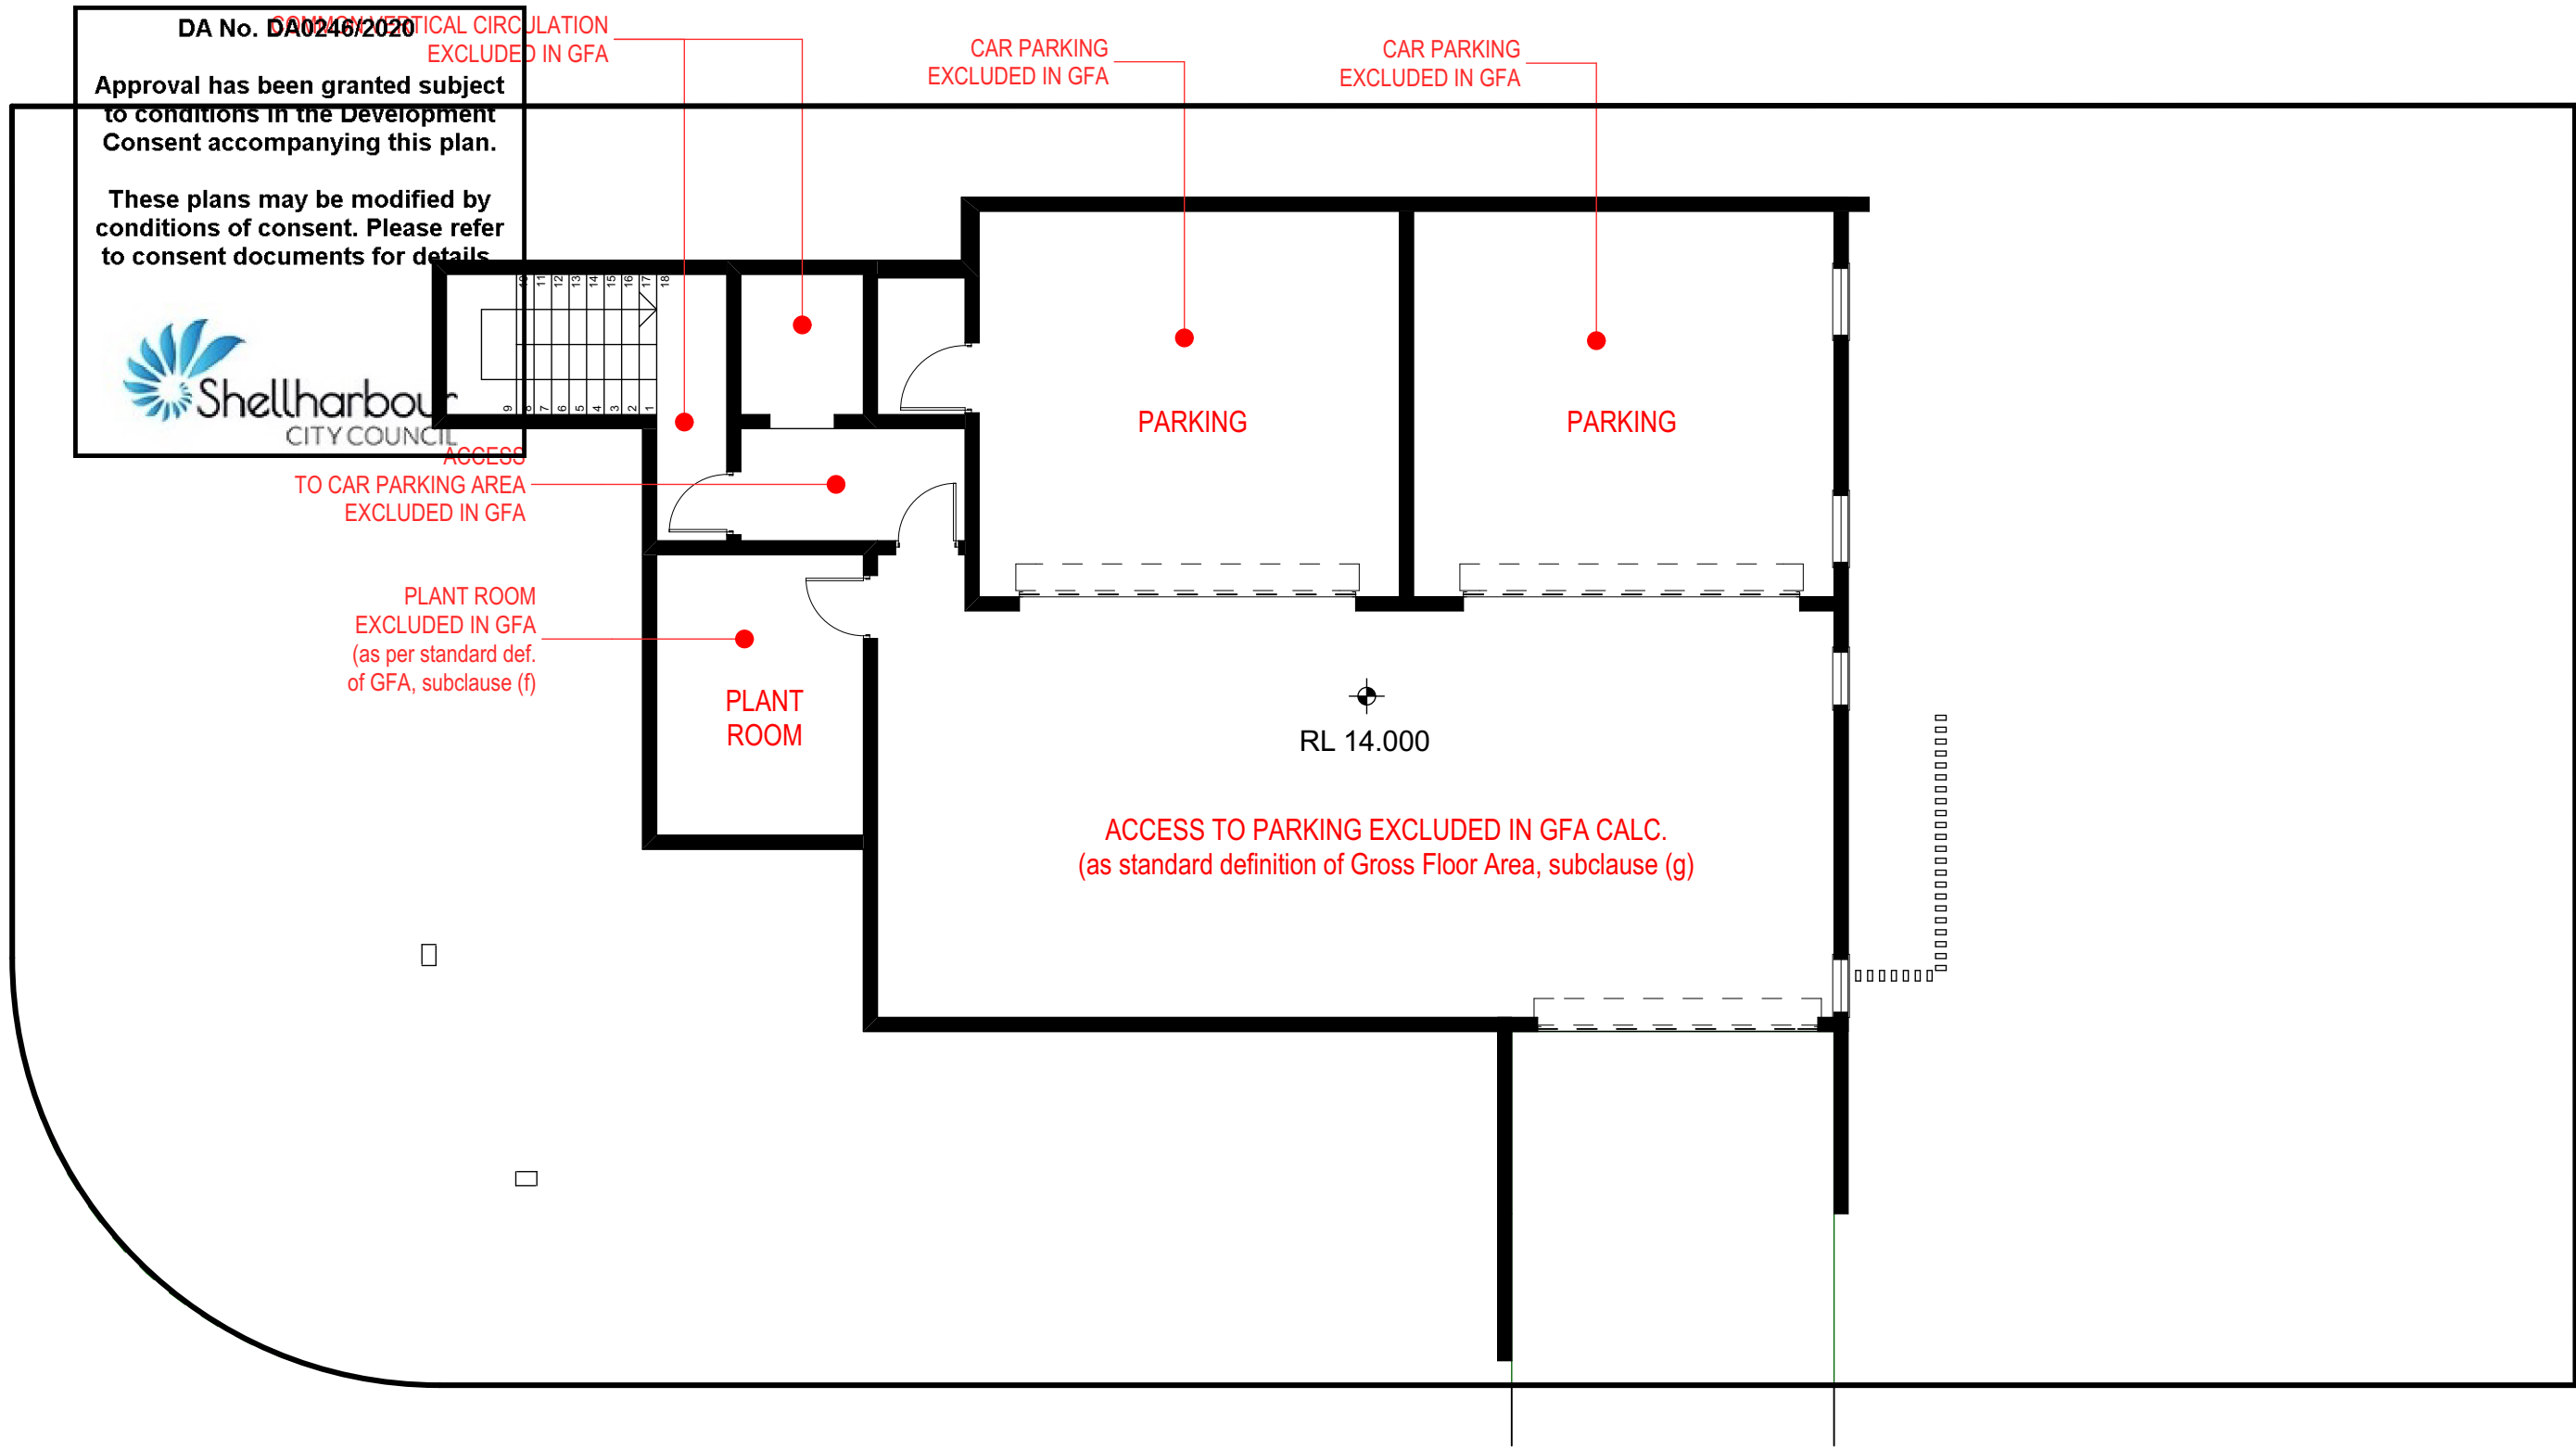

1 Basement Plan - Area Calculation  
1:100

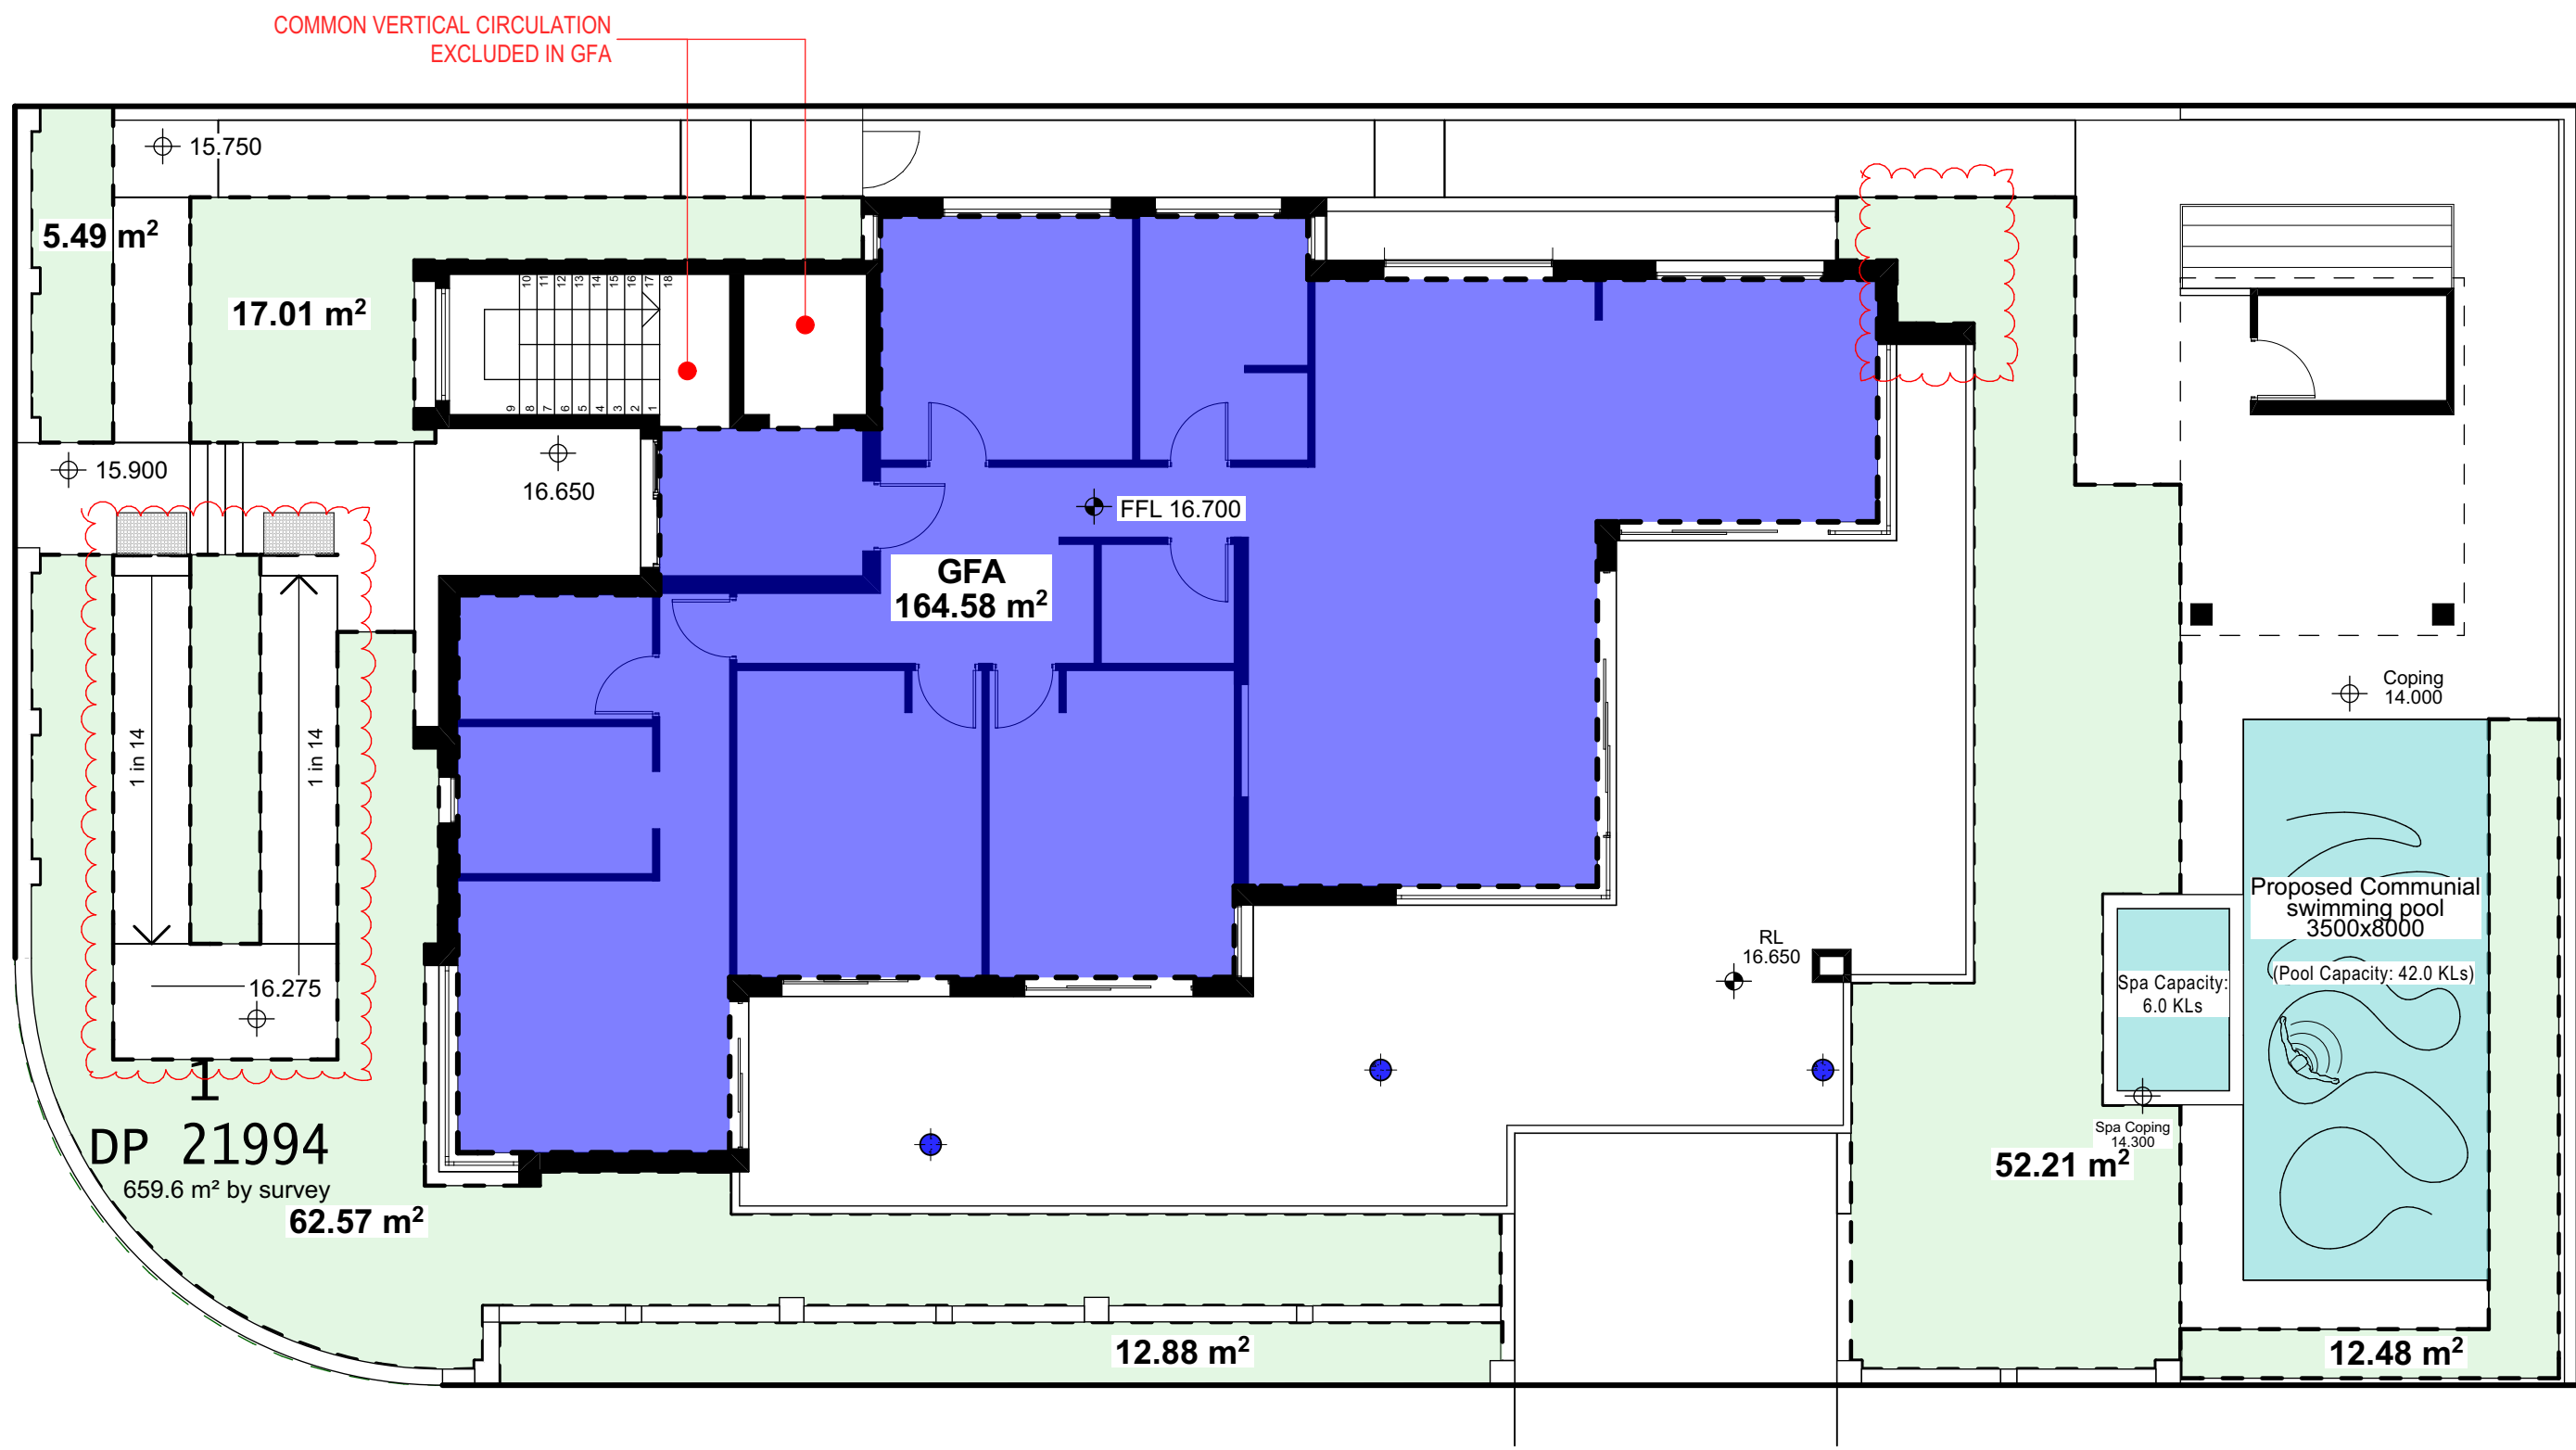

2 Ground Floor Plan - Area Calculation  
1:100

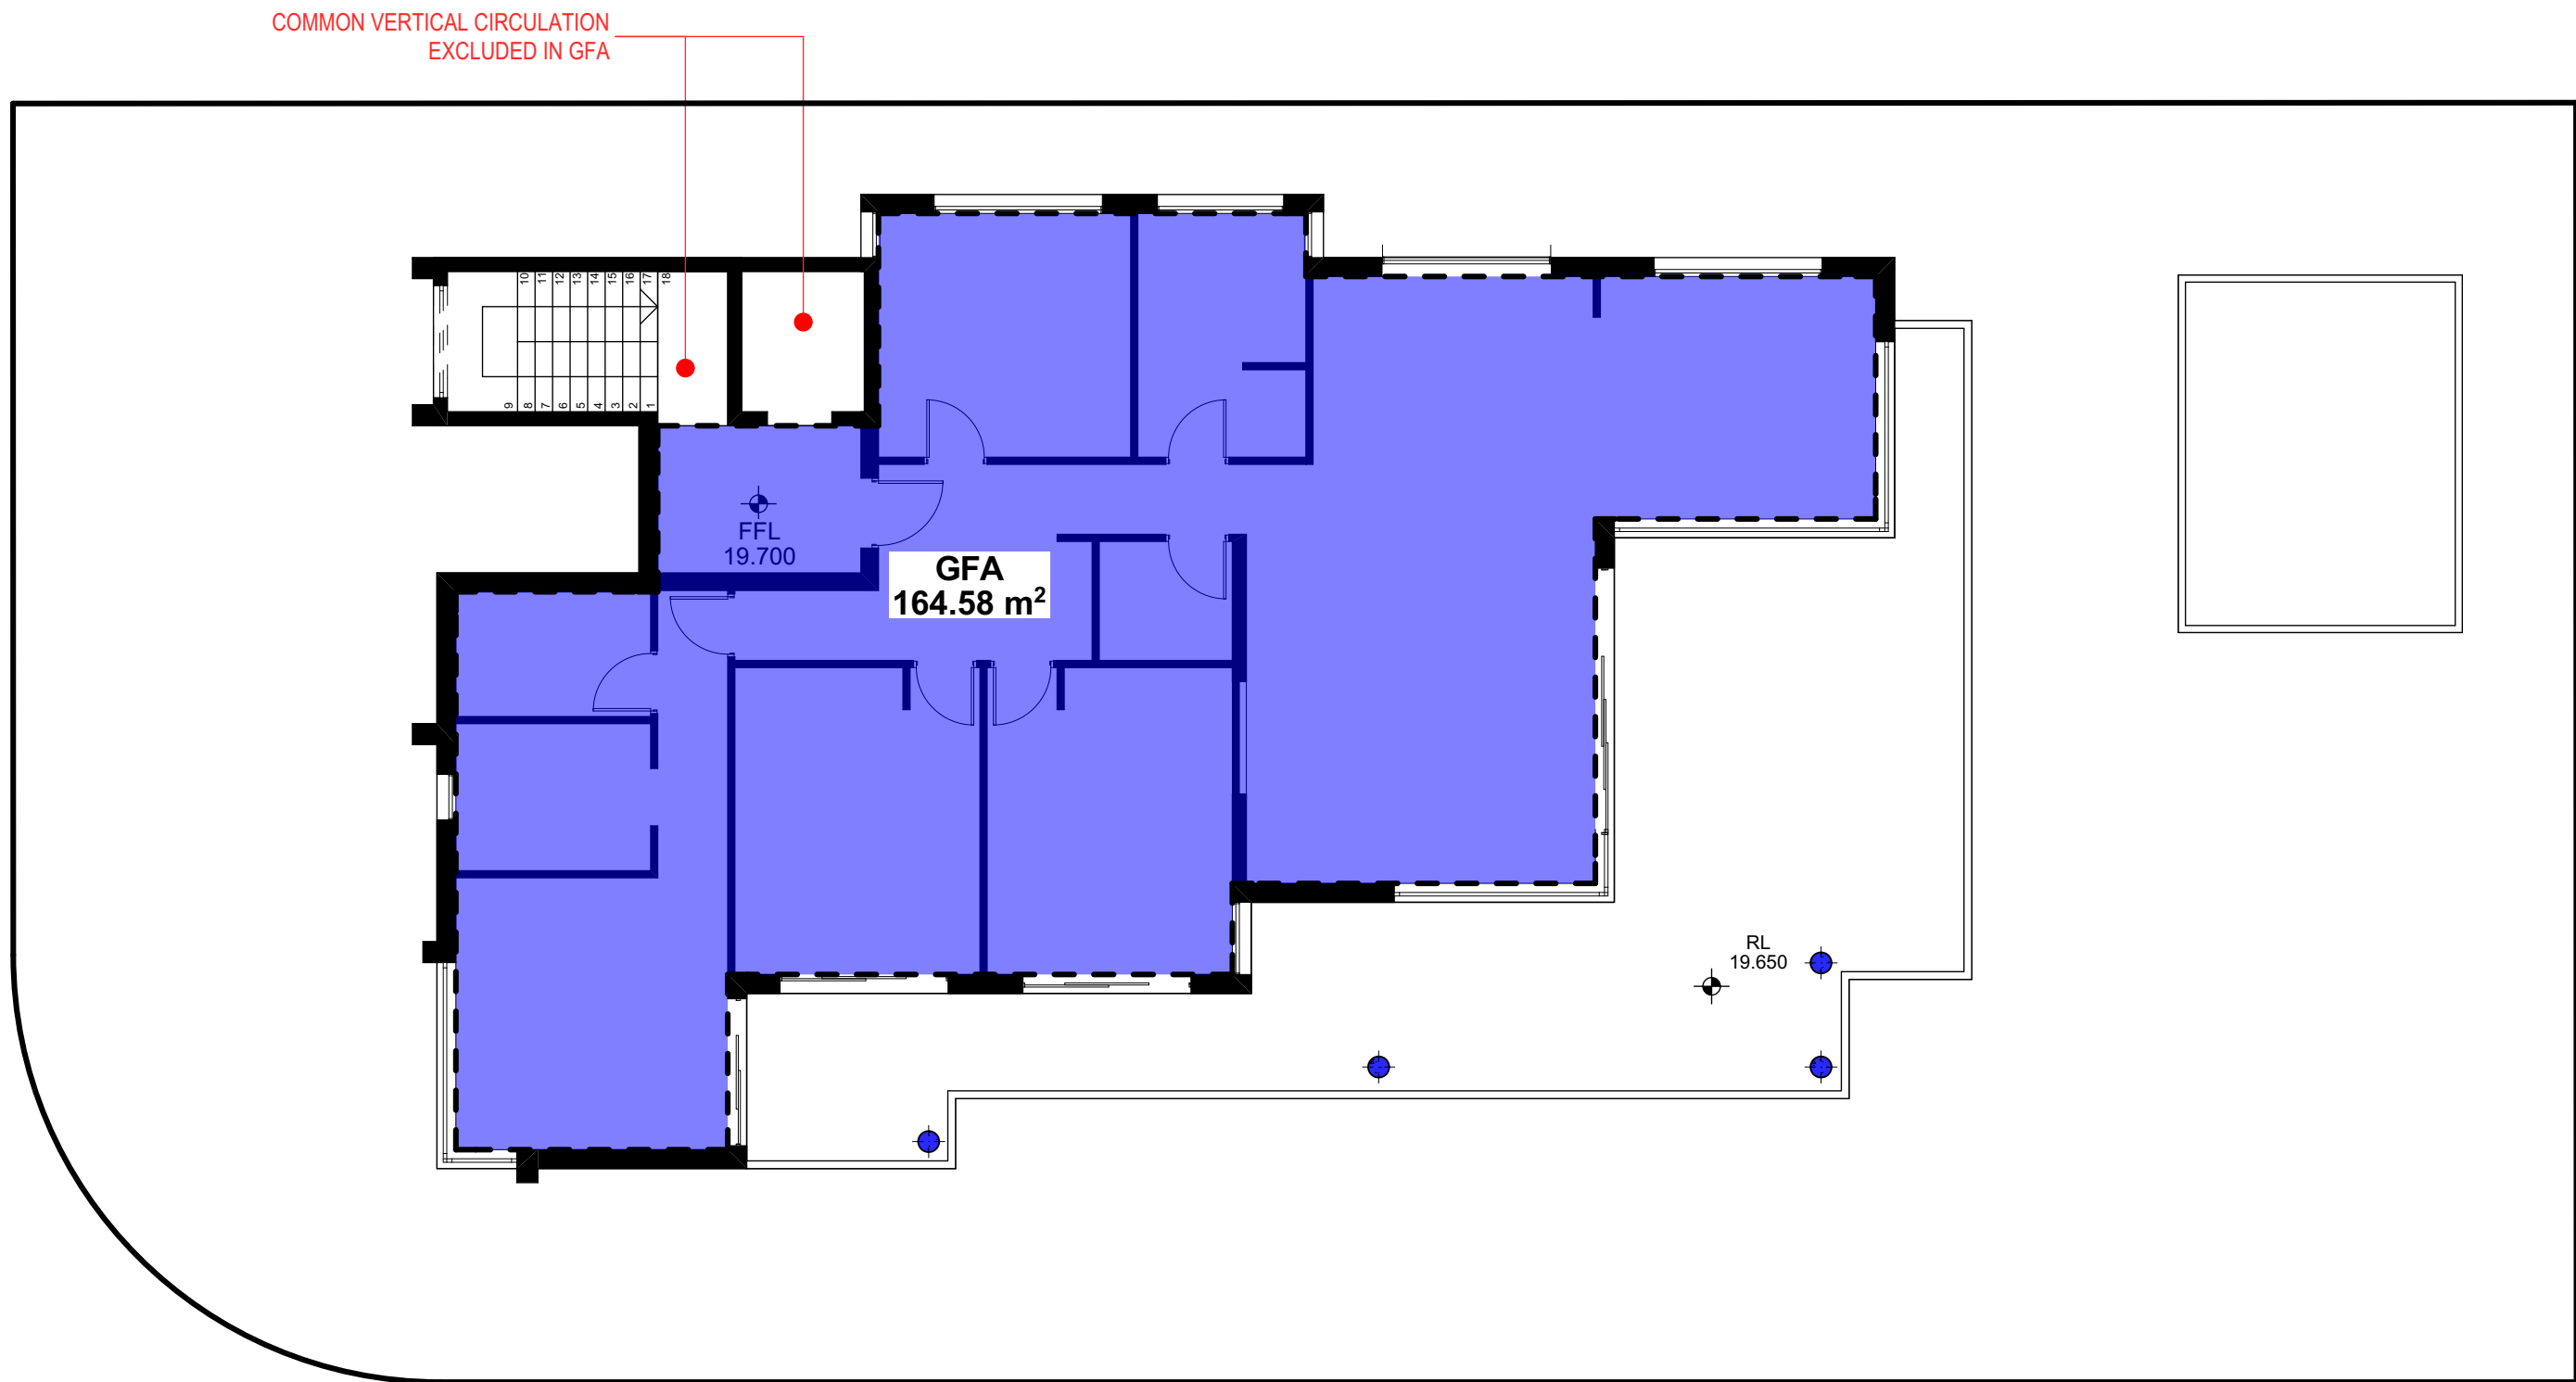

3 First Floor Plan - Area Calculation  
1:100

SITE AREA: 659.6m<sup>2</sup>


GROSS FLOOR AREA CALC.  
CONTROL: 0.5:1

GROUND FLOOR: 164.58m<sup>2</sup>  
FIRST FLOOR: 164.58m<sup>2</sup>

TOTAL GFA: 329.16m<sup>2</sup>

PROPOSED FSR: 0.50:1

LANDSCAPE AREA.  
TOTAL LANDSCAPED AREA: 162.64m<sup>2</sup>

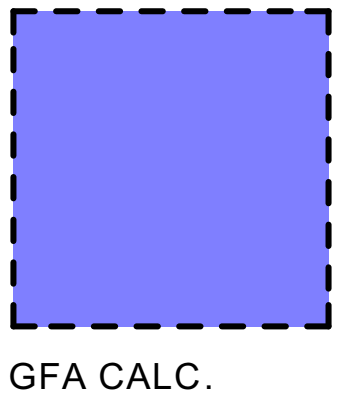

## DEVELOPMENT APPLICATION

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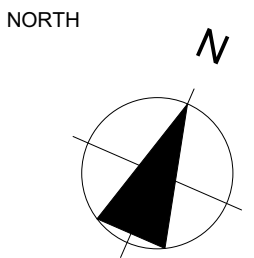
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DRAWING TITLE  
**Area Calculation Plan**  
DRAWING NO.  
**DA14**


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0 0.5 1.0 2.0m




**Proposed Dual Occupancy**  
**4 Wollongong Street, Shellharbour**

JOB No. 01820_DA	DATE 29/01/2021	DRAWN J.D	CHECKED A.M	SCALE As Shown on A1
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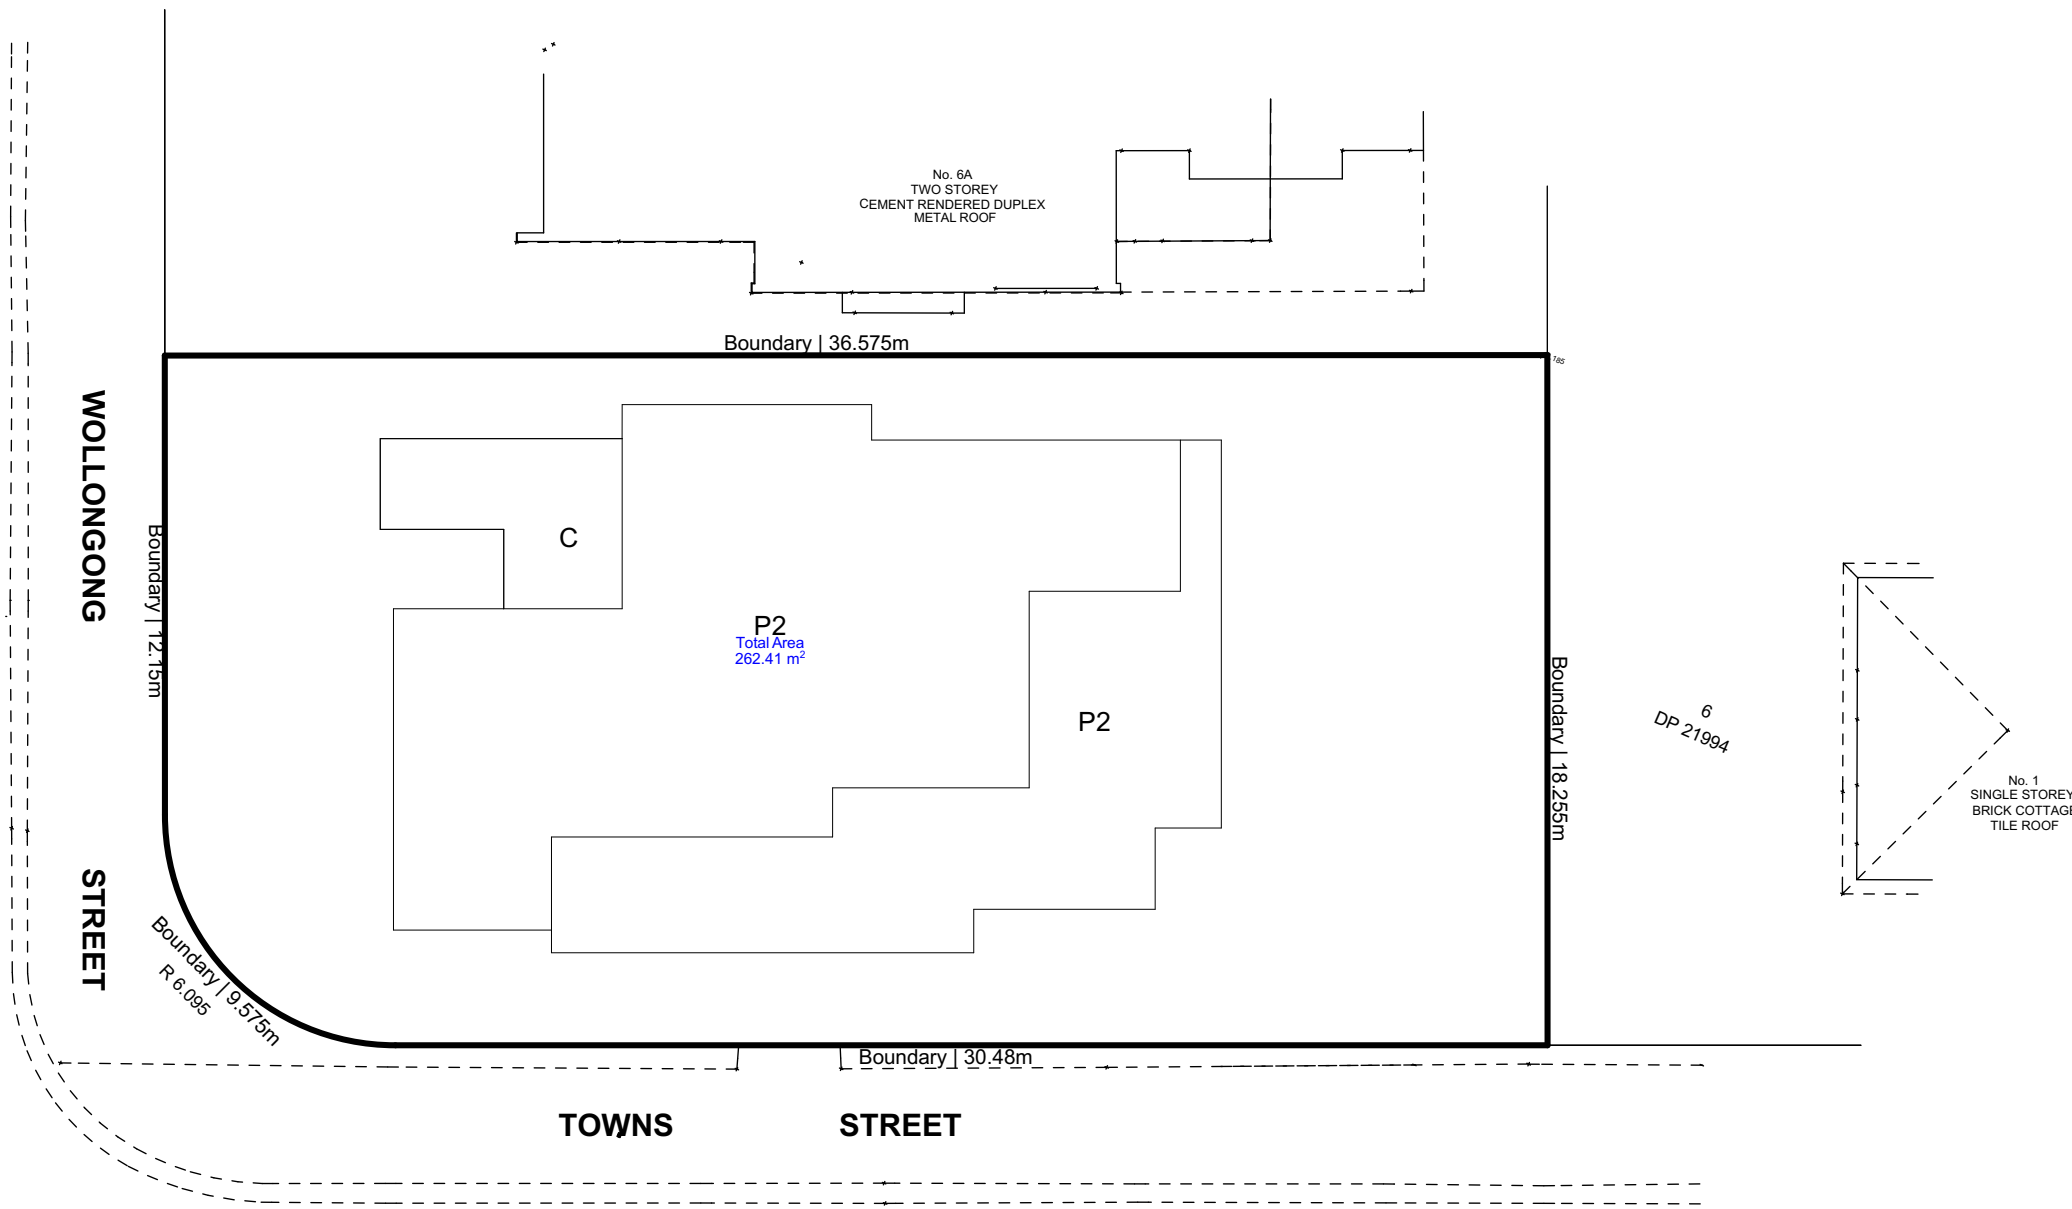


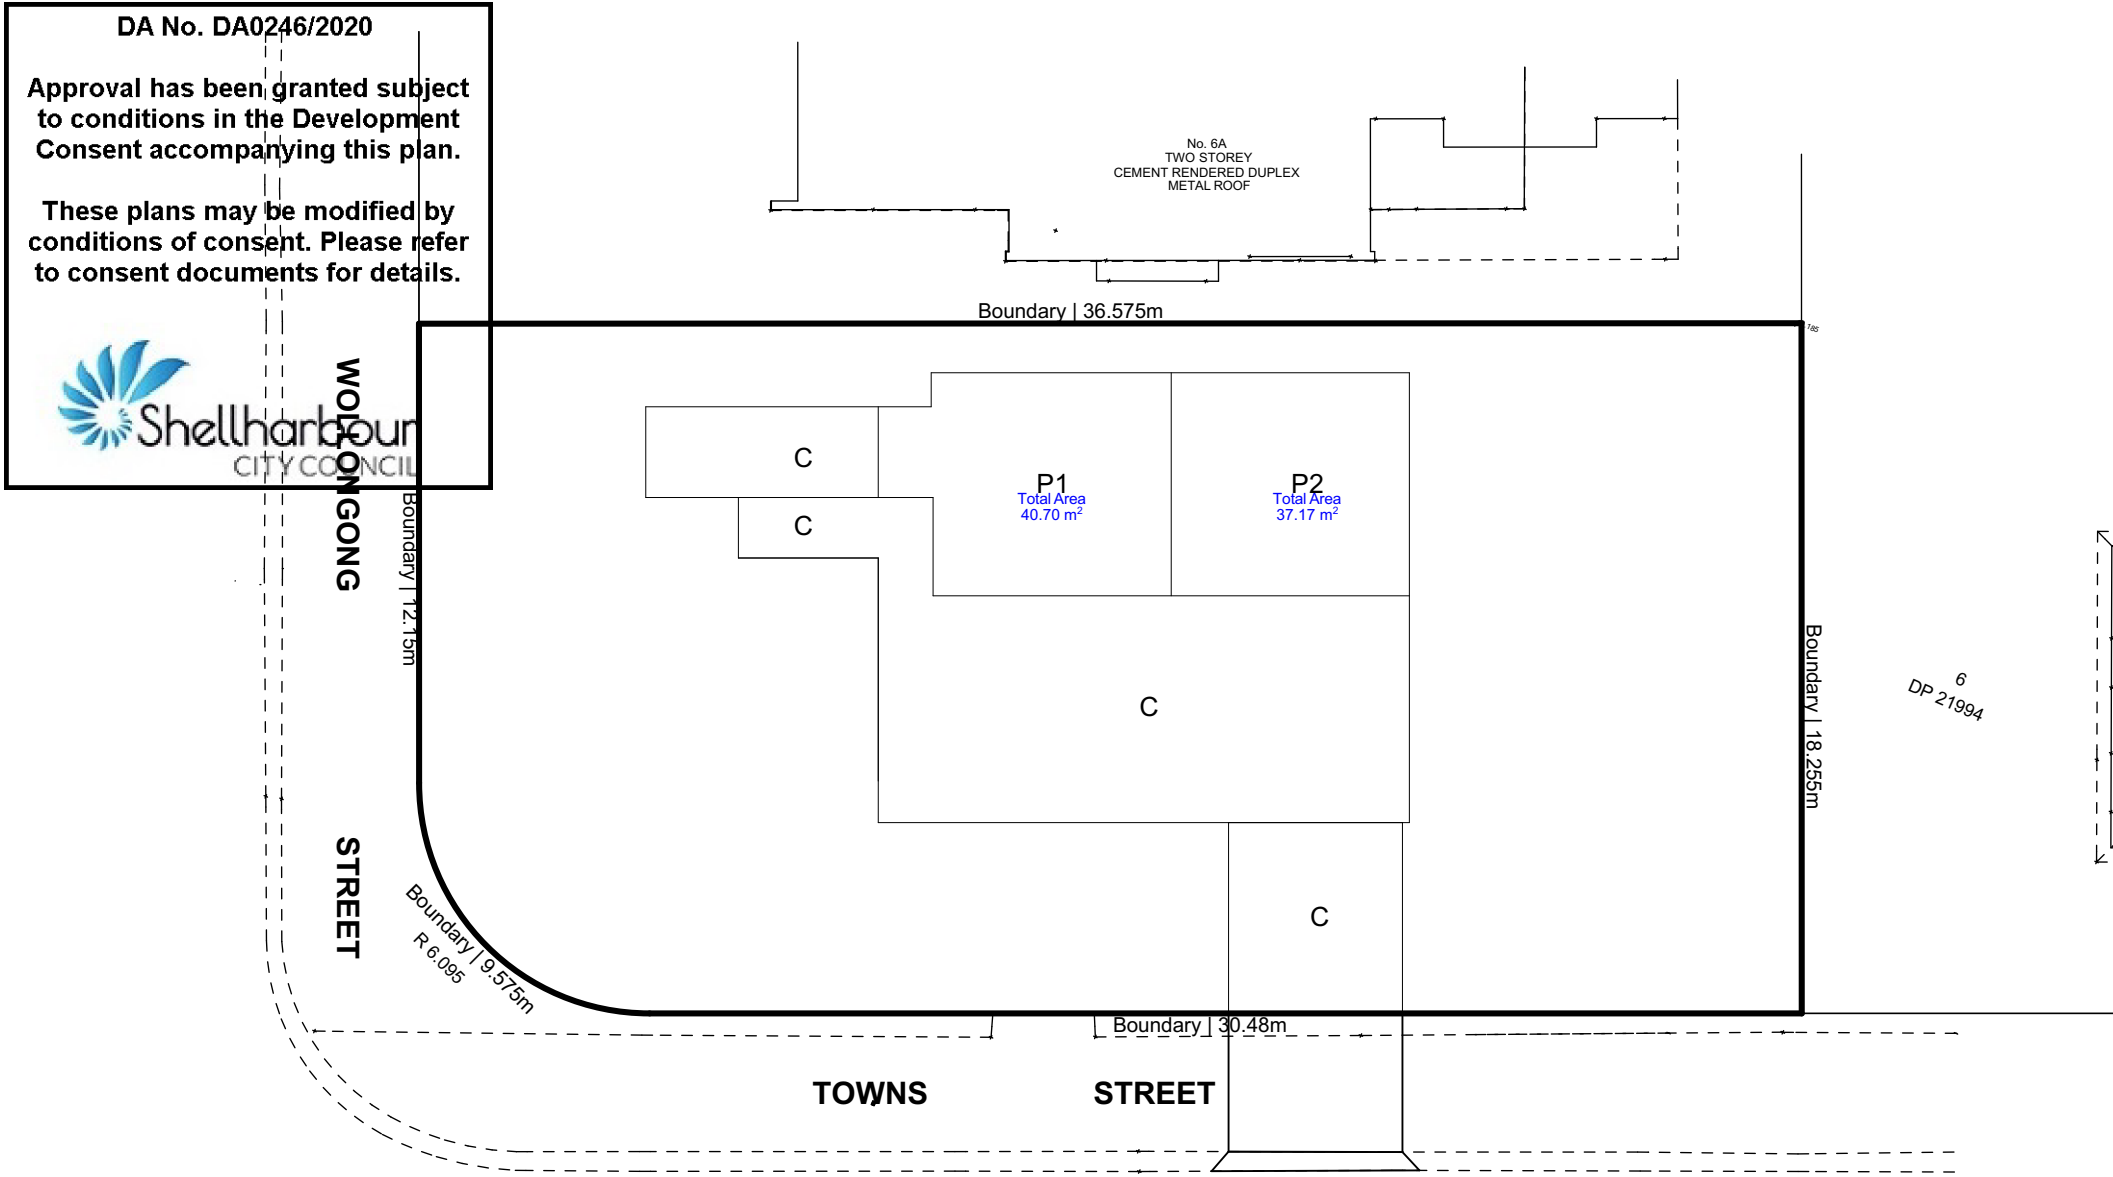

1 Basement Plan - Subdivison  
1:100

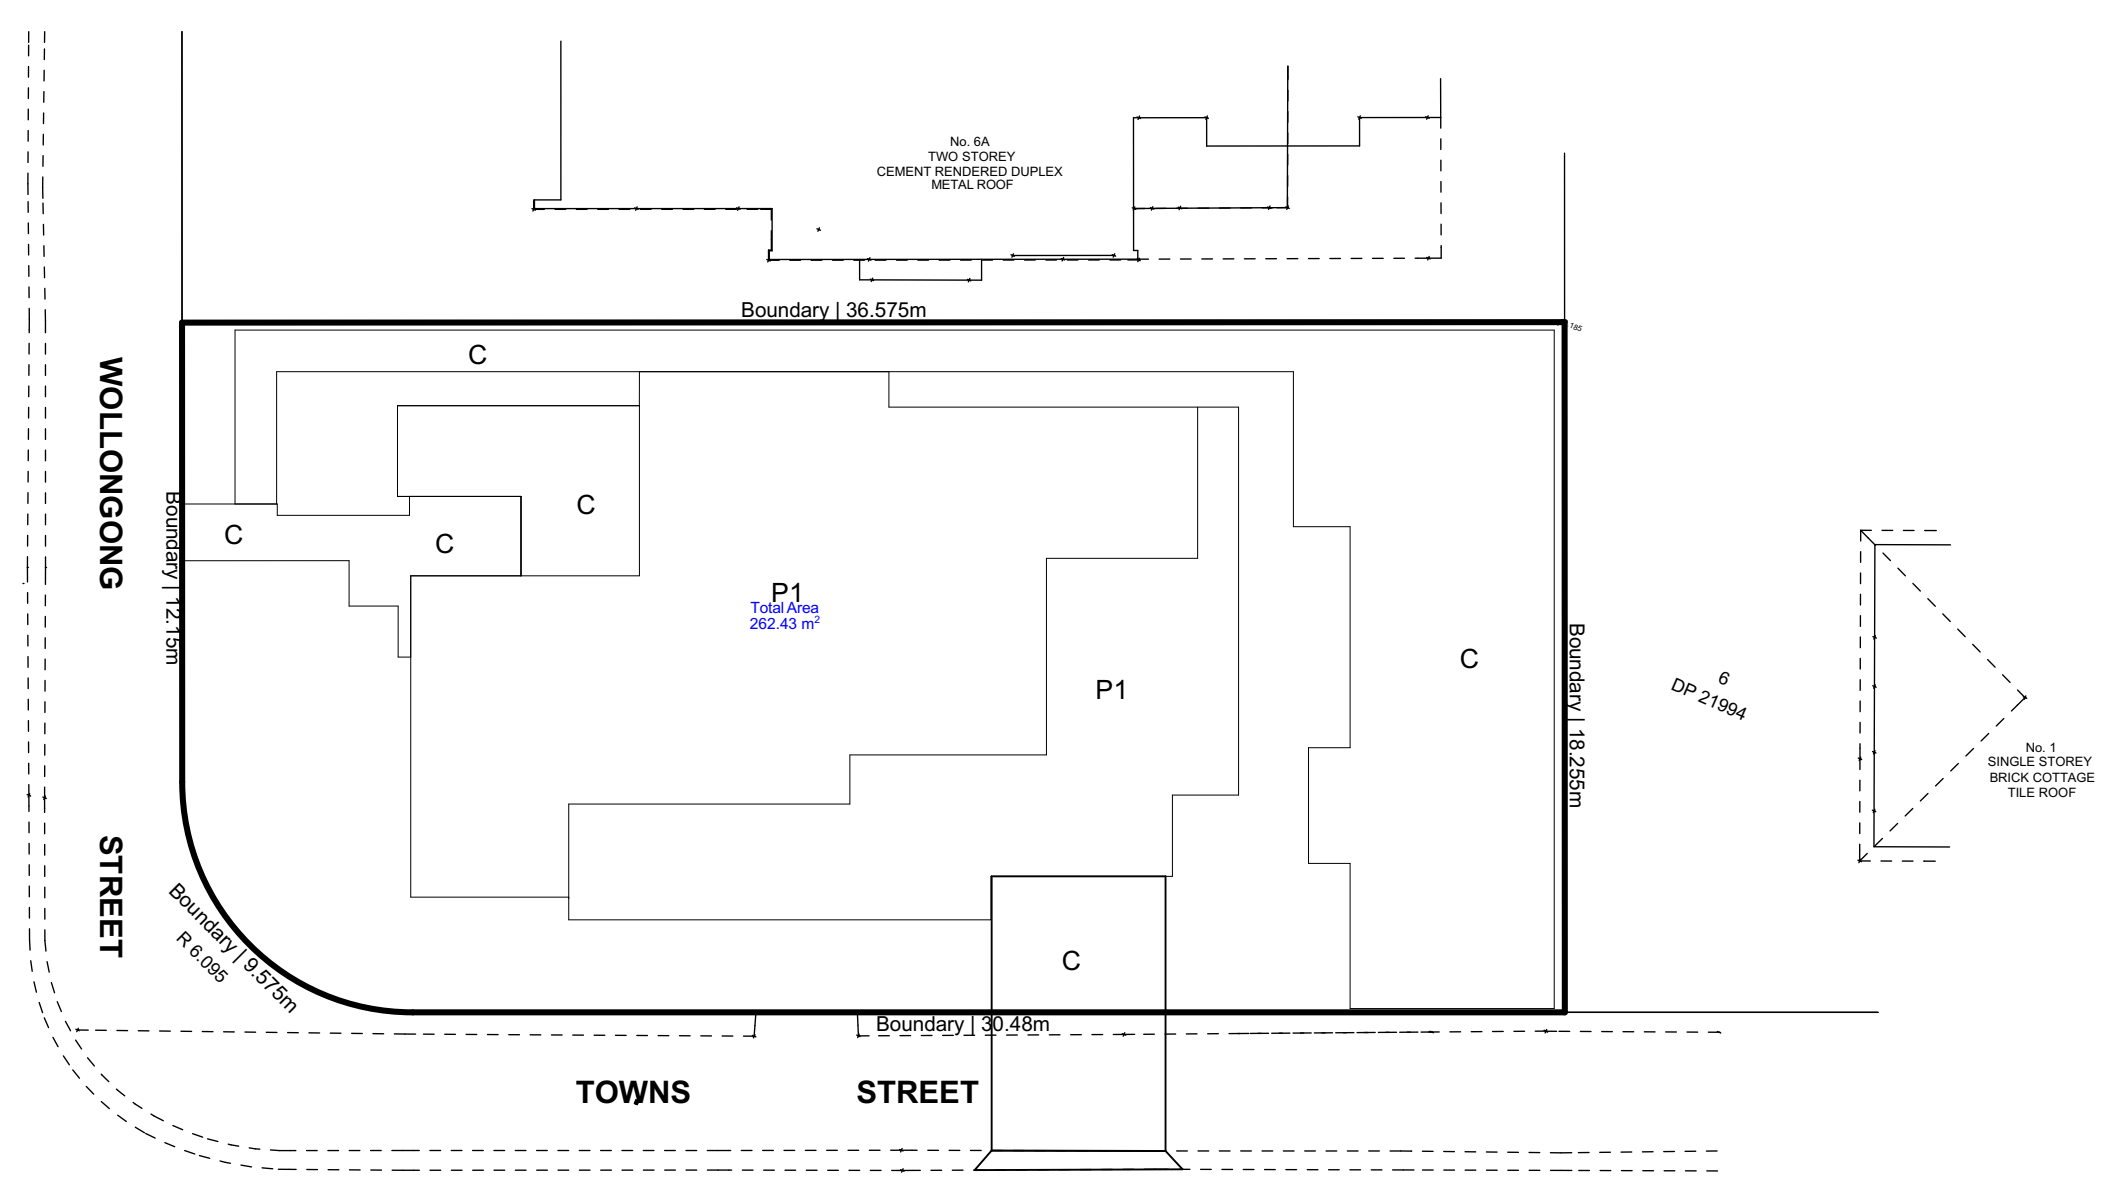

2 Ground Floor Plan - Subdivison  
1:100



3 First Floor Plan - Subdivison  
1:100

STRATA-SUBDIVISON CALCULATION

PROJECT: PROPOSED DUAL OCCUPANCY  
SITE: 4 WOLLONGONG STREET, SHELLHARBOUR  
LOT 1 | D.P 21994

SITE AREA: 659.6 m<sup>2</sup> (By Calc.)







NUMERICAL CONTROL:	PROPOSED
Unit 1 Subdvision Area (Inclu. Garage)	303.13 m <sup>2</sup>
Unit 2 Subdvision Area (Inclu. Garage)	299.60 m <sup>2</sup>

DEVELOPMENT APPLICATION

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DESIGN LINK AUSTRALIA PTY LTD a Suite 1, Level 5, 410 Church St, Parramatta, NSW 2150 p PO BOX 3085 North Strathfield NSW 2137 p 02 9744 3116 e info@design-link.com.au	<b>Proposed Plan of Subdivison</b> DRAWING NO <b>DA15</b>	DRAWING TITLE <b>Proposed Plan of Subdivison</b> DRAWING NO <b>DA15</b>	SCALE 1:100 @ A1 or 1:200 @ A3 0 0.5 1.0 2.0m	NORTH N	<b>Proposed Dual Occupancy</b> 4 Wollongong Street, Shellharbour	JOB No. 01820_DA	DATE 29/01/2021	DRAWN J.D	CHECKED A.M	SCALE As Shown on A1
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## LANDSCAPE GUIDELINES

1. **GENERAL**
- 1.1 The Contractor shall familiarize themselves with the site prior to tender.
- 1.2 The Contractor will be held responsible for any damage to utility services, pipes, building structures, paving surfaces, fencing, footways, kerbs, roads and existing planting material.
- 1.3 The site is to be left in a clean and tidy condition at the completion of works to the satisfaction of the Superintendent.
- 1.4 No work or materials are to be undertaken unless approval is first obtained from the Superintendent.
- 1.5 No substitute of material shall be made unless approval is given by the Superintendent.
- 1.6 The Contractor shall continuously maintain all areas of the Contract during the process of works specified.
2. **SITE PREPARATION**
- 2.1 Prepared sub-grade is to be free of stones larger than 100mm diameter, cement, rubbish and any other foreign material that could hinder plant growth.
3. **MASS PLANTED AREAS**
- 3.1 Once clear of weed growth, grass and debris, sub-grade should be cultivated to a minimum depth of 150mm incorporating 'Dynamic Lifer' or equivalent at the manufacturers recommended rates.
- 3.2 Weeds shall be controlled by a combination of chemical and hand removal techniques.
4. **PLANTING**
- 4.1 All plant material is to be hardened off, disease and insect free and true to species, type and variety. Plants are to be well grown but not root bound and shall comply with Natpex: "Guide to Purchasing Landscape Trees".
- 4.2 All plants are to be removed once their containers prior to planting and any site disturbance to the root system as possible.
- 4.3 Planting shall not be carried out in dry soil or extreme weather conditions.
- 4.4 Plants shall be planted at the same depth as the plants were in the containers and allow for a shallow saucer of soil to be formed around the plant to aid the growth of the plants.
- 4.5 All plant material should be watered thoroughly immediately after planting.
- 4.6 The Contractor shall be responsible for the failure of plants during construction, except for acts of vandalism.
- 4.7 Labels shall be removed directly from the plants.
5. **STAKING**
- 5.1 Ties should be firmly attached to the stakes, in a way to avoid damage to the stem while allowing a small degree of movement.
6. **Turf AREAS**
- 6.1 Turf areas should be cultivated before turling by turling or harrowing.
- 6.2 At the completion of turling the whole area shall be thoroughly soaked and kept moist till the completion of landscape works.
7. **MULCH**
- 7.1 Mulch for all general mass planted beds shall be 'Doughstrum' mulch as supplied by A.N.L. or similar.
- 7.2 Mulch for retention areas shall be 20mm Nepean River Gravel or similar kept moist to a minimum 50mm depth.
8. **SOIL MIXES**
- 8.1 Soil mix for all planted areas shall be 3 parts soil to 1 part 'Organic Garden Mix' as supplied by A.N.L. or equivalent.
- 8.2 Soil mix for street tree planting shall be 1 part site soil to 1 part 'Organic Garden Mix' as supplied by A.N.L. or equivalent.

## 1 TREE PROTECTION GUIDELINES
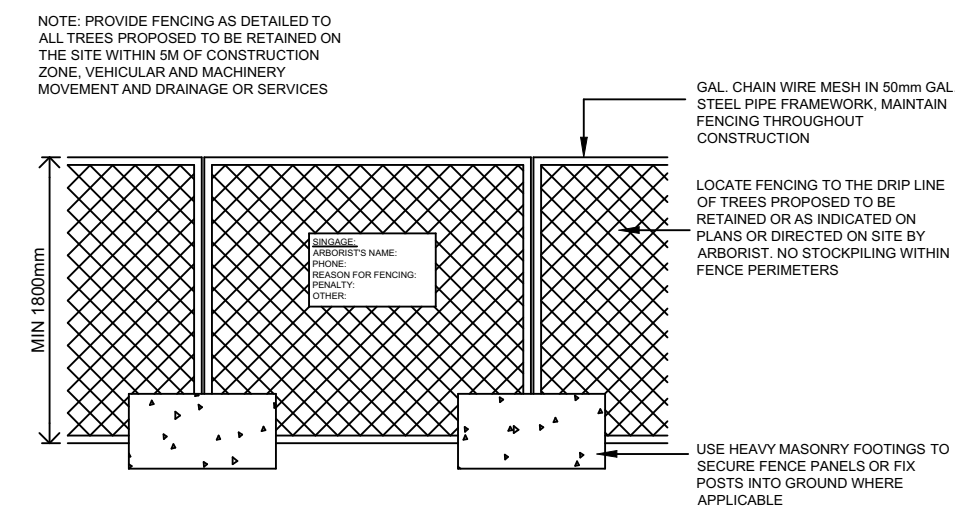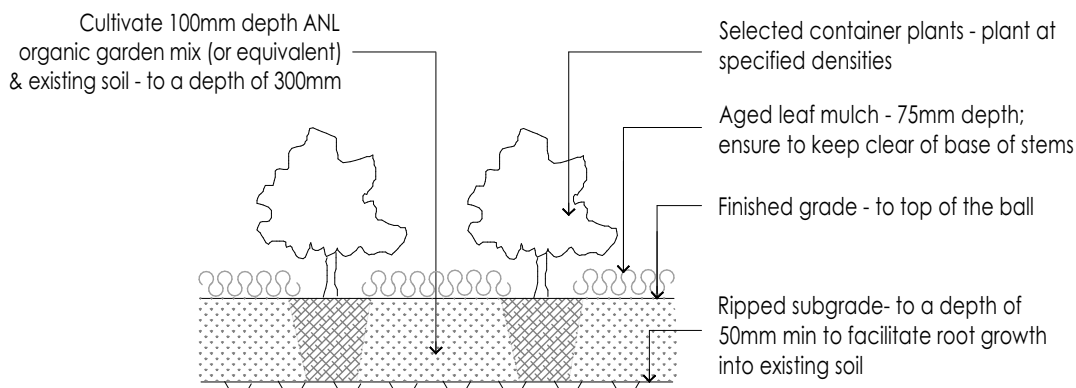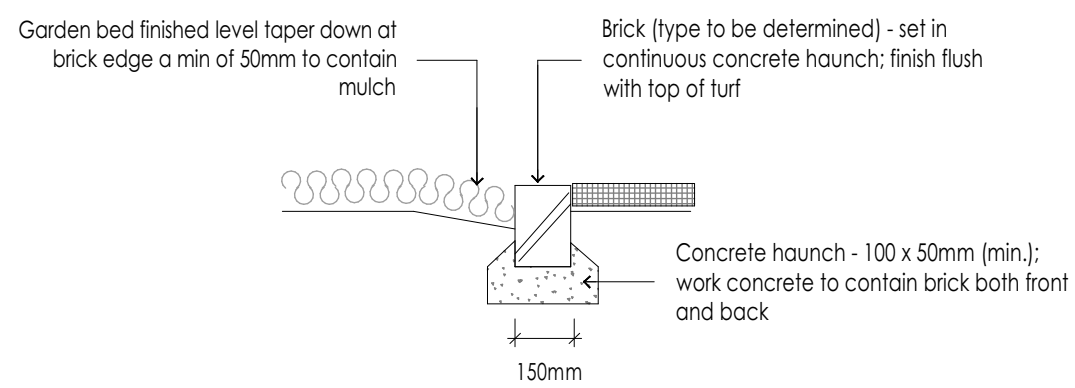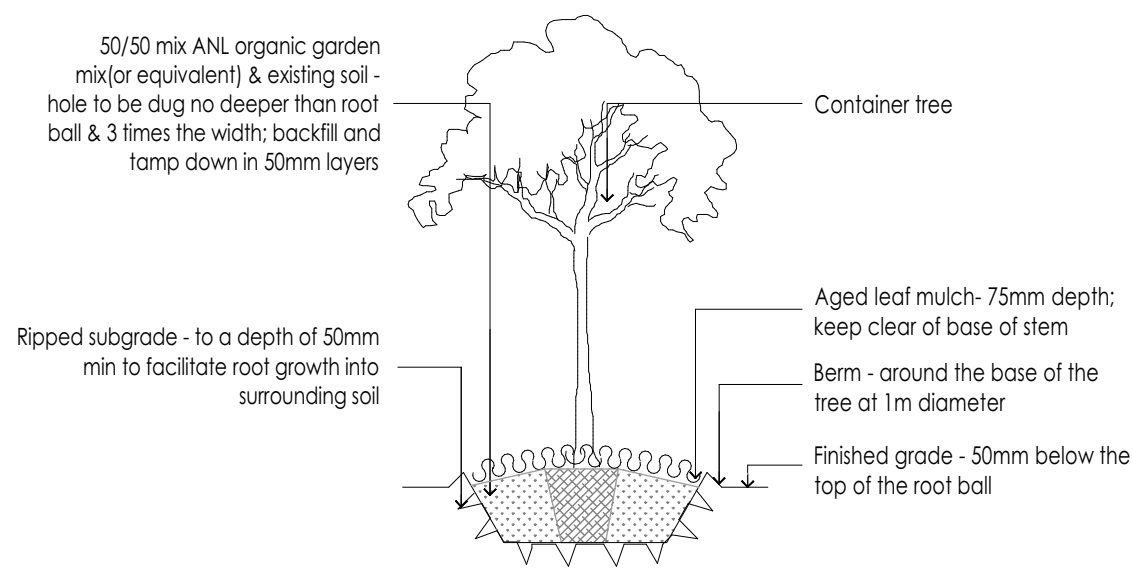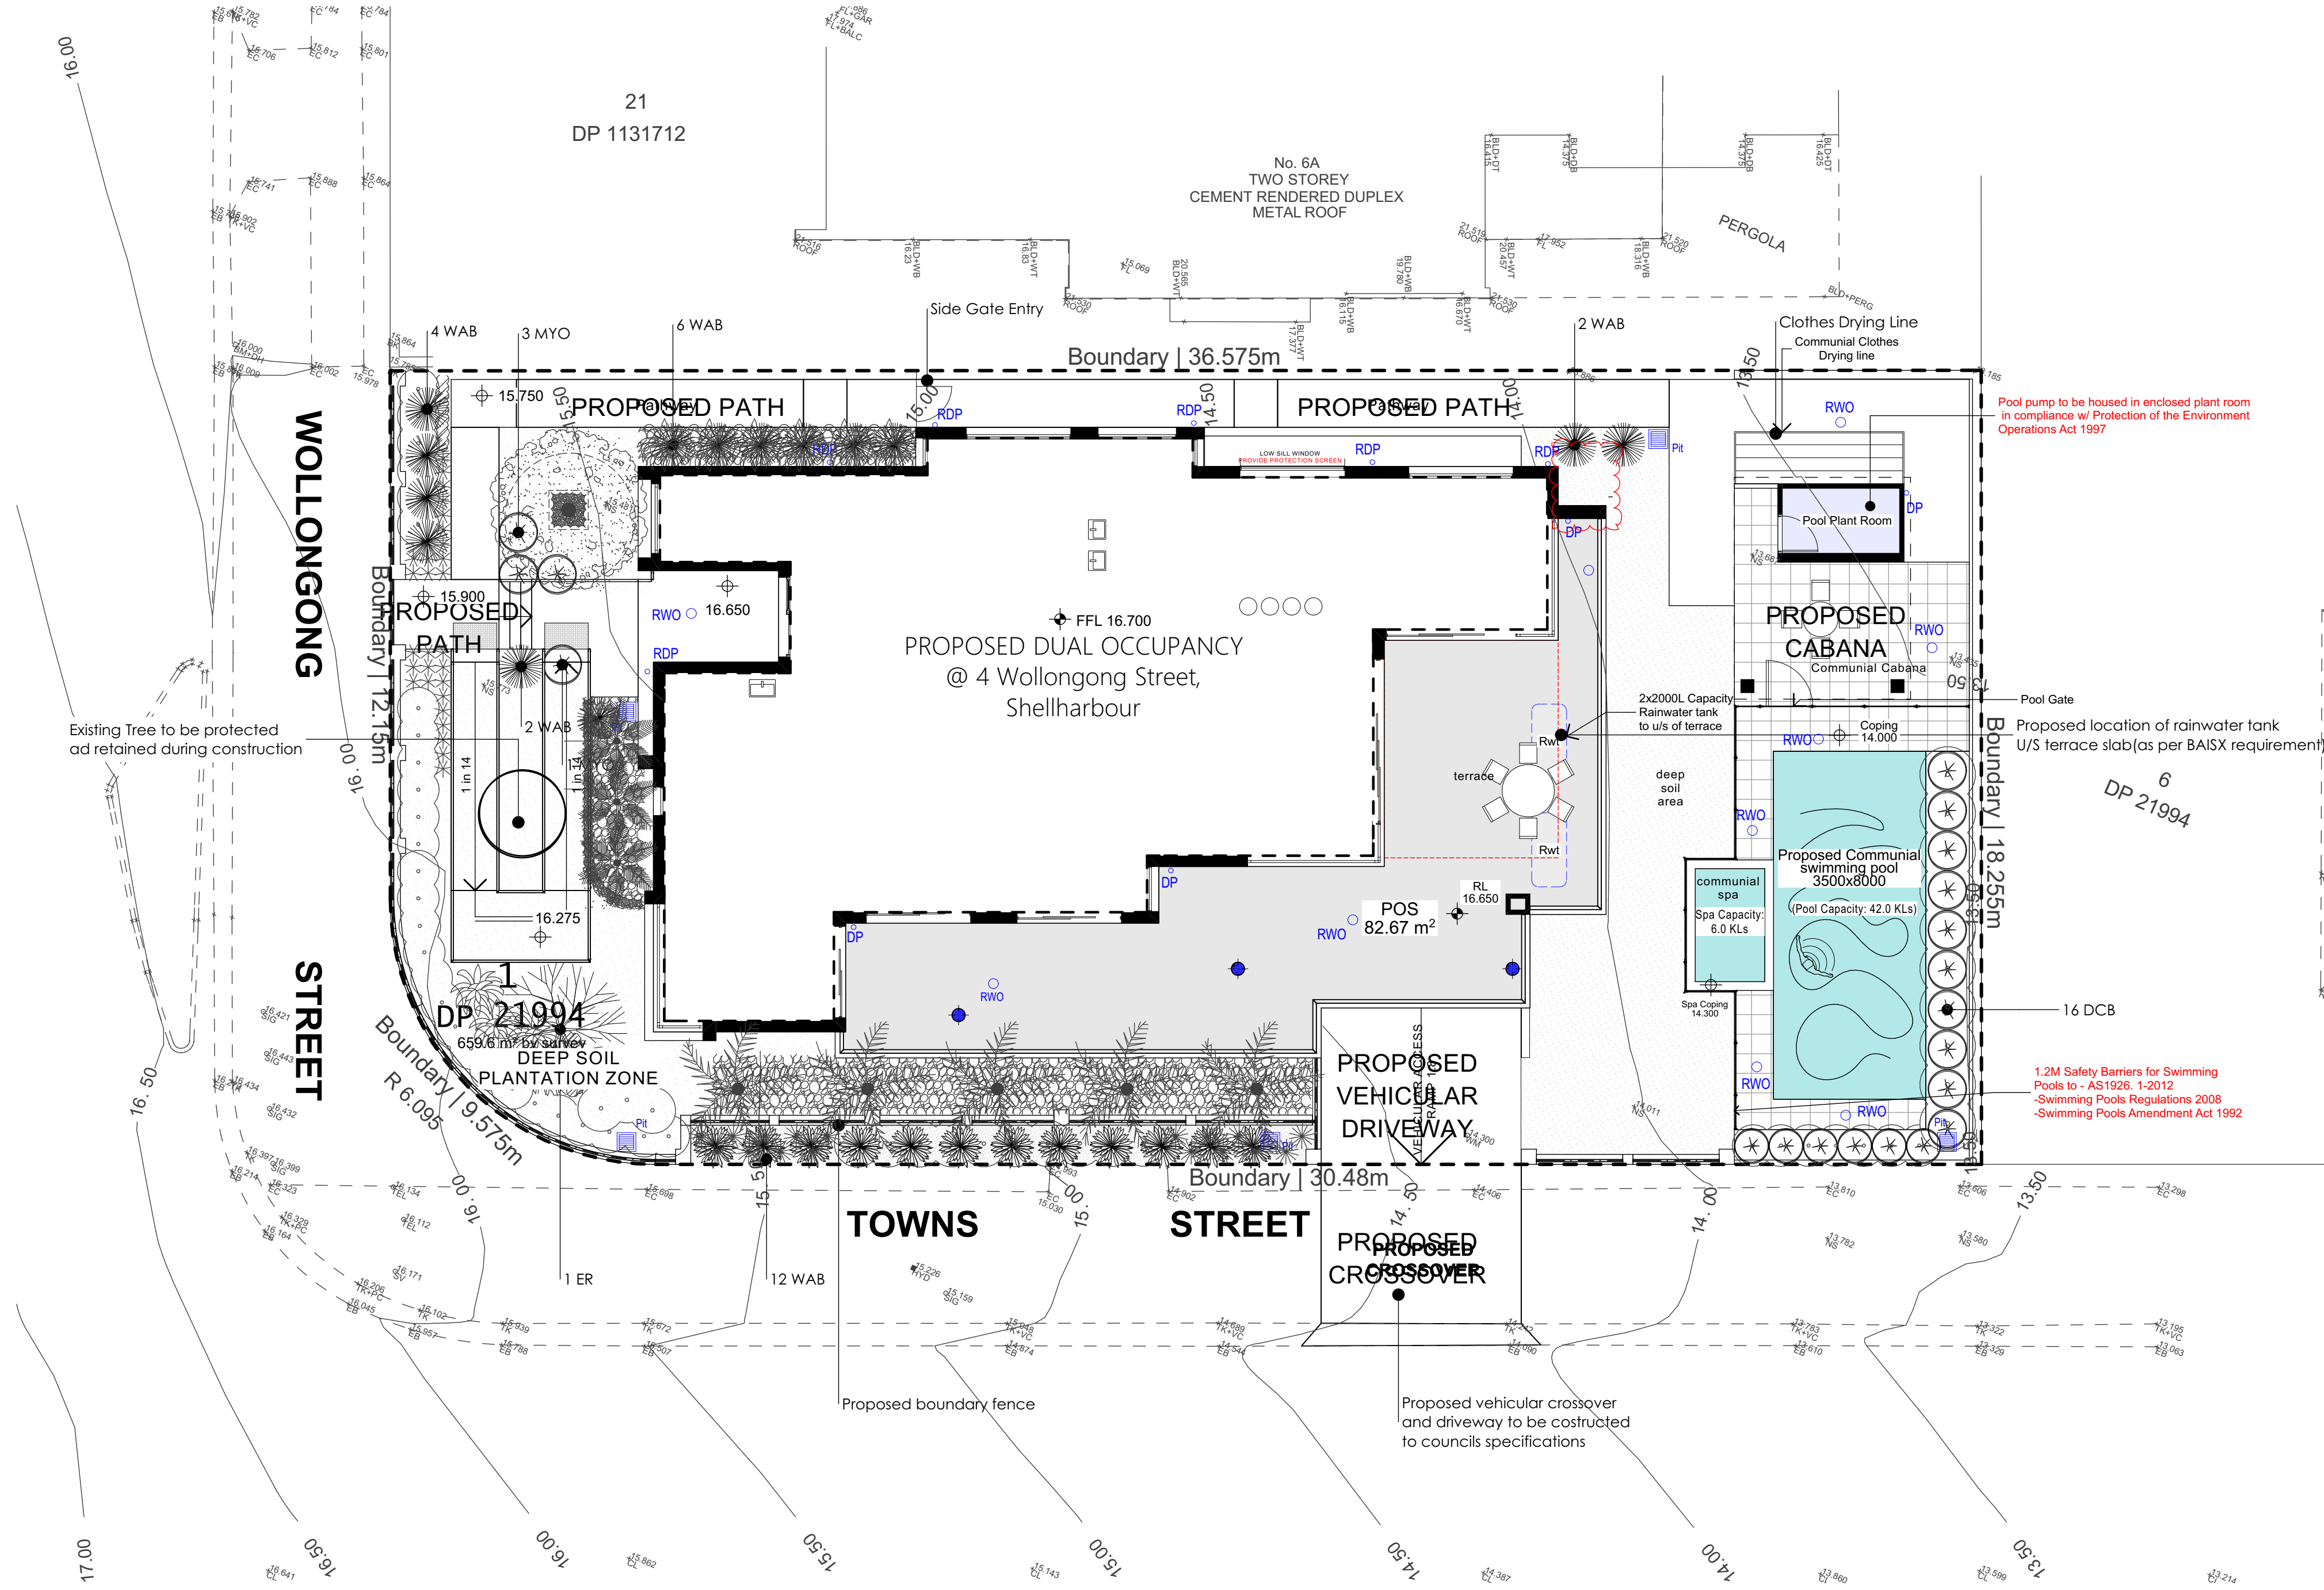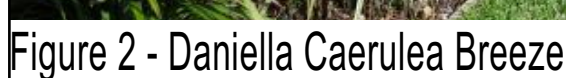
### 1. WORK NEAR TREES

**GENERAL:** All trees and trees which are to remain undisturbed are indicated on the drawings and shall be adequately protected for the duration of the contract as specified by this policy. Any variation from this specification or requires regarding the protection/health of the trees to be retained must be referred to Council's Landscape Officer or Tree Preservation Officer for approval and advice.

**UNDESIRABLE TREES:** Trees that are not to be removed or topped shall be clearly marked and protected in writing by the Superintendent. All tree protection works shall be carried out before excavation, grading and site works commence.

### 2. PROTECTION

Protect trees specified or shown to be threatened from damage by ground works. Take necessary precautions, including the following:

1. Method: Fence off the root zones of all existing trees to be retained in accordance with the Tree Protection Fencing Detail. Protect trees to be retained in place by installing a fence around the root zone of the tree. The fence shall be installed in place at least 2 metres from the trunk or at the edge of the drip line, whichever possible. A layer of organic mulch 100mm thick shall be placed over the protected area where the ground surface is not already covered. Where building works are required within the root zone of existing trees these works must be supervised by a qualified Arborist.
2. Harmful materials: Do not store or otherwise place bulk materials and harmful materials around or near trees. Do not place spoil from excavations or material from the site of excavations in or near trees.
3. Excavations: Prevent excavation of trees. Do not attach signs, dig lines or the like to trees.
4. Substances: Prevent the deposit of any material or substance on or near trees. Do not attach signs, dig lines or the like to trees.
5. Roots: Do not cut tree roots exceeding 50mm diameter unless undertaken by a qualified Arborist.

# PROPOSED DUAL OCCUPANCY

## 4 Wollongong Street, Shellharbour


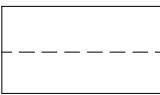
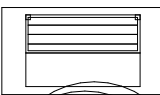
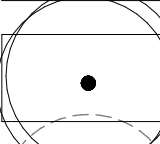
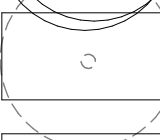
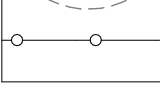
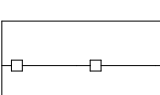

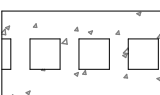
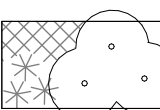
JOB No. 01820_DA	DATE JUNE 2020	DRAWN H.F	CHECKED A.M	SCALE As Shown on A1
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**DESIGN LINK AUSTRALIA PTY LTD**  
 a Suite 1, Level 5, 410 Church St, Parramatta, NSW 2150  
 p PO BOX 3085 North Strathfield NSW 2137  
 p 02 9744 3116 e info@design-link.com.au

ISSUE	DESCRIPTION	DATE
1.	ISSUE FOR DEVELOPMENT APPLICATION	05/0620

## LEGEND

	<p>New Turf</p> <p>Excavate / grade all areas to be turfed to 120mm below required finished levels. Do not excavate within 1500mm of the trunk of any existing tree to be retained. Ensure that all surface water runoff is directed towards the inlet pits, kerbs etc., and away from buildings. Ensure that no pooling or ponding will occur. Further rip the subgrade to 150mm. Install 100mm depth of imported turf underlay. Just prior to spreading the turf, spread 'Shirley's No.17' lawn fertiliser over the underlay at the recommended rate. Lay 'Sir Walter Buffalo' turf rolls closely butted. Fill any small gaps with topsoil. Water thoroughly.</p>
	<p>Brick garden edging (refer to detail)</p> <p>Lay a single course of paving bricks in a mortar haunch (200mm wide and 100mm deep). The edges are to be laid in even curves and straight lines as shown on the plan. Edge is to finish flush with the adjacent turf and garden levels.</p>
	Proposed clothes drying line
	Existing trees or shrubs to be protected and retained during construction
	Existing trees or shrubs to be removed (pending Council approval)
	Existing boundary fencing to be retained or replaced (where required)
	New 1.8m high dividing fence between rear private open space
	Proposed 900mm high low boundary fence to front setback area (to be selected by owner)
	Proposed pre-cast concrete stepping pads in mulched garden area (to be selected by owner)
	<p>Landscaped areas</p> <p>Excavate all Planting Areas to a depth of 150mm below finished levels. Cultivate subgrade a further 150mm. Supply &amp; install 100mm of soil mix that consists of 50% Site Top Soil (if suitable) with 50% ANL Organic Garden mix (or equivalent). Install 75mm depth of selected mulch.</p>

Note:  
Maintenance:  
All landscape works are to be maintained for a period of twelve months from the date of practical completion. This includes all watering, weeding, spraying and re-mulching necessary to achieve vigorous growth. Any defects which arise during this period are to be rectified immediately. Any plants or areas of turf which fail during this period are to be replaced at no additional cost.








Approval has been granted subject to conditions in the Development Consent accompanying this plan.

These plans may be modified by conditions of consent. Please refer to consent documents for details.

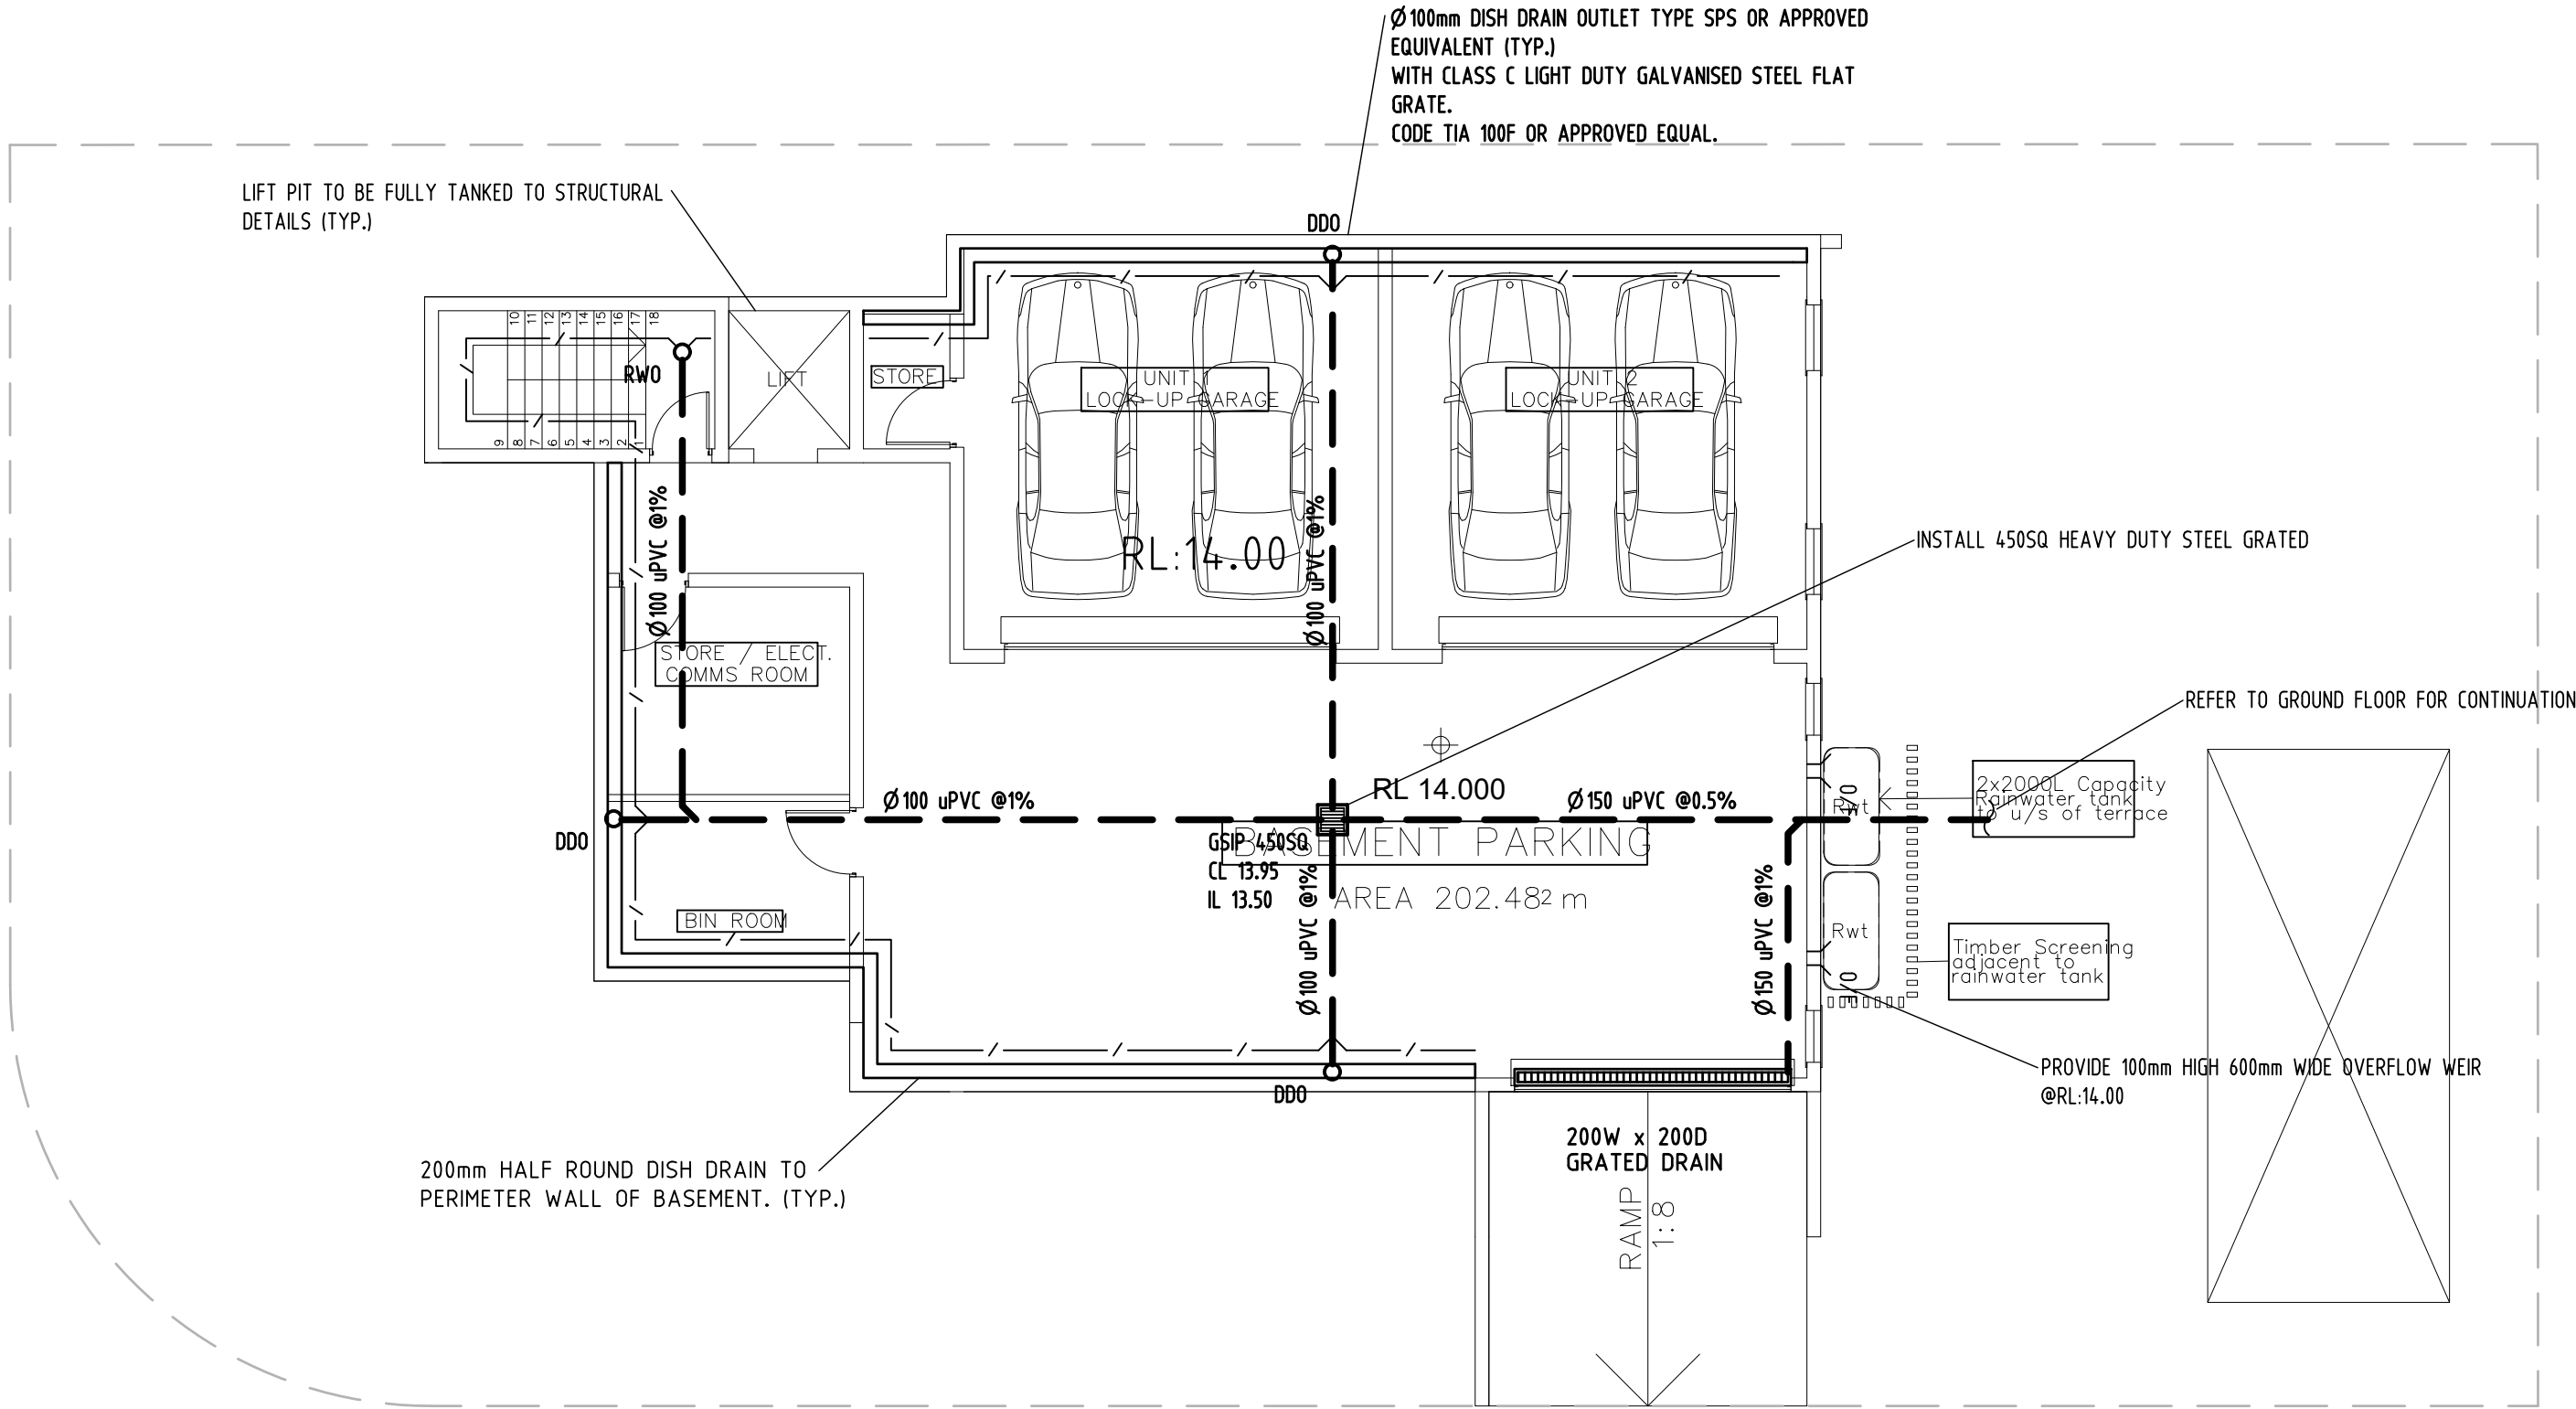

**BASEMENT FLOOR PLAN**

SCALE 1:100 (A1)

SCALE 1:200 (A3)

A	05.06.2020	CONCEPT, ISSUED FOR DA APPROVAL		TA
REV.	DATE	AMENDMENT DESCRIPTION		DRAWN
<div><div></div><div><p>TAA CONSULTING ENGINEERS</p><p>CONSULTING CIVIL &amp; STRUCTURAL ENGINEERS</p><p>201/25 FALCON STREET, CROWS NEST NSW 2065 Ph: 0411778799 TAAENGINEERS@GMAIL.COM</p></div></div>				
PROPOSED RESIDENTIAL DEVELOPMENT AT: 4 WOLLONGONG STREET, SHELLHARBOUR, NSW 2529				
BASEMENT FLOOR DRAINAGE PLAN				
DRAWN	CHECKED	SCALE	DATUM	DRAWING No.
TA	TONY ANAL - Civil & Structural Engineer (B.E. Civil (L3040) (MEANet):1080229	AS SHOWN	AHD	H399 - S1/6
				REV.
				A



Approval has been granted subject to conditions in the Development Consent accompanying this plan.

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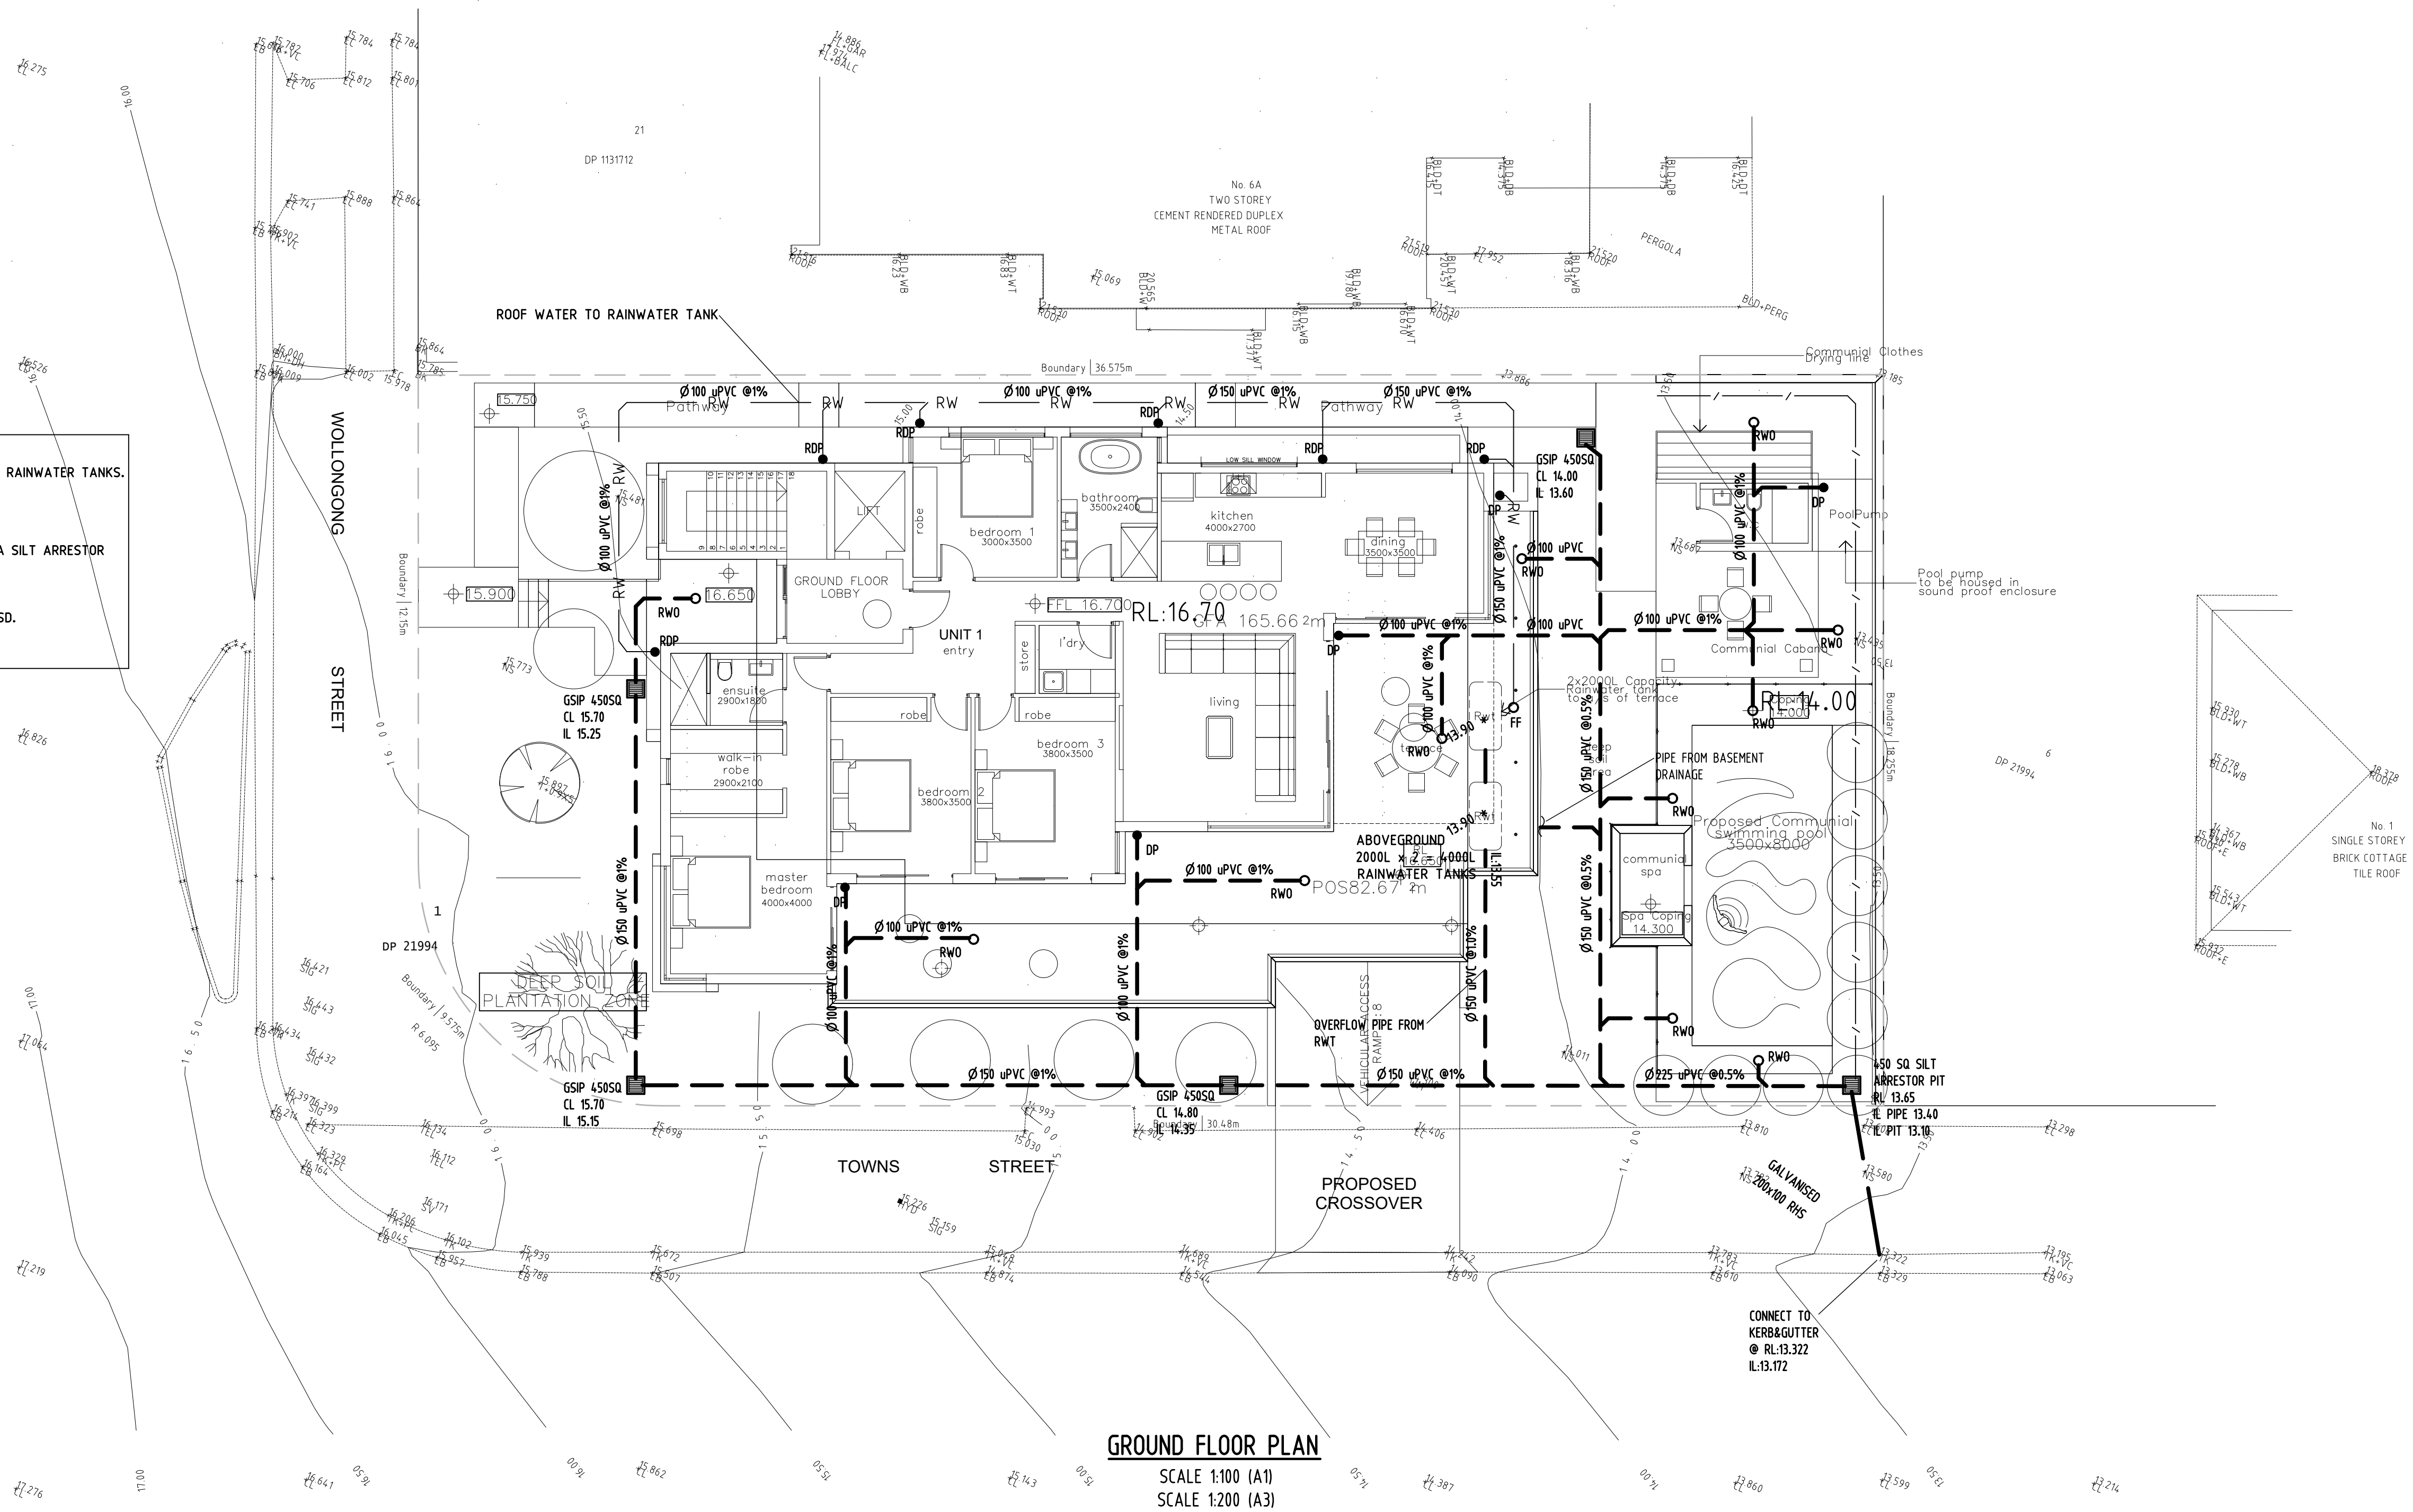


### SITE SPECIFIC NOTES:

ALL ROOFWATER TO DRAIN BY GRAVITY TO UNDERGROUND RAINWATER TANKS. OVERFLOW FROM RAINWATER TANKS TO DRAIN TO STREET KERB GUTTER BY GRAVITY VIA SILT ARRESTOR PIT.

SURFACE WATER TO DRAIN DIRECTLY TO KERB GUTTER VIA SILT ARRESTOR PIT. DO NOT CONNECT TO RAINWATER TANKS.

TOTAL 4000L RAINWATER VOLUME PROVIDED IN LIEU OF OSD.



A	05.06.2020	CONCEPT, ISSUED FOR DA APPROVAL	TA	
REV.	DATE	AMENDMENT DESCRIPTION	DRAWN	
<div><div></div><div><p>TAA CONSULTING ENGINEERS CONSULTING CIVIL &amp; STRUCTURAL ENGINEERS 201/25 FALCON STREET, CROWS NEST NSW 2065 Ph. 0411778799 TAAENGINEERS@GMAIL.COM</p></div></div>				
PROPOSED RESIDENTIAL DEVELOPMENT AT: 4 WOLLONGONG STREET, SHELLHARBOUR, NSW 2529				
GROUND FLOOR DRAINAGE PLAN				
DRAWN	CHECKED	SCALE	DATUM	DRAWING No.
TA	TONY ANAL - CIVIL & Structural Engineer (B.E. Civil (L3090) (MEANUM)1080229)	AS SHOWN	AHD	H399 - S2/6
				REV.
				A








DA No. DA0246/2020


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Shellharbour  
CITY COUNCIL




ROOF PLAN  
SCALE 1:100 (A1)  
SCALE 1:200 (A3)

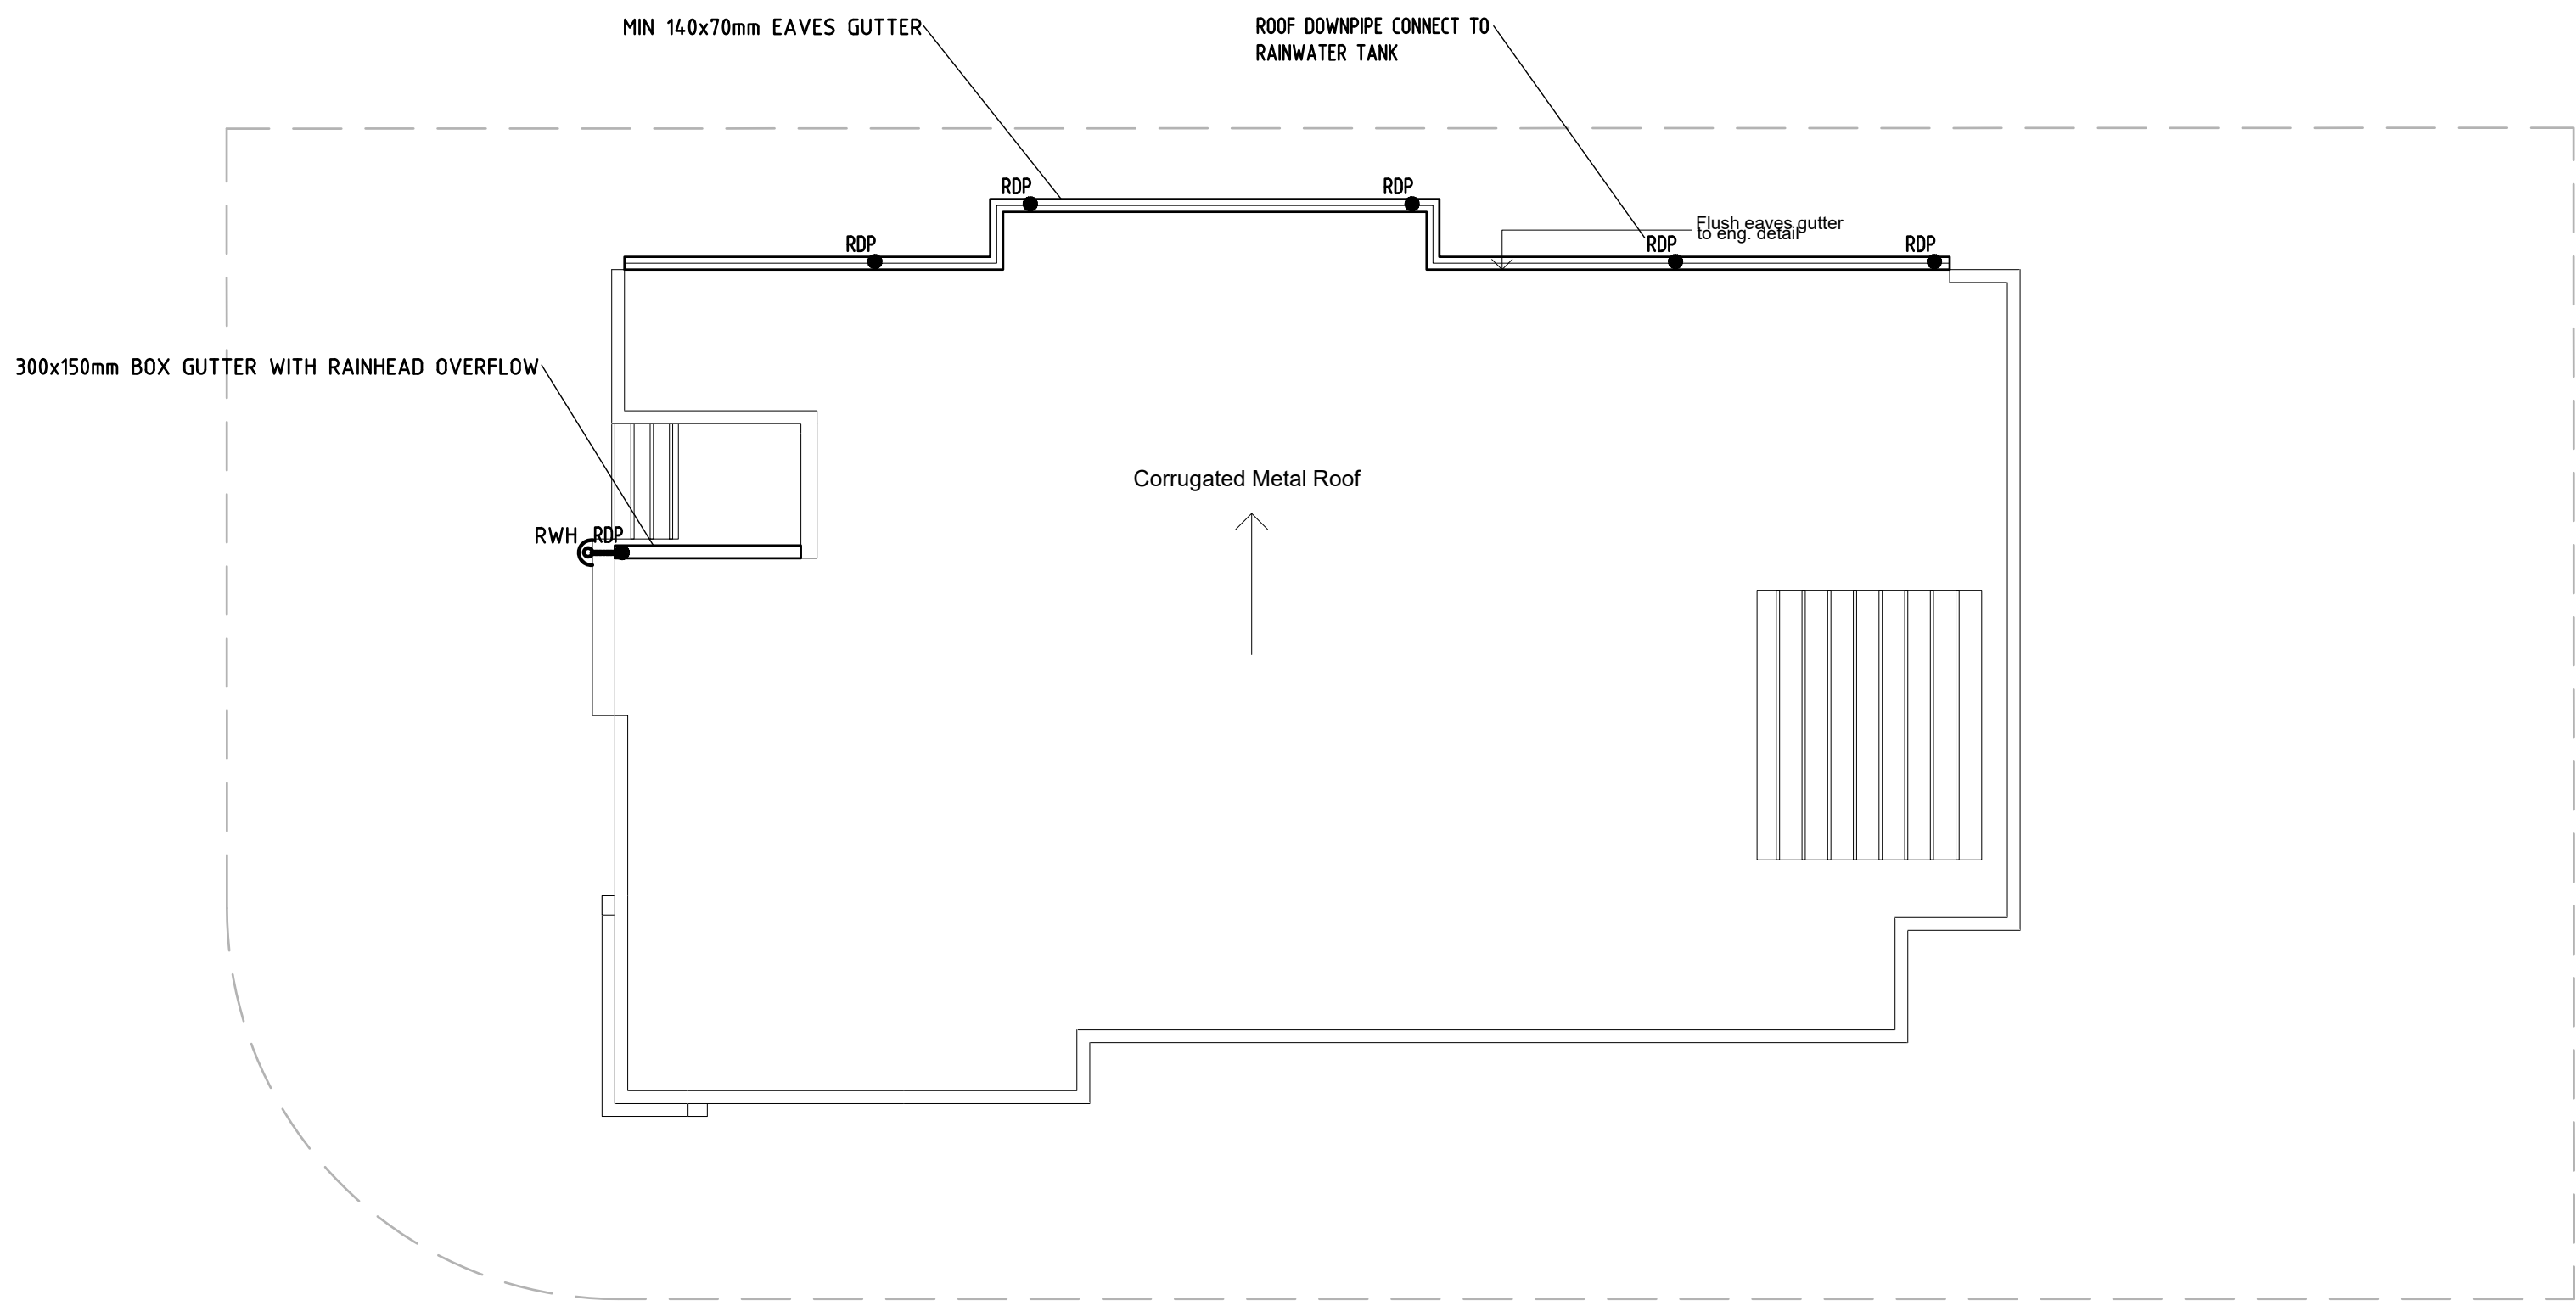A	05.06.2020	CONCEPT, ISSUED FOR DA APPROVAL		TA
REV.	DATE	AMENDMENT DESCRIPTION		DRAWN
<div><div></div><div><div>TAA CONSULTING ENGINEERS</div><div>CONSULTING CIVIL &amp; STRUCTURAL ENGINEERS</div><div>201/25 FALCON STREET, CROWS NEST NSW 2065 Ph 0411778799 TAAENGINEERS@GMAIL.COM</div></div></div>				
PROPOSED RESIDENTIAL DEVELOPMENT AT: 4 WOLLONGONG STREET, SHELLHARBOUR, NSW 2529				
ROOF PLAN				
DRAWN	CHECKED	SCALE	DATUM	DRAWING No.
TA	TONY ANAL - Civil & Structural Engineer (B.E. Civil (L1990) (MEANet):1905229	AS SHOWN	AHD	H399 - S4/6
				REV.
				A

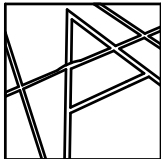


Approval has been granted subject to conditions in the Development Consent accompanying this plan.


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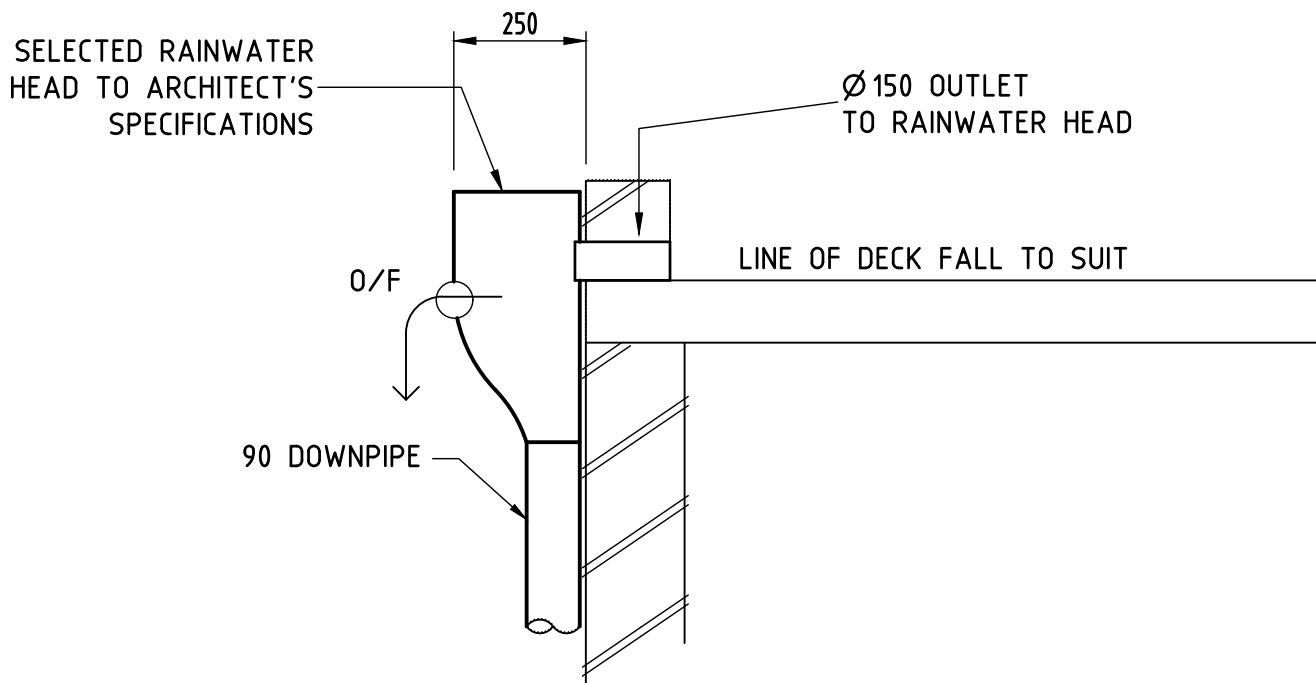
TERRACE OUTLET DETAIL (RW0)

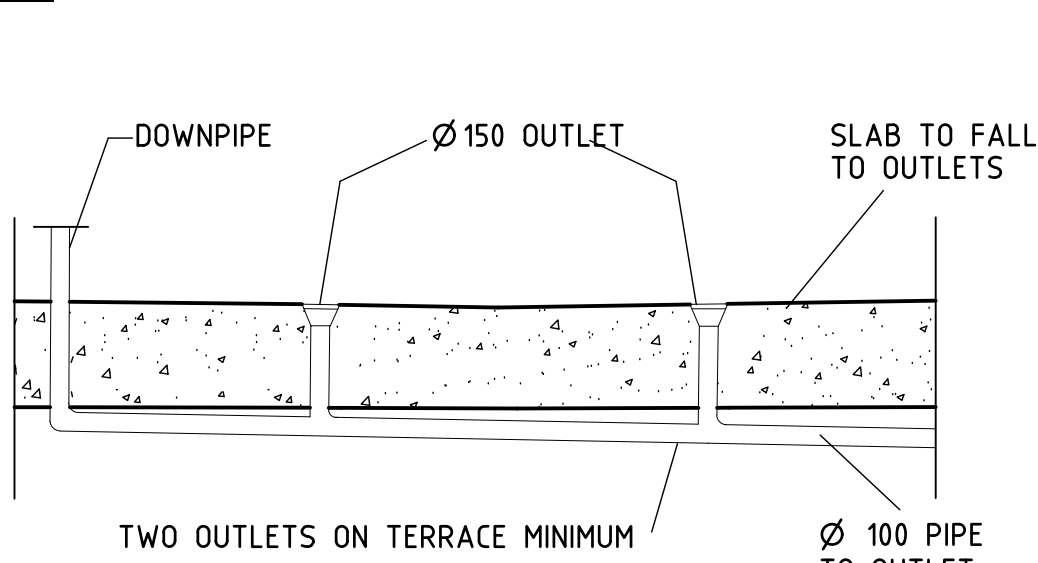


SILT ARRESTOR PIT DETAIL

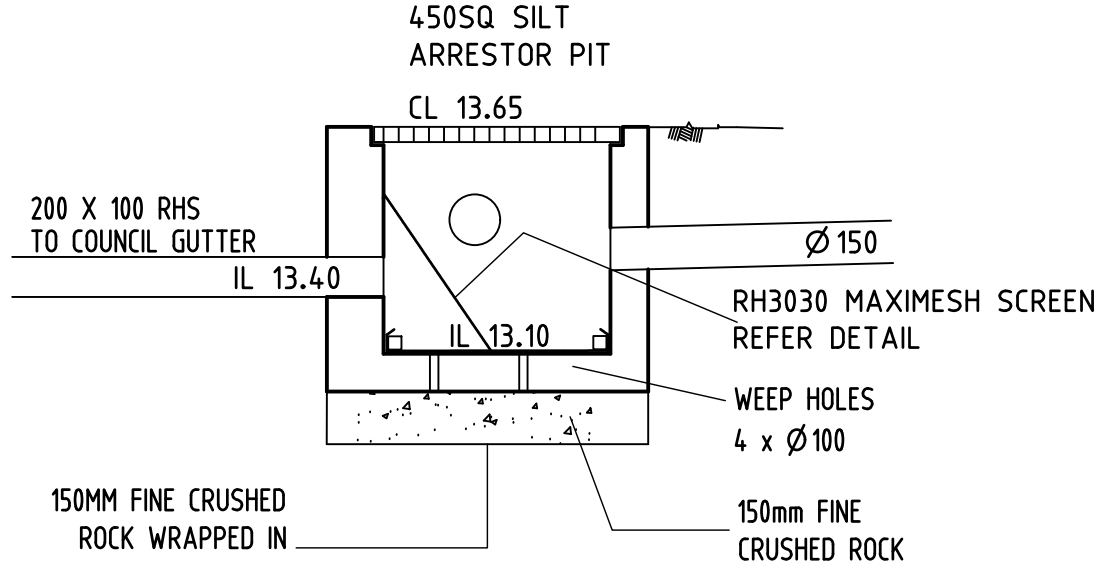

SCREEN DETAIL TYPICAL

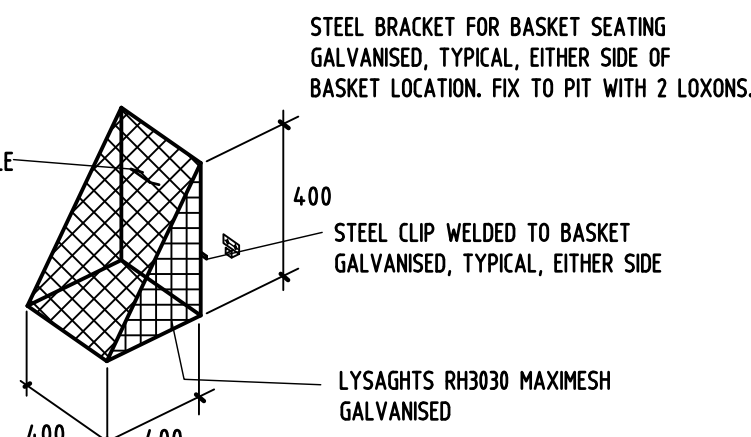

RAIN WATER HEAD DETAIL TYPICAL

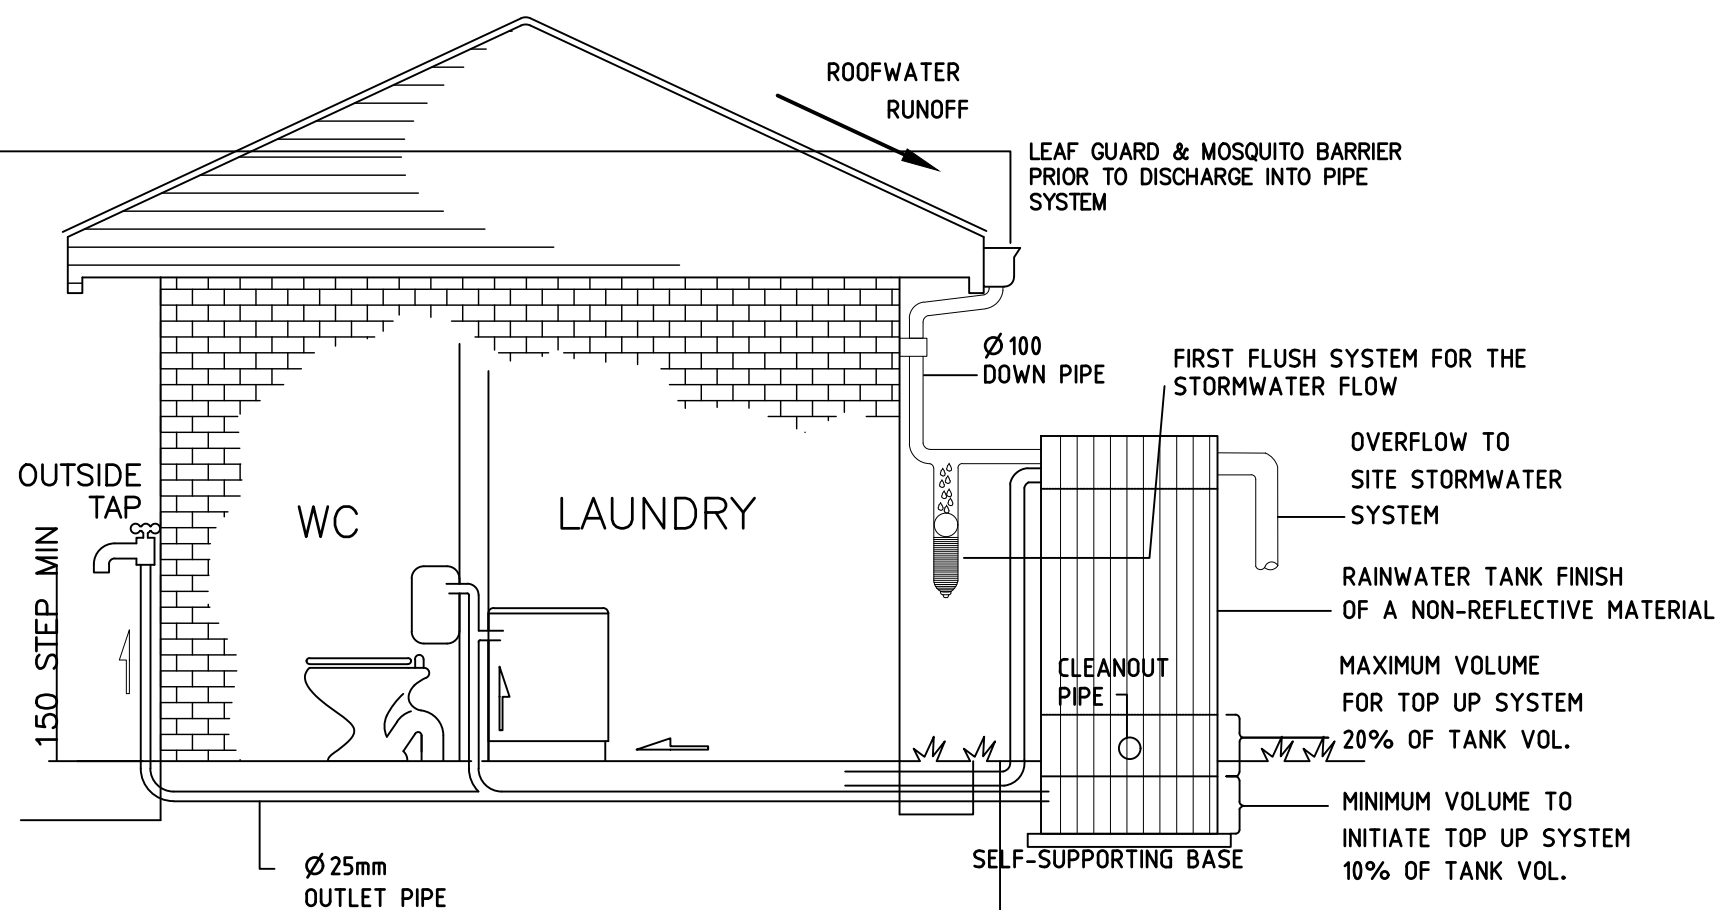

RAINWATER TANK DETAIL

N.T.S.  
INSTALLATION OF TANKS TO BE IN ACCORDANCE WITH MANUFACTURER SPECIFICATION.


RAINWATER TANK NOTES:

CONNECT ROOFWATER AS PER BASIX REQUIREMENTS  
RECYCLED WATER CONNECTIONS AS PER BASIX REQUIREMENTS


PROVIDE A MAINS BYPASS IN THE EVENT OF LOWER WATER LEVELS IN THE TANK OR PUMP FAILURE.

PROVIDE WARNING LABEL AS PER SYDNEY WATER REQUIREMENT INDICATING THAT THE WATER IS RAINWATER AND NOT TO BE CONSUMED


PROVIDE A FIRST FLUSH DIVERSION DEVICE AND SCREENING PRIOR TO WATER REACHING RAINWATER TANK.  
[www.rainharvesting.com.au](http://www.rainharvesting.com.au) or equivalent

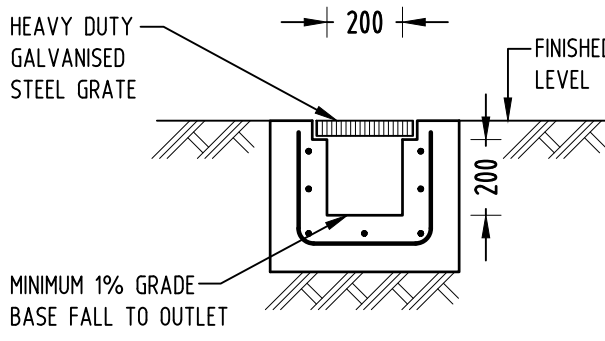

1  
DETAIL  
GRADED TRENCH DRAIN  
NOT TO SCALE

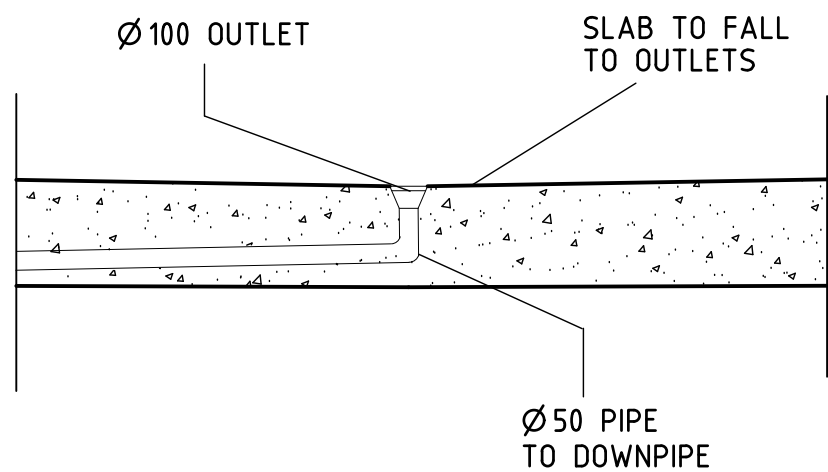


BALCONY OUTLET DETAIL (RW0)

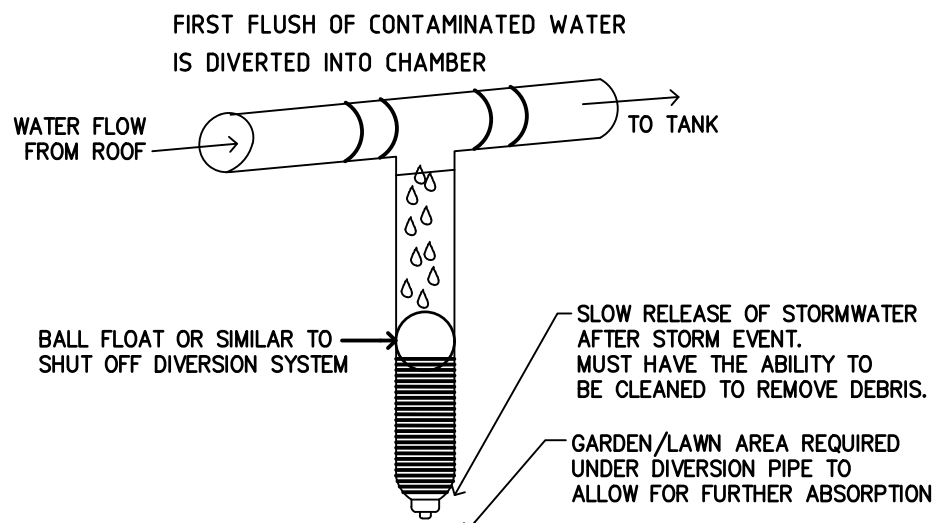

FIRST FLUSH WATER


DIVERTER DETAIL

N.T.S.

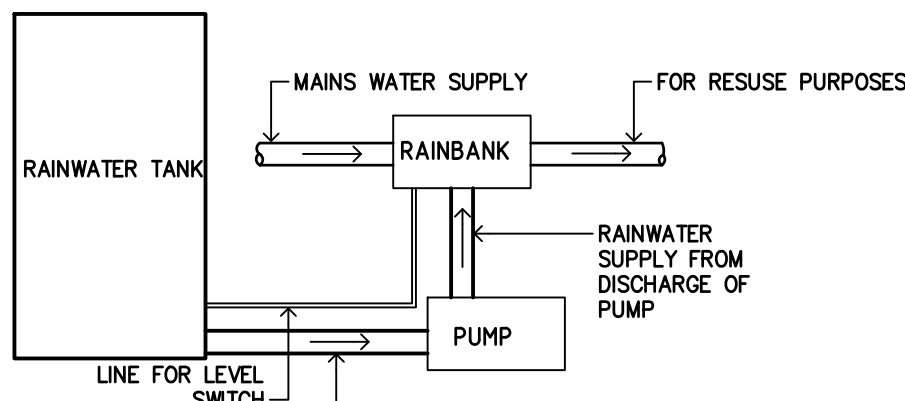

PLAN

N.T.S.

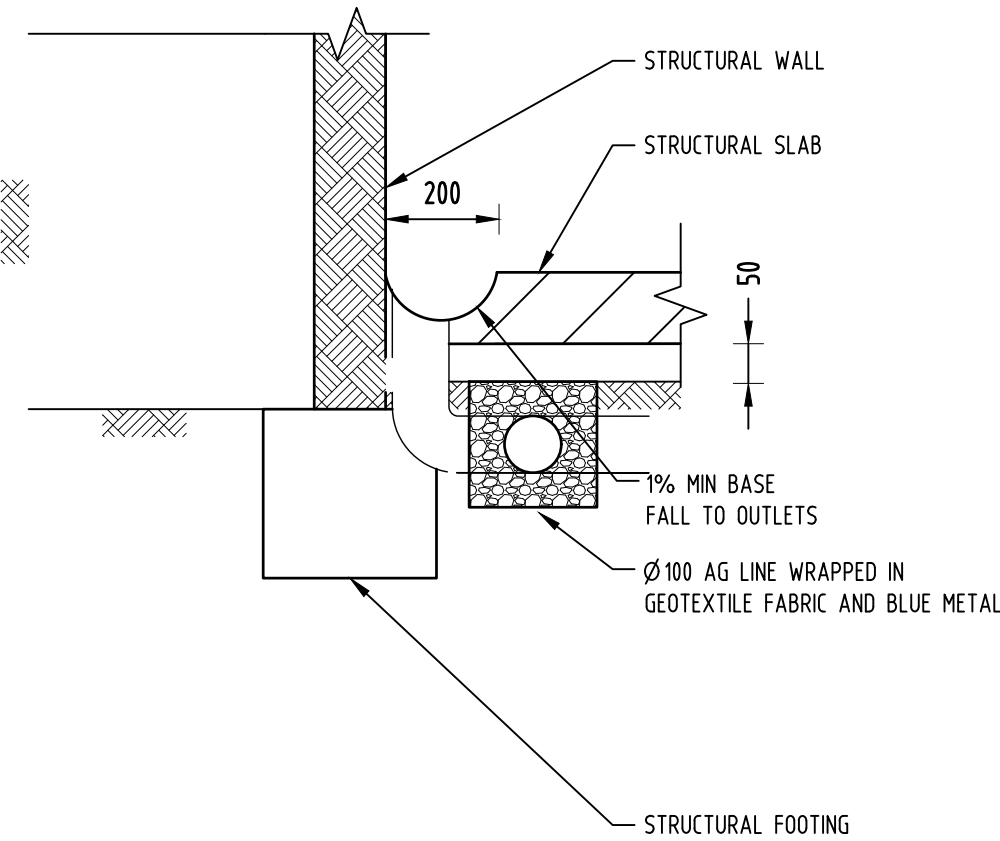


2  
DETAIL  
SUBSOIL DRAINAGE  
N.T.S.

A	05.06.2020	CONCEPT, ISSUED FOR DA APPROVAL	TA	
REV.	DATE	AMENDMENT DESCRIPTION	DRAWN	
<div><div></div><div><div>TAA CONSULTING ENGINEERS</div><div>CONSULTING CIVIL &amp; STRUCTURAL ENGINEERS</div><div>201/25 FALCON STREET, CROWS NEST NSW 2065 Ph: 0411778799 TAAENGINEERS@GMAIL.COM</div></div></div>				
PROPOSED RESIDENTIAL DEVELOPMENT AT: 4 WOLLONGONG STREET, SHELLHARBOUR, NSW 2529				
DETAILS SHEET				
DRAWN	CHECKED	SCALE	DATUM	DRAWING No.
TA	TONY ANAL - Civil & Structural Engineer (B.E. Civil (Lispy) (MEANet):1905229	AS SHOWN	AHD	H399 - S5/6
				REV.
				A



Approval has been granted subject to conditions in the Development Consent accompanying this plan.

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## EROSION & SEDIMENTATION CONTROL NOTES

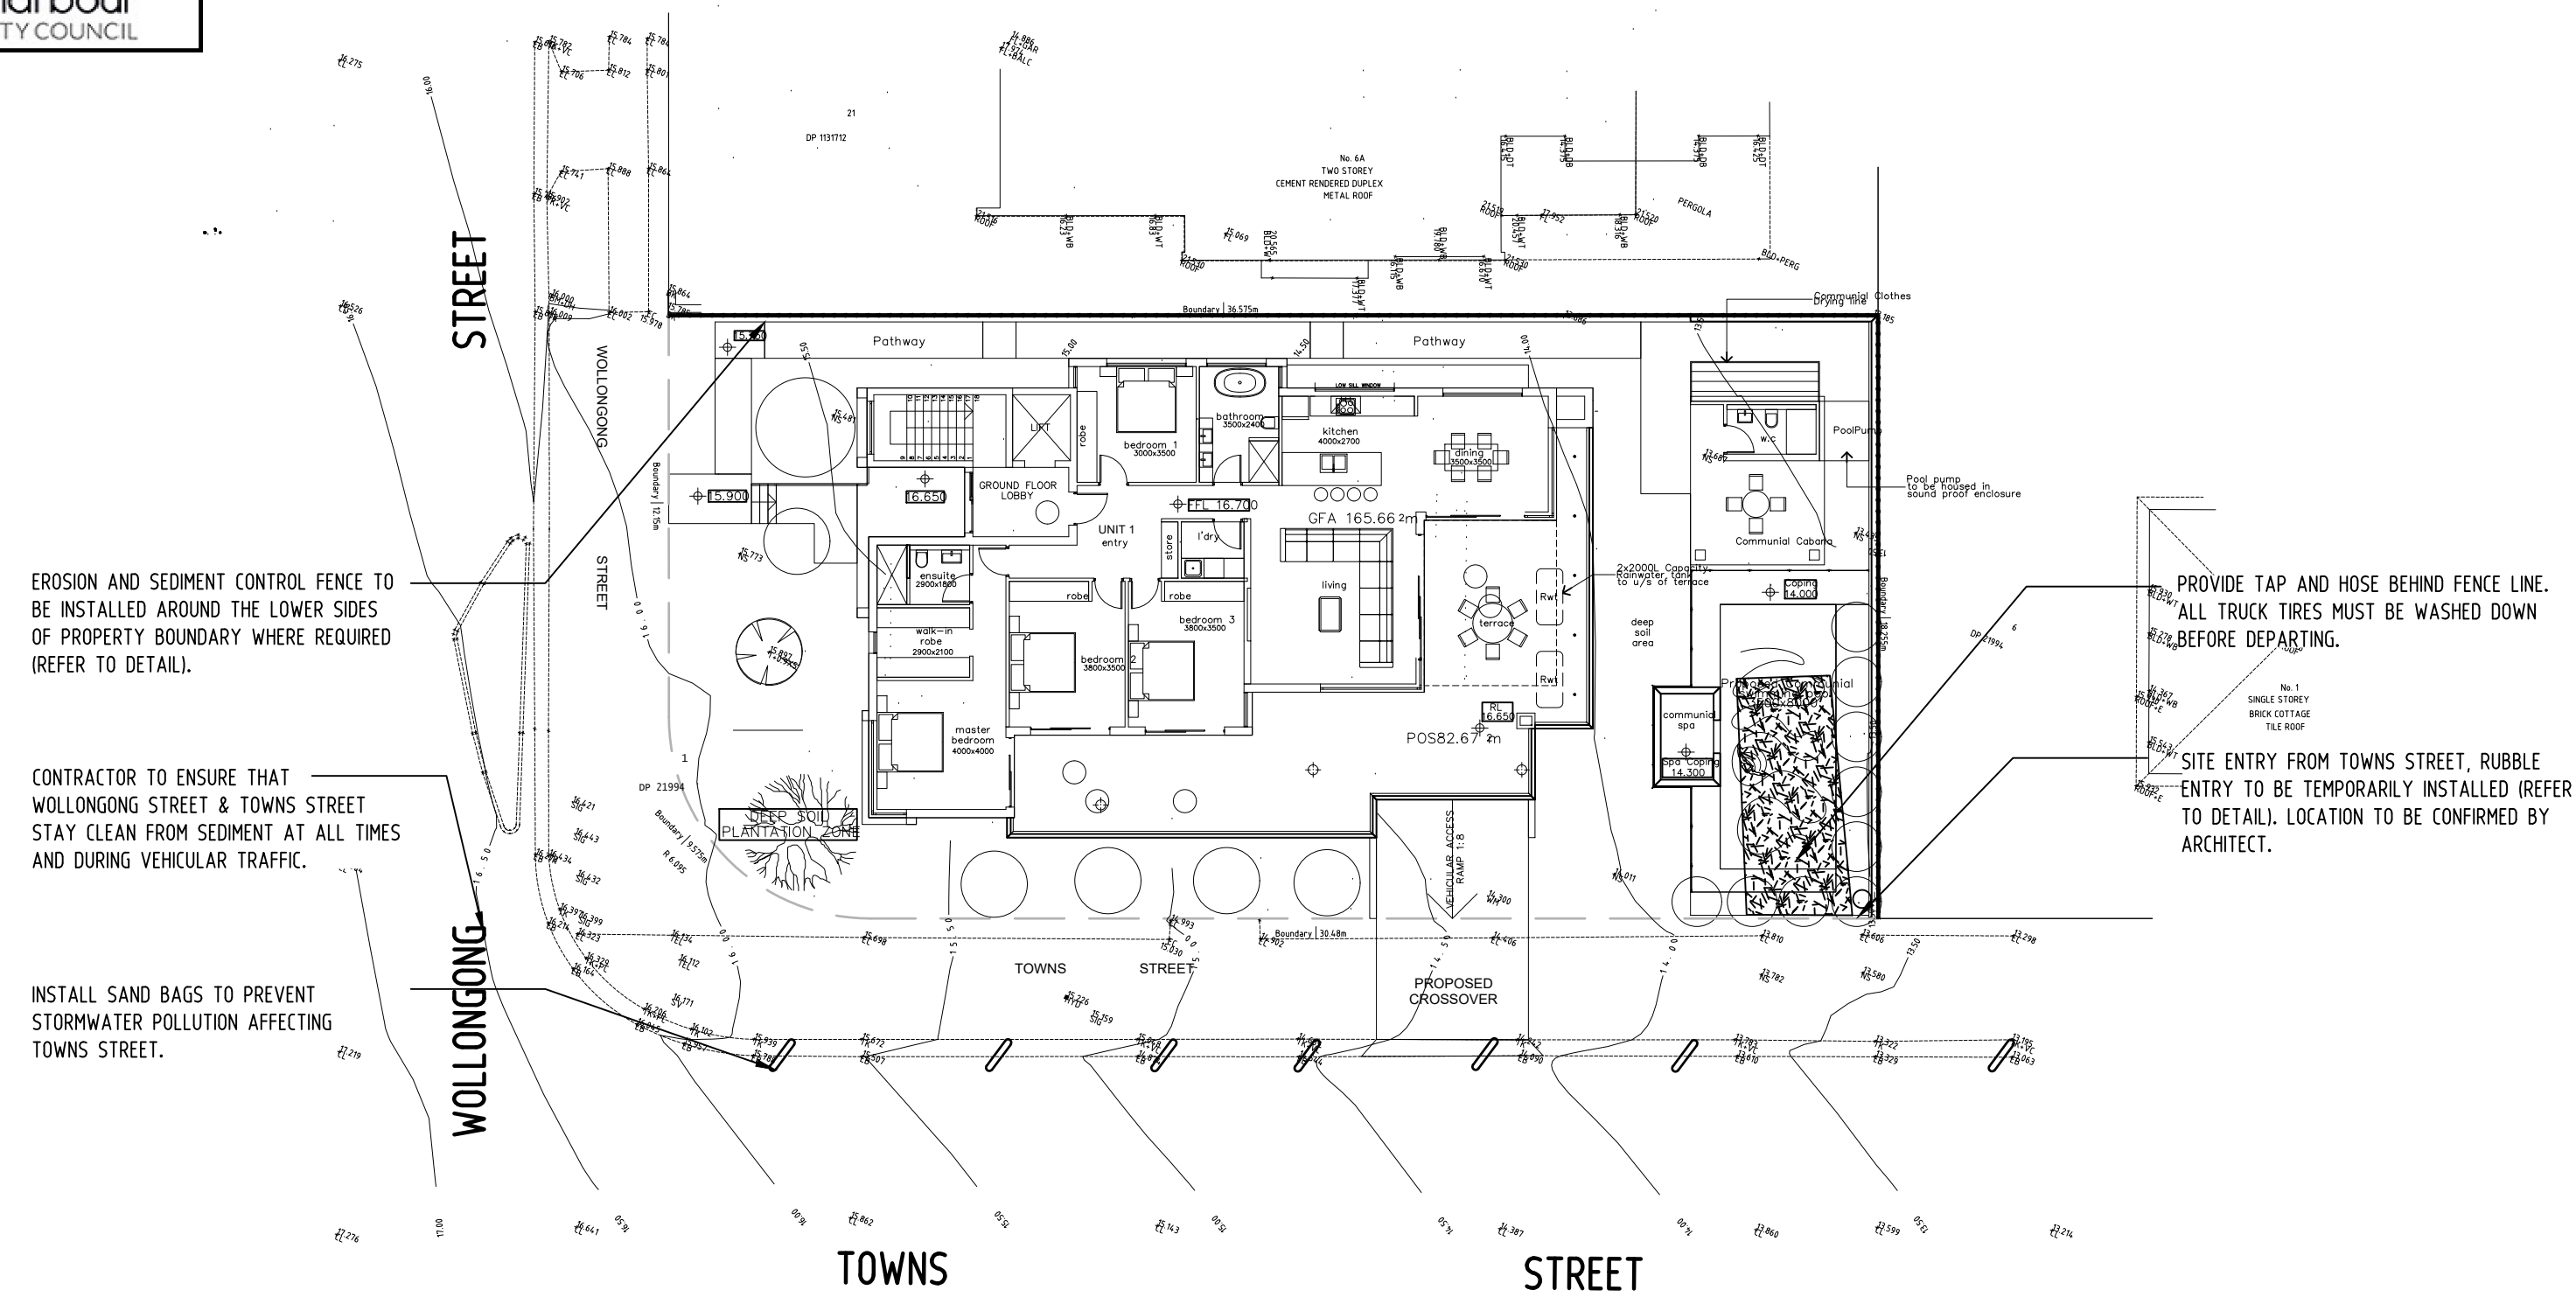- CONTRACTOR SHALL PROVIDE SEDIMENT FENCING MATERIAL DURING CONSTRUCTION TO THE LOW SIDE OF THE WORKS. TIE SEDIMENT FENCING MATERIAL TO CYCLONE WIRE SECURITY FENCE. SEDIMENT CONTROL FABRIC SHALL BE AN APPROVED MATERIAL (EG. HUMES PROPEX SILT STOP) STANDING 300mm ABOVE GROUND & EXTENDING 150mm BELOW GROUND.
- EXISTING DRAINS LOCATED WITHIN THE SITE SHALL ALSO BE ISOLATED BY SEDIMENT FENCING MATERIAL.
- NO PARKING OR STOCKPILING OF MATERIALS IS PERMITTED ON THE LOWER SIDE OF THE SEDIMENT FENCE.
- GRASS VERGES SHALL BE MAINTAINED AS MUCH AS PRACTICAL TO PROVIDE A BUFFER ZONE TO THE CONSTRUCTION SITE.
- CONSTRUCTION ENTRY/EXIT SHALL BE VIA THE LOCATION NOTED ON THE DRAWING. CONTRACTOR SHALL ENSURE ALL DROPPABLE SOIL & SEDIMENT IS REMOVED PRIOR TO CONSTRUCTION TRAFFIC EXITING SITE. CONTRACTOR SHALL ENSURE ALL CONSTRUCTION TRAFFIC ENTERING & LEAVING THE SITE DO SO IN A FORWARD DIRECTION.





## GENERAL NOTES

- THIS PLAN IS A CONCEPT PLAN ONLY FOR STORMWATER DISPOSAL & EROSION CONTROL. IT IS NOT SUITABLE FOR CONSTRUCTION. THIS PLAN SHOULD BE ADAPTED BY THE BUILDER DURING DEMOLITION, EXCAVATION & CONSTRUCTION PHASES TO ENSURE ADEQUATE PERFORMANCE.
- ALL DRAINAGE LAYOUT & DETAILS ARE DIAGRAMMATIC & INDICATIVE ONLY. ACTUAL LOCATION, SIZES, LEVELS & GRADES MAY ALTER WHEN DETAIL DESIGN WORKS ARE DOCUMENTED.

## CLAY SOILS

A SYSTEM SHALL BE INSTALLED TO EITHER:

- TRANSPORT STORMWATER RUNOFF WITH SUSPENDED SOLIDS FROM SITE VIA PUMP TRUCKS.
- TREAT THE STORMWATER RUNOFF WITH SUSPENDED SOLIDS SO THE DISCHARGE WATER QUALITY TO COUNCIL STORMWATER DRAINAGE SYSTEM HAS A MAXIMUM CONCENTRATION OF SUSPENDED SOLIDS THAT DOES NOT EXCEED 50 MILLIGRAMS PER LITRE IN ACCORDANCE WITH THE PROTECTION OF THE ENVIRONMENT OPERATION ACT (POEO 1997) AND SHALL BE APPROVED BY LOCAL COUNCIL.

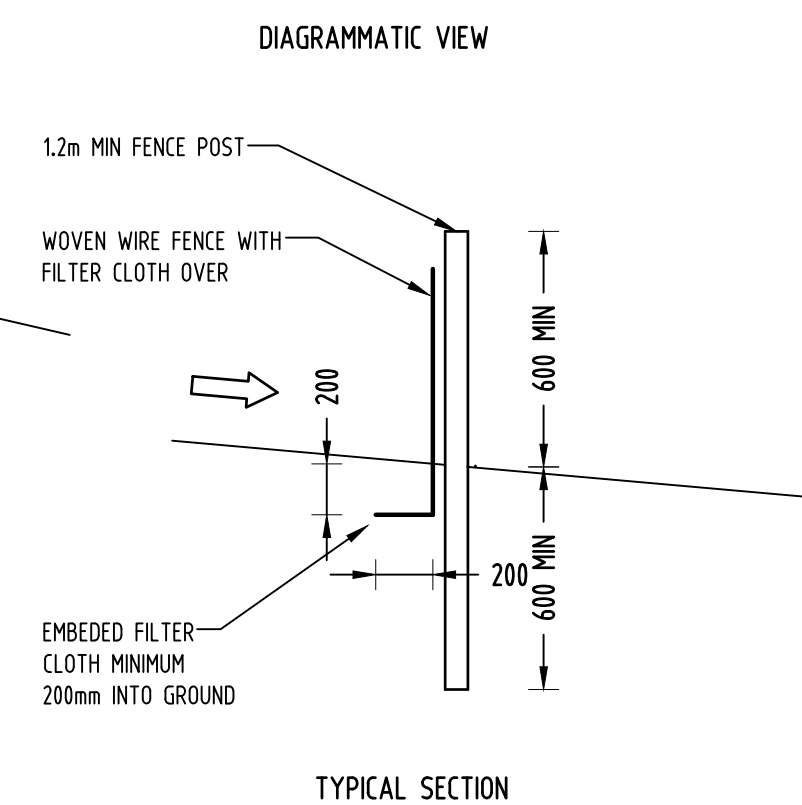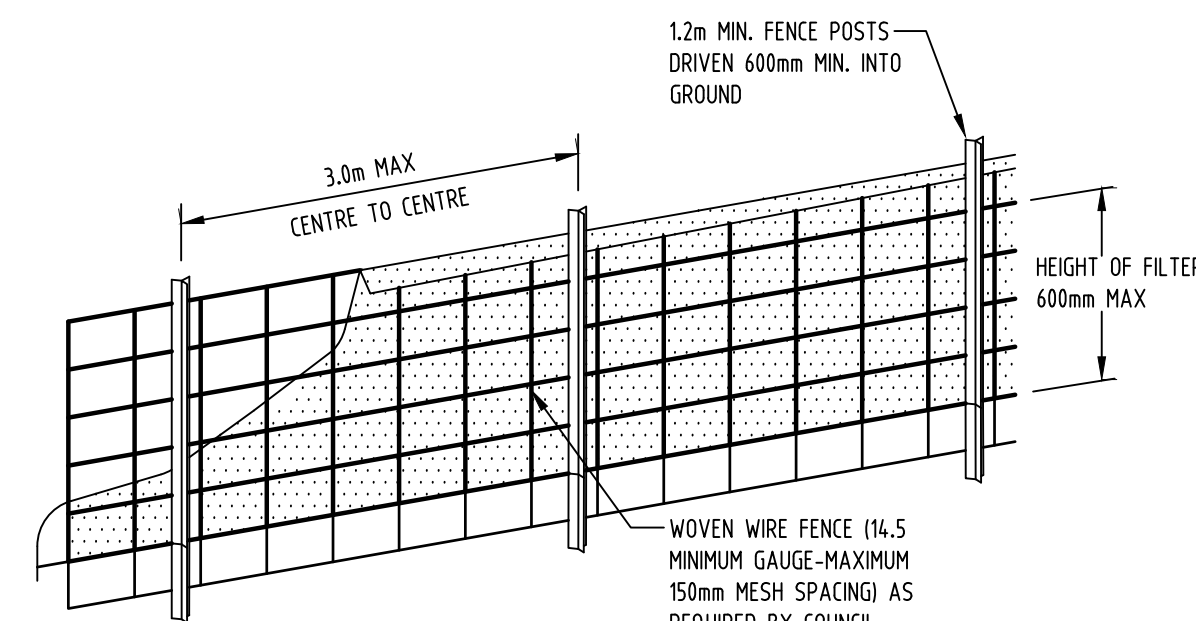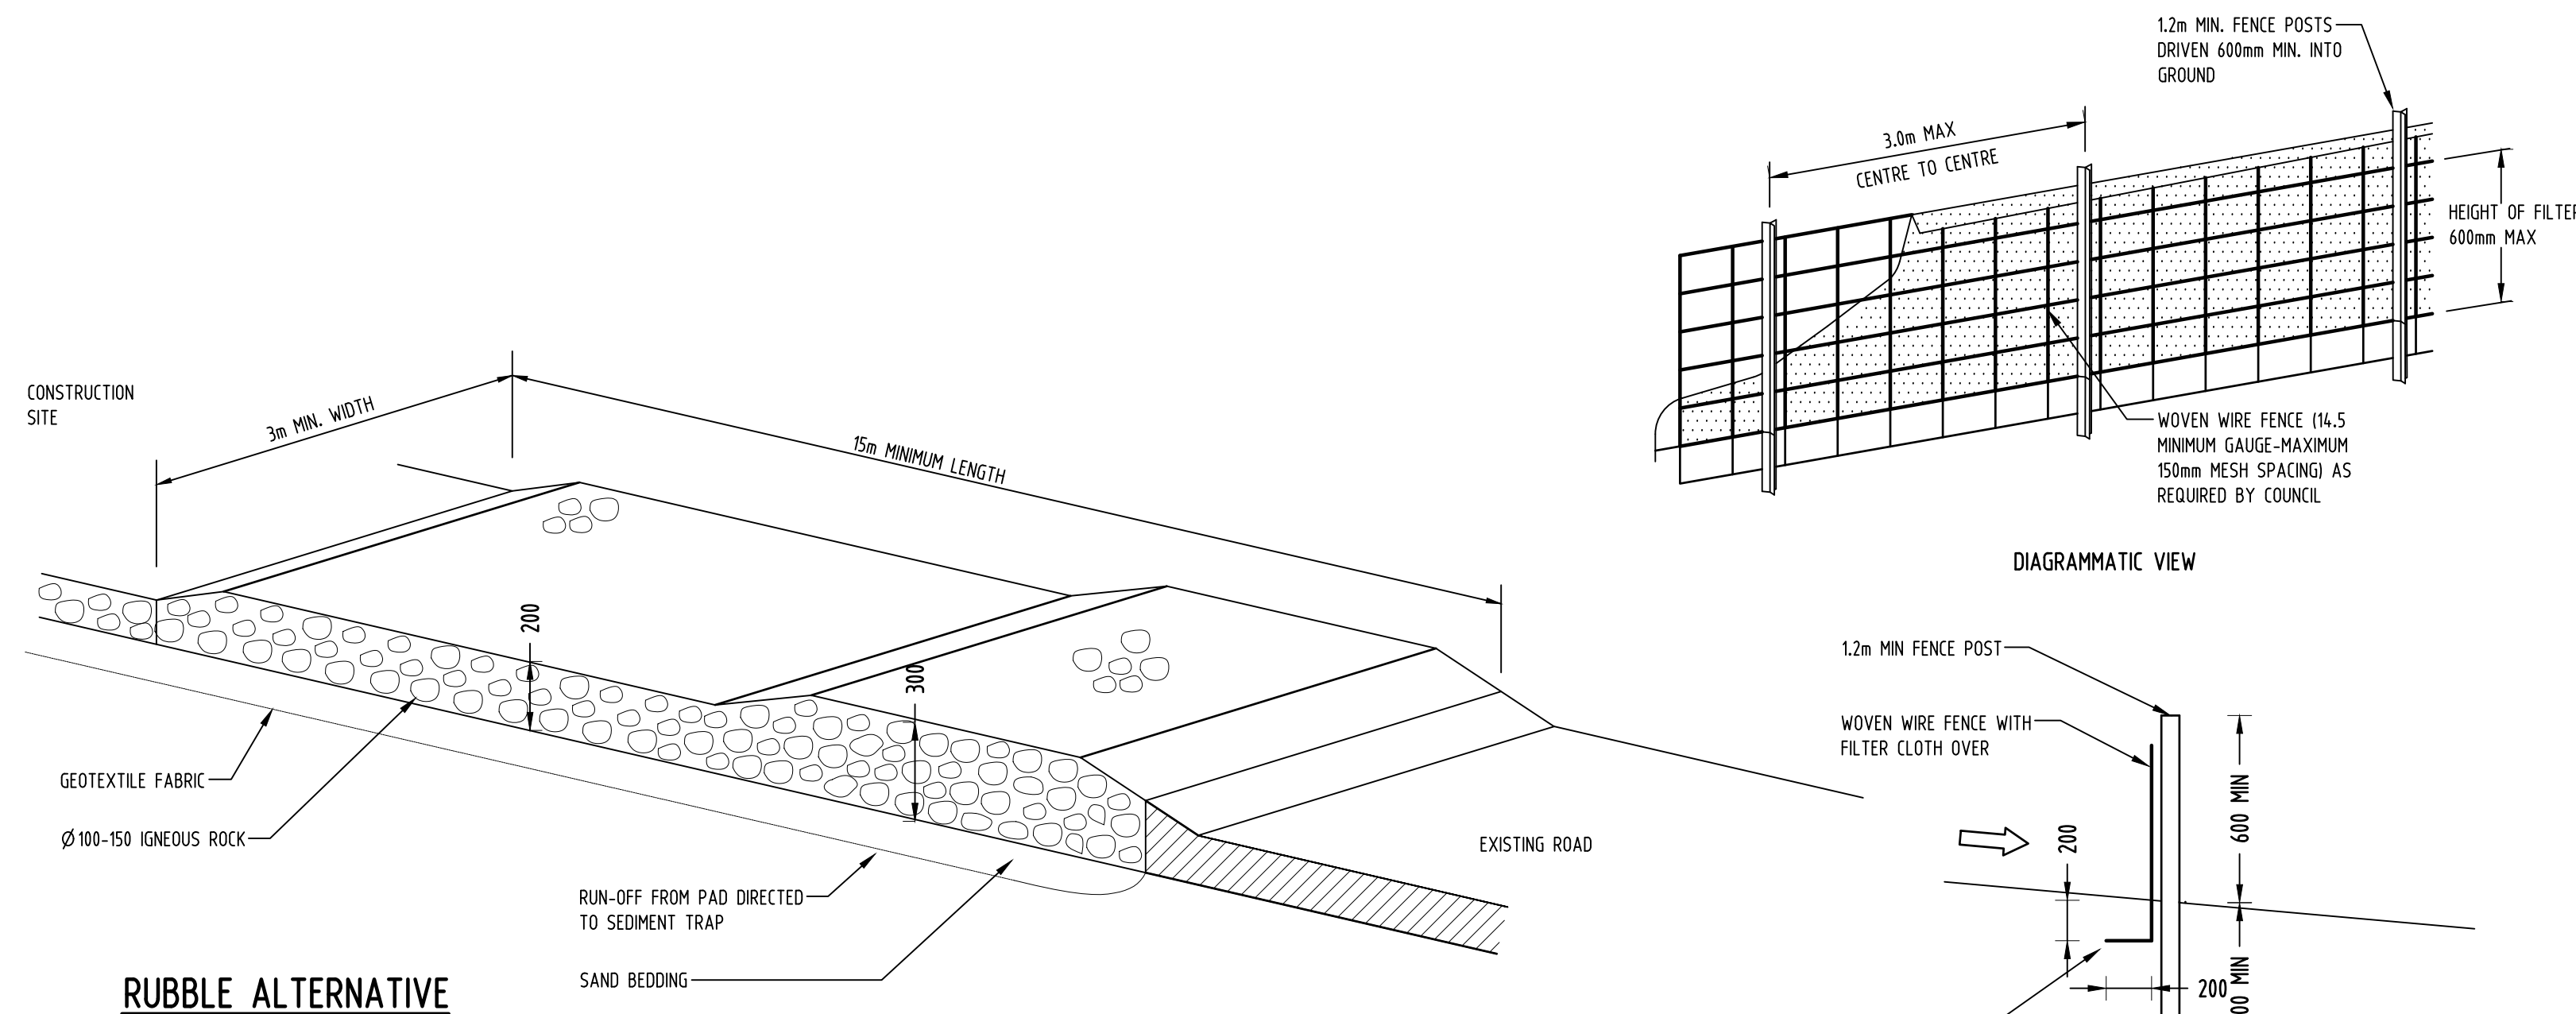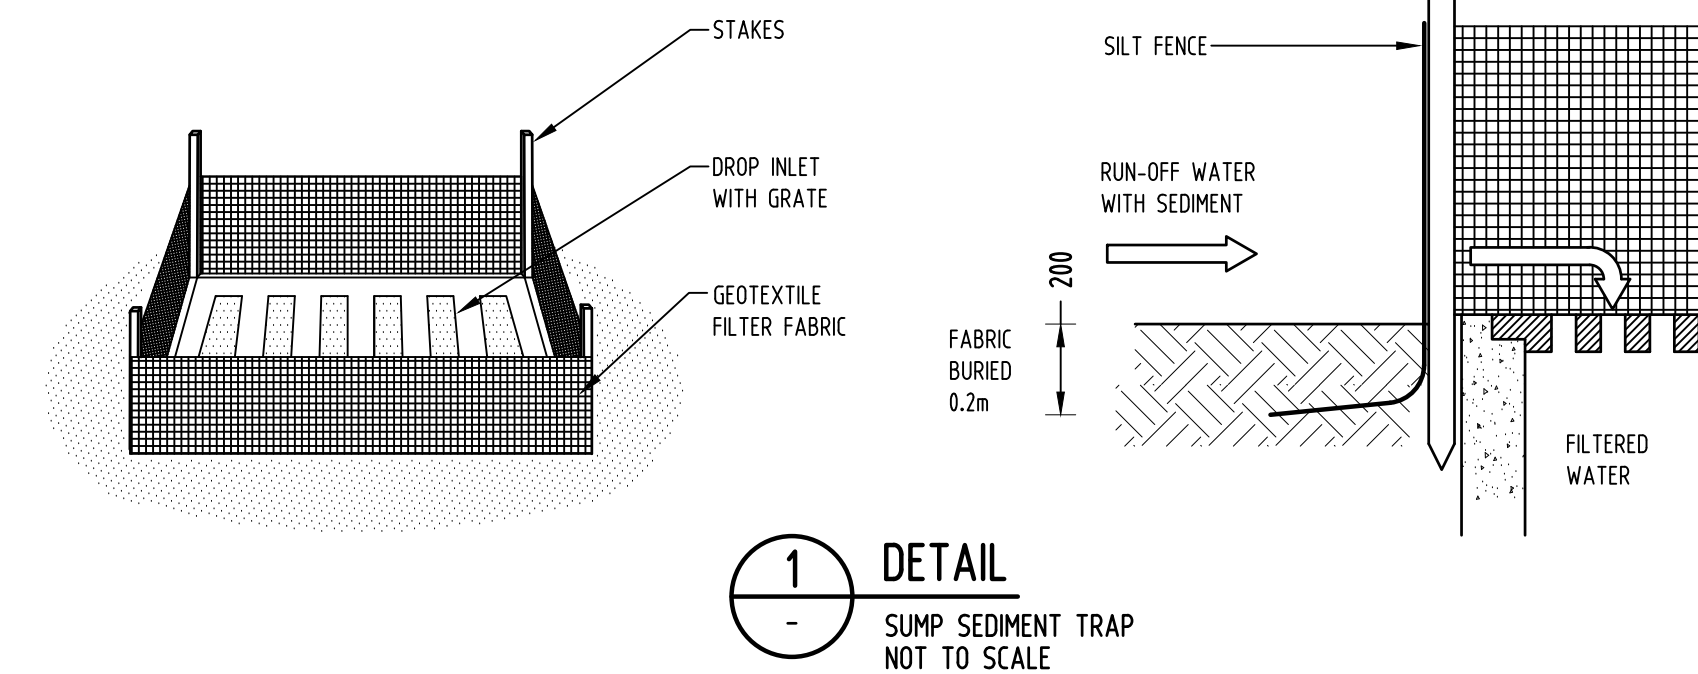

REV.	DATE	AMENDMENT DESCRIPTION	DRAWN
A	05.06.2020	CONCEPT, ISSUED FOR DA APPROVAL	TA
<div> <p><b>TAA CONSULTING ENGINEERS</b> CONSULTING CIVIL &amp; STRUCTURAL ENGINEERS 201/25 FALCON STREET, CROWS NEST NSW 2065 Ph 0411778799 TAAENGINEERS@GMAIL.COM</p> </div>			
PROPOSED RESIDENTIAL DEVELOPMENT AT: 4 WOLLONGONG STREET, SHELLHARBOUR, NSW 2529			
EROSION AND SEDIMENT CONTROL PLAN AND DETAILS			
DRAWN	CHECKED	SCALE	DATUM
TA	TONY AHAL - Civil & Structural Engineer (B.E. Civil (1999) (MBAust):1080229)	AS SHOWN	AHD
H399 - S6/6			A



Approval has been granted subject to conditions in the Development Consent accompanying this plan.

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**WASTE MANAGEMENT PLAN**  
**4 Wollongong Street, Shellharbour**



		SECTION ONE - DEMOLITION STAGE			
MATERIALS ON-SITE		DESTINATION			
		REUSE AND RECYCLING		DISPOSAL	
Type of Material	Estimated Volume cubic metres	ON-SITE Specify proposed reuse or on-site recycling methods	OFF-SITE Specify contractor and recycling outlet	Specify contractor and landfill site	
Excavation Material	0.5	<i>Keep and re-use topsoil for landscaping. Store on-site. Use some behind retaining walls.</i>		<i>remainder to landfill site</i>	
Green Waste	0.5	<i>Will be separated. Some chipped &amp; stored on-site for re-use on landscaping</i>	<i>Remainder to landscape suppliers for composting or reuse</i>	<i>stumps and large trunks separated</i>	
Bricks	10	<i>Clean lime mortar from bricks. Re-use bricks in new footings. Broken bricks for internal walls.</i>	<i>Concrete mortar bricks to crushing and recycling company</i>	<i>Nil</i>	
Concrete	2.5	<i>Existing driveway to remain during construction</i>	<i>one completion to crushing and recycling company</i>	<i>Nil</i>	
Timber - Please specify <i>oregon &amp; pine</i>	2	<i>Re-use for formwork &amp; studwork. Chip remainder for use in landscaping</i>	<i>to stockpile at transfer station</i>	<i>Nil</i>	
Plasterboard	2	<i>Break-up &amp; use in landscaping</i>	<i>remainder to landscape suppliers</i>	<i>Nil</i>	
Metals <i>water pipes gutters lead</i>	1	<i>Nil</i>	<i>remainder to metal recyclers</i>	<i>Nil</i>	
Other- <i>roof tiles</i>	1	<i>Broken tiles for fill</i>	<i>Refer to attachment</i>	<i>Nil</i>	
<i>door fittings</i>		<i>On-site sale</i>		<i>Nil</i>	



### WASTE MANAGEMENT PLAN: CONSTRUCTION

SECTION TWO - CONSTRUCTION STAGE				
MATERIALS ON-SITE		DESTINATION		
		REUSE AND RECYCLING		DISPOSAL
Type of Material	Estimated Volume cubic metres	ON-SITE Specify proposed reuse or on-site recycling methods	OFF-SITE Specify contractor and recycling outlet	Specify contractor and landfill site
Excavation Material	-	<i>Covered in SECTION 1 As part of demolition</i>		
Green Waste	-	<i>Covered in SECTION 1 As part of demolition</i>		
Bricks	2.5	<i>Use for fill behind retaining walls.</i>	<i>Remainder to crushing and recycling company</i>	<i>Nil</i>
Concrete	1.5	<i>Use for fill behind retaining walls</i>	<i>remainder to crushing and recycling company</i>	<i>Nil</i>
Timber - Please specify  <i>oregon pine particle board finishes skirting and architraves</i>	2	<i>Chip for landscaping. Sell some for firewood.</i>	<i>remainder to landscape suppliers for chipping and composting</i>	<i>Nil</i>
Plasterboard	1.5	<i>Break-up &amp; use in landscaping</i>	<i>remainder to landscape suppliers</i>	<i>Nil</i>
Metals <i>Copper steel reo mesh aluminium</i>	0.5	<i>Nil</i>	<i>some to metal recyclers for reuse</i>	<i>Remainder to landfill site by waste contractors</i>
Other-  <i>Plastics</i>		<i>Nil</i>	<i>Refer to attachment</i>	



## ESTIMATING WASTE

As a guide to estimating waste for inclusion in the waste management plan mentioned above.

TRADE	WASTE ALLOWANCE %
Bricks	2 - 5
Brick accessories	10
Concrete	5 - 10
Concrete reinforcement	< 1
Concrete membrane	10
Carpentry	3 - 15
Roof tiling	5
Drywall, plasterboard	5 - 10
Tiles	2 - 10

## Demolition Waste & Recycling List

### Waste Reduction & Recovery Tips:

Materials:	Company Name	Company Address	Contact Details
Excavation Material / Soil Waste	Enviroguard		
Green Waste	Ecocycle		
Bricks	Brandown		
Concrete	Brandown		
Timber	Artistic Popular Furniture		
Metals	Parramatta Scrap Metal		
Roof Tiles	Obsolete Tiles		
Door Fittings	Recycling Works		
Plastics	Chromford		
Plasterboard	Ecocycle		
Fibro Containing Asbestos	Enviroguard		



# **ONGOING WASTE MANAGEMENT PLAN**

## **PROPOSED DUAL OCCUPANCY**

4 Wollongong Street, Shellharbour

It is proposed that waste generated by the residences of the development will be stored on site in appropriate waste bins.

The location of the bins would be in the basement level, in a designated waste area. The appropriate bins supplied by council would be used for general household waste, recycling and garden waste. It is proposed that the residence would require:

- 2 x General household waste bins
- 2 x recycling bins
- 2 x Garden waste bin

These will be put out once a week on the designated garbage night and brought in the next morning by the residence.



# BASIX<sup>®</sup>Certificate

Building Sustainability Index [www.basix.nsw.gov.au](http://www.basix.nsw.gov.au)

## Multi Dwelling

Certificate number: 1103768M\_02

This certificate confirms that the proposed development will meet the NSW government's requirements for sustainability, if it is built in accordance with the commitments set out below. Terms used in this certificate, or in the commitments, have the meaning given by the document entitled "BASIX Definitions" dated 06/10/2017 published by the Department. This document is available at [www.basix.nsw.gov.au](http://www.basix.nsw.gov.au)

Secretary

Date of issue: Thursday, 04 June 2020

To be valid, this certificate must be lodged within 3 months of the date of issue.



Planning,  
Industry &  
Environment

**DA No. DA0246/2020**

**Approval has been granted subject to conditions in the Development Consent accompanying this plan.**

**These plans may be modified by conditions of consent. Please refer to consent documents for details.**



### Project summary

Project name	4 Wollongong St, Shellharbour_02
Street address	4 Wollongong Street Shellharbour 2529
Local Government Area	Shellharbour City Council
Plan type and plan number	deposited 21994
Lot no.	1
Section no.	-
No. of residential flat buildings	0
No. of units in residential flat buildings	0
No. of multi-dwelling houses	2
No. of single dwelling houses	0

### Project score

Water	✓ 45	Target 40
Thermal Comfort	✓ Pass	Target Pass
Energy	✓ 55	Target 50

### Certificate Prepared by

Name / Company Name: BCA Energy Pty Ltd

ABN (if applicable): 72159518260

# Description of project

## Project address

Project name	4 Wollongong St, Shellharbour_02
Street address	4 Wollongong Street Shellharbour 2529
Local Government Area	Shellharbour City Council
Plan type and plan number	deposited 21994
Lot no.	1
Section no.	-

## Project type

No. of residential flat buildings	0
No. of units in residential flat buildings	0
No. of multi-dwelling houses	2
No. of single dwelling houses	0

## Site details

Site area (m²)	657
Roof area (m²)	247
Non-residential floor area (m²)	0.0
Residential car spaces	4
Non-residential car spaces	0

## Common area landscape

Common area lawn (m²)	100.0
Common area garden (m²)	100.0
Area of indigenous or low water use species (m²)	100.0

## Assessor details

Assessor number	20039
Certificate number	0004890650
Climate zone	18

## Project score

Water	✓ 45	Target 40
Thermal Comfort	✓ Pass	Target Pass
Energy	✓ 55	Target 50



## Description of project

The tables below describe the dwellings and common areas within the project

### Multi-dwelling houses

Dwelling no.	No. of bedrooms	Conditioned floor area (m <sup>2</sup> )	Unconditioned floor area (m <sup>2</sup> )	Area of garden & lawn (m <sup>2</sup> )	Indigenous species (min area m <sup>2</sup> )
1	4 or more bedrooms	165.5	0.0	0.0	0.0

Dwelling no.	No. of bedrooms	Conditioned floor area (m <sup>2</sup> )	Unconditioned floor area (m <sup>2</sup> )	Area of garden & lawn (m <sup>2</sup> )	Indigenous species (min area m <sup>2</sup> )
2	4 or more bedrooms	165.5	0.0	0.0	0.0

## Description of project

The tables below describe the dwellings and common areas within the project

### Common areas of the development (non-building specific)

Common area	Floor area (m²)
Car park area (No. 1)	166.0
Plant or service room (No. 1)	10.5

Common area	Floor area (m²)
Lift car (No.1)	-

Common area	Floor area (m²)
Garbage room (No. 1)	10.6



# Schedule of BASIX commitments

## 1. Commitments for multi-dwelling houses

### (a) Dwellings

- (i) Water
- (ii) Energy
- (iii) Thermal Comfort

## 2. Commitments for single dwelling houses

## 3. Commitments for common areas and central systems/facilities for the development (non-building specific)

- (i) Water
- (ii) Energy

## Schedule of BASIX commitments

The commitments set out below regulate how the proposed development is to be carried out. It is a condition of any development consent granted, or complying development certificate issued, for the proposed development, that BASIX commitments be complied with.

### 1. Commitments for multi-dwelling houses

#### (a) Dwellings

(i) Water	Show on DA plans	Show on CC/CDC plans & specs	Certifier check
(a) The applicant must comply with the commitments listed below in carrying out the development of a dwelling listed in a table below.			
(b) The applicant must plant indigenous or low water use species of vegetation throughout the area of land specified for the dwelling in the "Indigenous species" column of the table below, as private landscaping for that dwelling. (This area of indigenous vegetation is to be contained within the "Area of garden and lawn" for the dwelling specified in the "Description of Project" table).	✓	✓	
(c) If a rating is specified in the table below for a fixture or appliance to be installed in the dwelling, the applicant must ensure that each such fixture and appliance meets the rating specified for it.		✓	✓
(d) The applicant must install an on demand hot water recirculation system which regulates all hot water use throughout the dwelling, where indicated for a dwelling in the "HW recirculation or diversion" column of the table below.		✓	✓
(e) The applicant must install:			
(aa) a hot water diversion system to all showers, kitchen sinks and all basins in the dwelling, where indicated for a dwelling in the "HW recirculation or diversion" column of the table below; and		✓	✓
(bb) a separate diversion tank (or tanks) connected to the hot water diversion systems of at least 100 litres. The applicant must connect the hot water diversion tank to all toilets in the dwelling.		✓	✓
(e) The applicant must not install a private swimming pool or spa for the dwelling, with a volume exceeding that specified for it in the table below.	✓	✓	
(f) If specified in the table, that pool or spa (or both) must have a pool cover or shading (or both).		✓	
(g) The pool or spa must be located as specified in the table.	✓	✓	
(h) The applicant must install, for the dwelling, each alternative water supply system, with the specified size, listed for that dwelling in the table below. Each system must be configured to collect run-off from the areas specified (excluding any area which supplies any other alternative water supply system), and to divert overflow as specified. Each system must be connected as specified.	✓	✓	✓



	Fixtures					Appliances		Individual pool				Individual spa		
Dwelling no.	All shower-heads	All toilet flushing systems	All kitchen taps	All bathroom taps	HW recirculation or diversion	All clothes washers	All dish-washers	Volume (max volume)	Pool cover	Pool location	Pool shaded	Volume (max volume)	Spa cover	Spa shaded
All dwellings	3 star (> 4.5 but <= 6 L/min)	4 star	5 star	5 star	no	-	-	-	-	-	-	-	-	-

	Alternative water source							
Dwelling no.	Alternative water supply systems	Size	Configuration	Landscape connection	Toilet connection (s)	Laundry connection	Pool top-up	Spa top-up
All dwellings	central water tank (no. 1)	See central systems	See central systems	-	yes	-	-	-
None	-	-	-	-	-	-	-	-

(ii) Energy	Show on DA plans	Show on CC/CDC plans & specs	Certifier check
(a) The applicant must comply with the commitments listed below in carrying out the development of a dwelling listed in a table below.			
(b) The applicant must install each hot water system specified for the dwelling in the table below, so that the dwelling's hot water is supplied by that system. If the table specifies a central hot water system for the dwelling, then the applicant must connect that central system to the dwelling, so that the dwelling's hot water is supplied by that central system.	✓	✓	✓
(c) The applicant must install, in each bathroom, kitchen and laundry of the dwelling, the ventilation system specified for that room in the table below. Each such ventilation system must have the operation control specified for it in the table.		✓	✓
(d) The applicant must install the cooling and heating system/s specified for the dwelling under the "Living areas" and "Bedroom areas" headings of the "Cooling" and "Heating" columns in the table below, in/for at least 1 living/bedroom area of the dwelling. If no cooling or heating system is specified in the table for "Living areas" or "Bedroom areas", then no systems may be installed in any such areas. If the term "zoned" is specified beside an air conditioning system, then the system must provide for day/night zoning between living areas and bedrooms.		✓	✓
(e) This commitment applies to each room or area of the dwelling which is referred to in a heading to the "Artificial lighting" column of the table below (but only to the extent specified for that room or area). The applicant must ensure that the "primary type of artificial lighting" for each such room in the dwelling is fluorescent lighting or light emitting diode (LED) lighting. If the term "dedicated" is specified for a particular room or area, then the light fittings in that room or area must only be capable of being used for fluorescent lighting or light emitting diode (LED) lighting.		✓	✓

(ii) Energy	Show on DA plans	Show on CC/CDC plans & specs	Certifier check
(f) This commitment applies to each room or area of the dwelling which is referred to in a heading to the "Natural lighting" column of the table below (but only to the extent specified for that room or area). The applicant must ensure that each such room or area is fitted with a window and/or skylight.	✓	✓	✓
(g) This commitment applies if the applicant installs a water heating system for the dwelling's pool or spa. The applicant must: (aa) install the system specified for the pool in the "Individual Pool" column of the table below (or alternatively must not install any system for the pool). If specified, the applicant must install a timer, to control the pool's pump; and (bb) install the system specified for the spa in the "Individual Spa" column of the table below (or alternatively must not install any system for the spa). If specified, the applicant must install a timer to control the spa's pump.		✓ ✓	
(h) The applicant must install in the dwelling: (aa) the kitchen cook-top and oven specified for that dwelling in the "Appliances & other efficiency measures" column of the table below; (bb) each appliance for which a rating is specified for that dwelling in the "Appliances & other efficiency measures" column of the table, and ensure that the appliance has that minimum rating; and (cc) any clothes drying line specified for the dwelling in the "Appliances & other efficiency measures" column of the table.		✓ ✓ ✓	✓
(i) If specified in the table, the applicant must carry out the development so that each refrigerator space in the dwelling is "well ventilated".		✓	
(j) The applicant must install the photovoltaic system specified for the dwelling under the "Photovoltaic system" heading of the "Alternative energy" column of the table below, and connect the system to that dwelling's electrical system.	✓	✓	✓

	Hot water	Bathroom ventilation system		Kitchen ventilation system		Laundry ventilation system	
Dwelling no.	Hot water system	Each bathroom	Operation control	Each kitchen	Operation control	Each laundry	Operation control
All dwellings	gas instantaneous 6 star	individual fan, ducted to façade or roof	manual switch on/off	individual fan, ducted to façade or roof	manual switch on/off	individual fan, ducted to façade or roof	manual switch on/off



Dwelling no.	Cooling		Heating		Artificial lighting						Natural lighting	
	living areas	bedroom areas	living areas	bedroom areas	No. of bedrooms &/or study	No. of living &/or dining rooms	Each kitchen	All bathrooms/toilets	Each laundry	All hallways	No. of bathrooms &/or toilets	Main kitchen
All dwellings	1-phase airconditioning 3.5 Star (old label)	1-phase airconditioning 3.5 Star (old label)	1-phase airconditioning 3.5 Star (old label)	1-phase airconditioning 3.5 Star (old label)	4 (dedicated)	1 (dedicated)	yes (dedicated)	yes (dedicated)	yes (dedicated)	yes (dedicated)	1	yes

Dwelling no.	Individual pool		Individual spa		Appliances & other efficiency measures							
	Pool heating system	Timer	Spa heating system	Timer	Kitchen cooktop/oven	Refrigerator	Well ventilated fridge space	Dishwasher	Clothes washer	Clothes dryer	Indoor or sheltered clothes drying line	Private outdoor or unsheltered clothes drying line
All dwellings	-	-	-	-	gas cooktop & electric oven	-	yes	-	-	-	no	no

Alternative energy	
Dwelling no.	Photovoltaic system (min rated electrical output in peak kW)
All dwellings	5.0

(iii) Thermal Comfort	Show on DA plans	Show on CC/CDC plans & specs	Certifier check
(a) The applicant must attach the certificate referred to under "Assessor details" on the front page of this BASIX certificate (the "Assessor Certificate") to the development application and construction certificate application for the proposed development (or, if the applicant is applying for a complying development certificate for the proposed development, to that application). The applicant must also attach the Assessor Certificate to the application for a final occupation certificate for the proposed development.			
(b) The Assessor Certificate must have been issued by an Accredited Assessor in accordance with the Thermal Comfort Protocol.			
(c) The details of the proposed development on the Assessor Certificate must be consistent with the details shown in this BASIX Certificate, including the details shown in the "Thermal Loads" table below.			

(iii) Thermal Comfort	Show on DA plans	Show on CC/CDC plans & specs	Certifier check
(d) The applicant must show on the plans accompanying the development application for the proposed development, all matters which the Thermal Comfort Protocol requires to be shown on those plans. Those plans must bear a stamp of endorsement from the Accredited Assessor, to certify that this is the case.	✓		
(e) The applicant must show on the plans accompanying the application for a construction certificate (or complying development certificate, if applicable), all thermal performance specifications set out in the Assessor Certificate, and all aspects of the proposed development which were used to calculate those specifications.		✓	
(f) The applicant must construct the development in accordance with all thermal performance specifications set out in the Assessor Certificate, and in accordance with those aspects of the development application or application for a complying development certificate which were used to calculate those specifications.		✓	✓
(g) Where there is an in-slab heating or cooling system, the applicant must:  (aa) Install insulation with an R-value of not less than 1.0 around the vertical edges of the perimeter of the slab; or (bb) On a suspended floor, install insulation with an R-value of not less than 1.0 underneath the slab and around the vertical edges of the perimeter of the slab.	✓	✓	✓
(h) The applicant must construct the floors and walls of the development in accordance with the specifications listed in the table below.	✓	✓	✓

Thermal loads		
Dwelling no.	Area adjusted heating load (in mJ/m <sup>2</sup> /yr)	Area adjusted cooling load (in mJ/m <sup>2</sup> /yr)
1	72.5	27.6
All other dwellings	69.4	29.4

Construction of floors and walls					
Dwelling no.	Concrete slab on ground(m <sup>2</sup> )	Suspended floor with open subfloor (m <sup>2</sup> )	Suspended floor with enclosed subfloor (m <sup>2</sup> )	Suspended floor above garage (m <sup>2</sup> )	Primarily rammed earth or mudbrick walls
1	-	-	-	165	No
All other dwellings	165	-	-	-	No



### 3. Commitments for common areas and central systems/facilities for the development (non-building specific)

#### (b) Common areas and central systems/facilities

(i) Water	Show on DA plans	Show on CC/CDC plans & specs	Certifier check
(a) If, in carrying out the development, the applicant installs a showerhead, toilet, tap or clothes washer into a common area, then that item must meet the specifications listed for it in the table.		✓	✓
(b) The applicant must install (or ensure that the development is serviced by) the alternative water supply system(s) specified in the "Central systems" column of the table below. In each case, the system must be sized, be configured, and be connected, as specified in the table.	✓	✓	✓
(c) A swimming pool or spa listed in the table must not have a volume (in kLs) greater than that specified for the pool or spa in the table.	✓	✓	
(d) A pool or spa listed in the table must have a cover or shading if specified for the pool or spa in the table.		✓	
(e) The applicant must install each fire sprinkler system listed in the table so that the system is configured as specified in the table.		✓	✓
(f) The applicant must ensure that the central cooling system for a cooling tower is configured as specified in the table.		✓	✓

Common area	Showerheads rating	Toilets rating	Taps rating	Clothes washers rating
All common areas	3 star (> 4.5 but ≤ 6 L/min)	4 star	5 star	no common laundry facility

Central systems	Size	Configuration	Connection (to allow for...)
Central water tank - rainwater or stormwater (No. 1)	4000.0	To collect run-off from at least: - 200.0 square metres of roof area of buildings in the development	- irrigation of 200.0 square metres of common landscaped area on the site
Pool (No. 1)	Volume: 42.0 kLs	Location: Other Pool shaded: no	-
Spa (No. 1)	Volume: 6.0 kLs	Location: Other Spa shaded: no Spa cover: yes	-

(ii) Energy	Show on DA plans	Show on CC/CDC plans & specs	Certifier check
(a) If, in carrying out the development, the applicant installs a ventilation system to service a common area specified in the table below, then that ventilation system must be of the type specified for that common area, and must meet the efficiency measure specified.		✓	✓
(b) In carrying out the development, the applicant must install, as the "primary type of artificial lighting" for each common area specified in the table below, the lighting specified for that common area. This lighting must meet the efficiency measure specified. The applicant must also install a centralised lighting control system or Building Management System (BMS) for the common area, where specified.		✓	✓
(c) The applicant must install the systems and fixtures specified in the "Central energy systems" column of the table below. In each case, the system or fixture must be of the type, and meet the specifications, listed for it in the table.	✓	✓	✓

Common area	Common area ventilation system		Common area lighting		
	Ventilation system type	Ventilation efficiency measure	Primary type of artificial lighting	Lighting efficiency measure	Lighting control system/BMS
Car park area (No. 1)	no mechanical ventilation	-	fluorescent	motion sensors	No
Lift car (No.1)	-	-	light-emitting diode	connected to lift call button	No
Garbage room (No. 1)	ventilation exhaust only	-	fluorescent	motion sensors	No
Plant or service room (No. 1)	no mechanical ventilation	-	fluorescent	motion sensors	No

Central energy systems	Type	Specification
Lift (No. 1)	gearless traction with V V V F motor	Number of levels (including basement): 3
Pool (No. 1)	Heating source: no heating	Pump controlled by timer: yes
Spa (No. 1)	Heating system: gas	Pump controlled by timer: yes



## Notes

1. In these commitments, "applicant" means the person carrying out the development.
2. The applicant must identify each dwelling, building and common area listed in this certificate, on the plans accompanying any development application, and on the plans and specifications accompanying the application for a construction certificate / complying development certificate, for the proposed development, using the same identifying letter or reference as is given to that dwelling, building or common area in this certificate.
3. This note applies if the proposed development involves the erection of a building for both residential and non-residential purposes (or the change of use of a building for both residential and non-residential purposes). Commitments in this certificate which are specified to apply to a "common area" of a building or the development, apply only to that part of the building or development to be used for residential purposes.
4. If this certificate lists a central system as a commitment for a dwelling or building, and that system will also service any other dwelling or building within the development, then that system need only be installed once (even if it is separately listed as a commitment for that other dwelling or building).
5. If a star or other rating is specified in a commitment, this is a minimum rating.
6. All alternative water systems to be installed under these commitments (if any), must be installed in accordance with the requirements of all applicable regulatory authorities. NOTE: NSW Health does not recommend that stormwater, recycled water or private dam water be used to irrigate edible plants which are consumed raw, or that rainwater be used for human consumption in areas with potable water supply.

## Legend

1. Commitments identified with a "✓" in the "Show on DA plans" column must be shown on the plans accompanying the development application for the proposed development (if a development application is to be lodged for the proposed development).
2. Commitments identified with a "✓" in the "Show on CC/CDC plans and specs" column must be shown in the plans and specifications accompanying the application for a construction certificate / complying development certificate for the proposed development.
3. Commitments identified with a "✓" in the "Certifier check" column must be certified by a certifying authority as having been fulfilled. (Note: a certifying authority must not issue an occupation certificate (either interim or final) for a building listed in this certificate, or for any part of such a building, unless it is satisfied that each of the commitments whose fulfilment it is required to monitor in relation to the building or part, has been fulfilled).