



PROPOSED DUAL OCCUPANCY DEVELOPMENT

4 WOLLONGONG STREET, SHELLHARBOUR - LOT 1 | D.P 21994 PREPARED FOR SHELLHARBOUR CITY COUNCIL

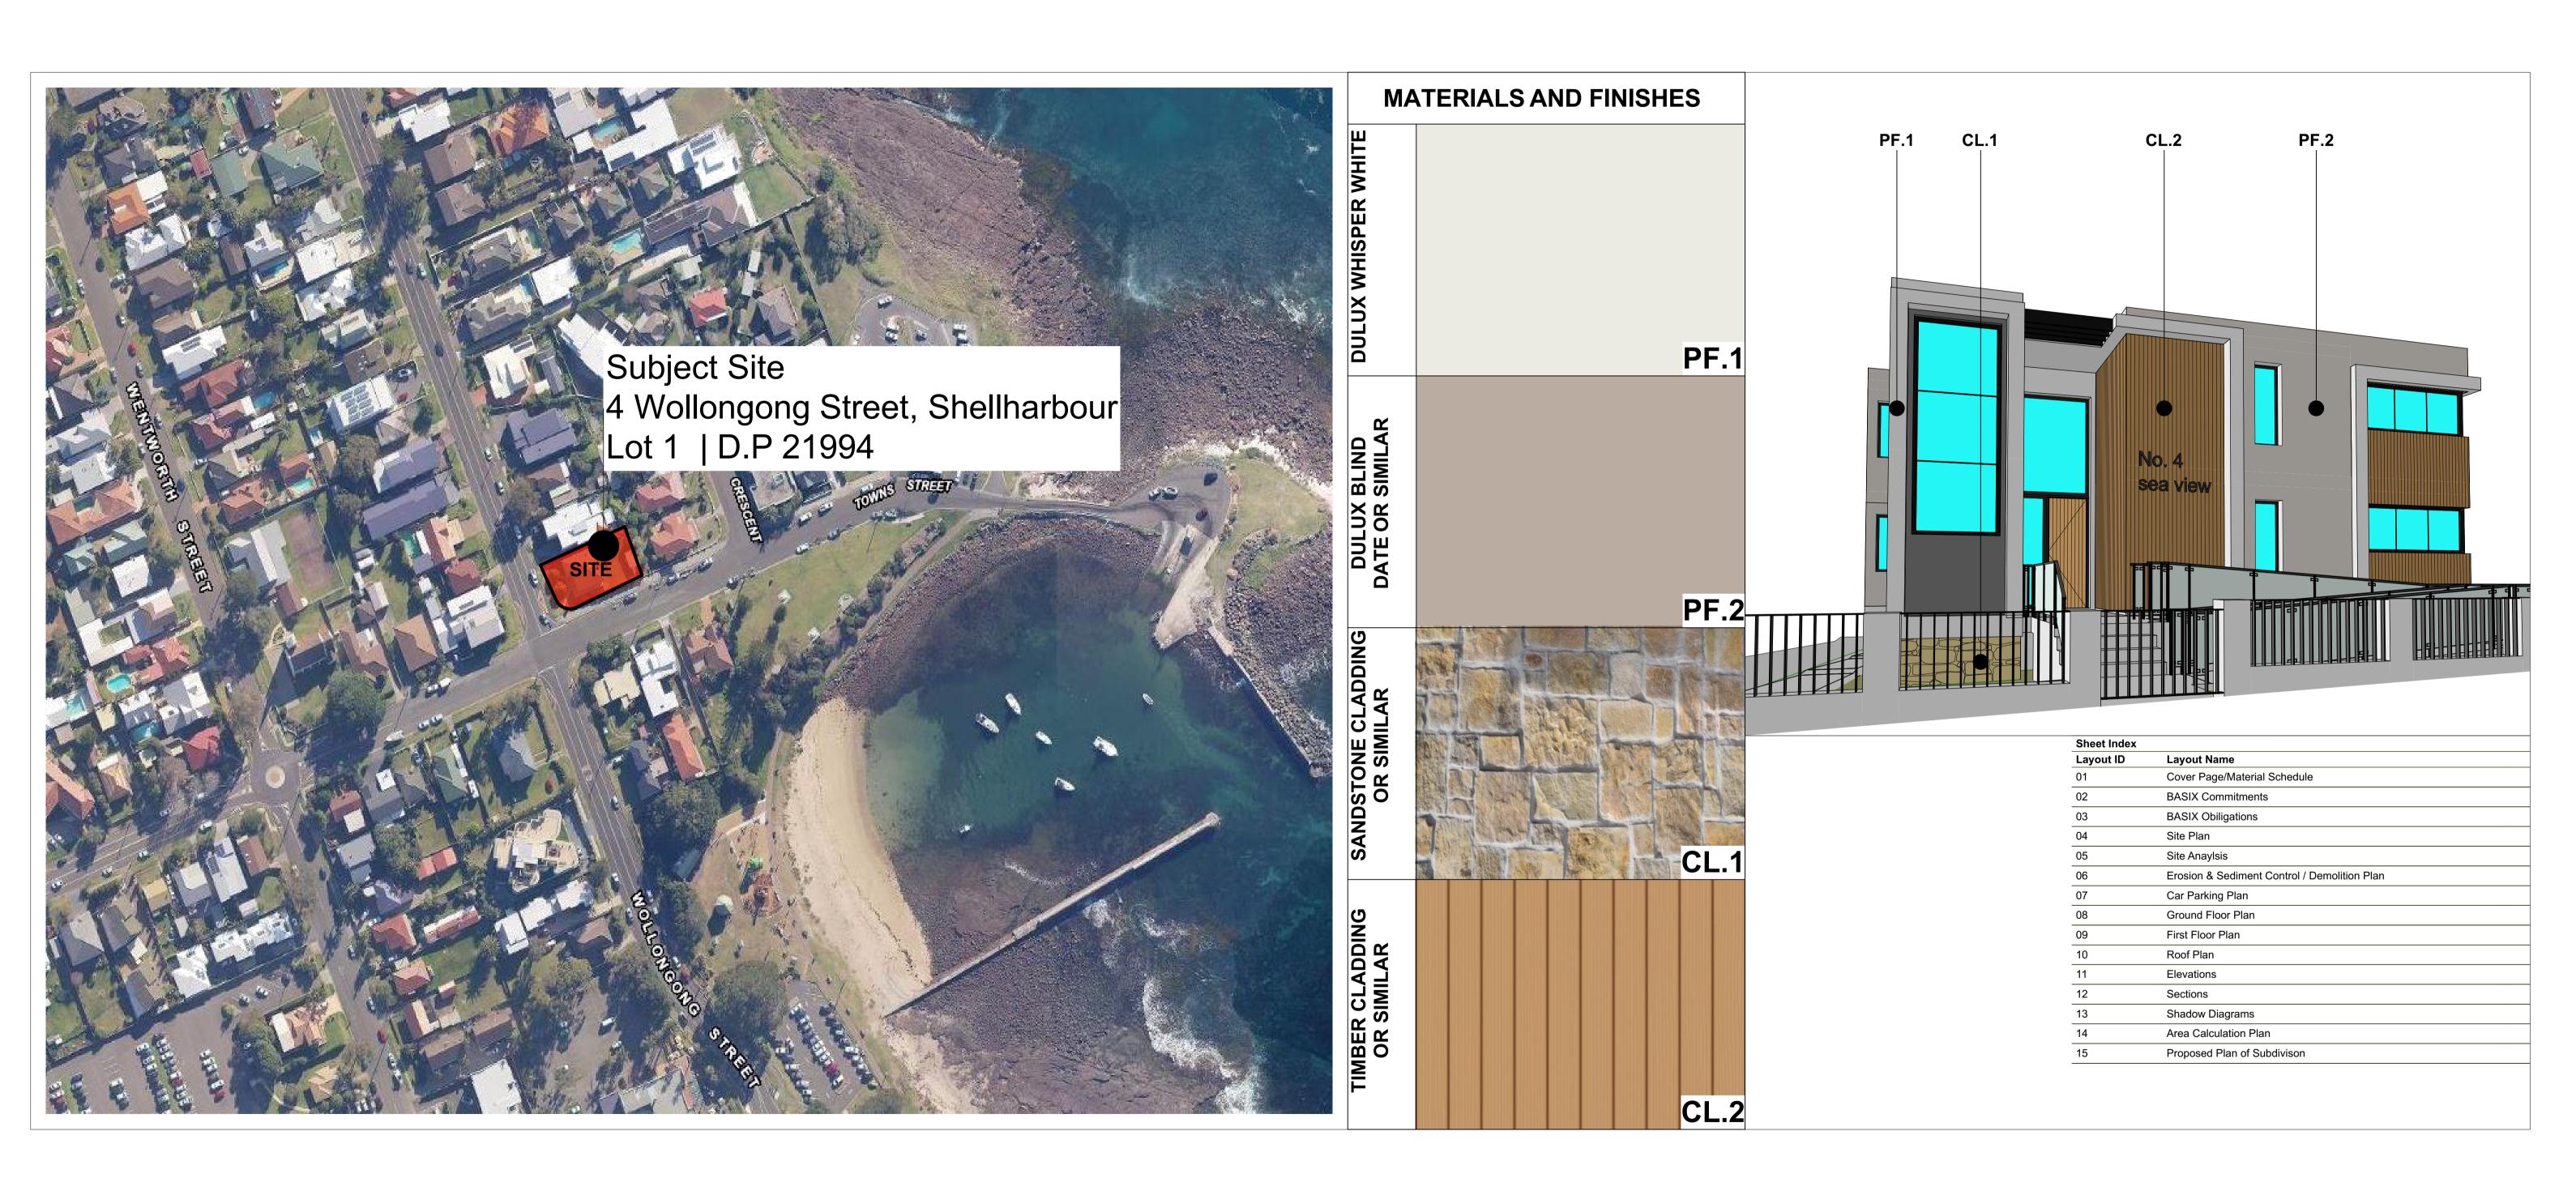

ISSUE DESCRIPTION	DATE NOTES		γ LTD	DRAWING TITLE	SCALE	NORTH _	
A ISSUE FOR DEVELOPMENT APPLICATION LODGEMENT	05/06/20		A PT			/V	Proposed Dual Occupancy
ISSUE FOR DEVELOPMENT APPLICATION LODGEMENT	16/10/20		IRAL	Cover Page/Material Schedule			•
REVISED FOR APPROVAL	29/01/21 The plans, drawings and specification	ons incorporated in this document shall remain the	DESIGN LINK AUSTRALIA PTY LTD				4 Wollongong Street, Shellharbour
REVISED FOR APPROVAL	copyright © of DESIGN LINK AUSTF copied wholly or in part without prior	RALIA PTY LTD and must not be used, reproduced or r written consent of DESIGN LINK AUSTRALIA PTY LTD.	a Suite 1, Level 5, 410 Church St, Parramatta, NSW 2150	DRAWING NO	1:100 @ A1 or 1:200 @ A3		
	Figured dimensions shall verify all dimensions on si	take preference over scaling.	p PO BOX 3085 North Strathfield NSW 2137 p 02 9744 3116 e info@design-link.com.au	DA01	0 0.5 1.0 2.0m		JOB No. DATE DRAWN CHECKED SCALE 01820_DA 29/01/2021 J.D A.M As Shown or

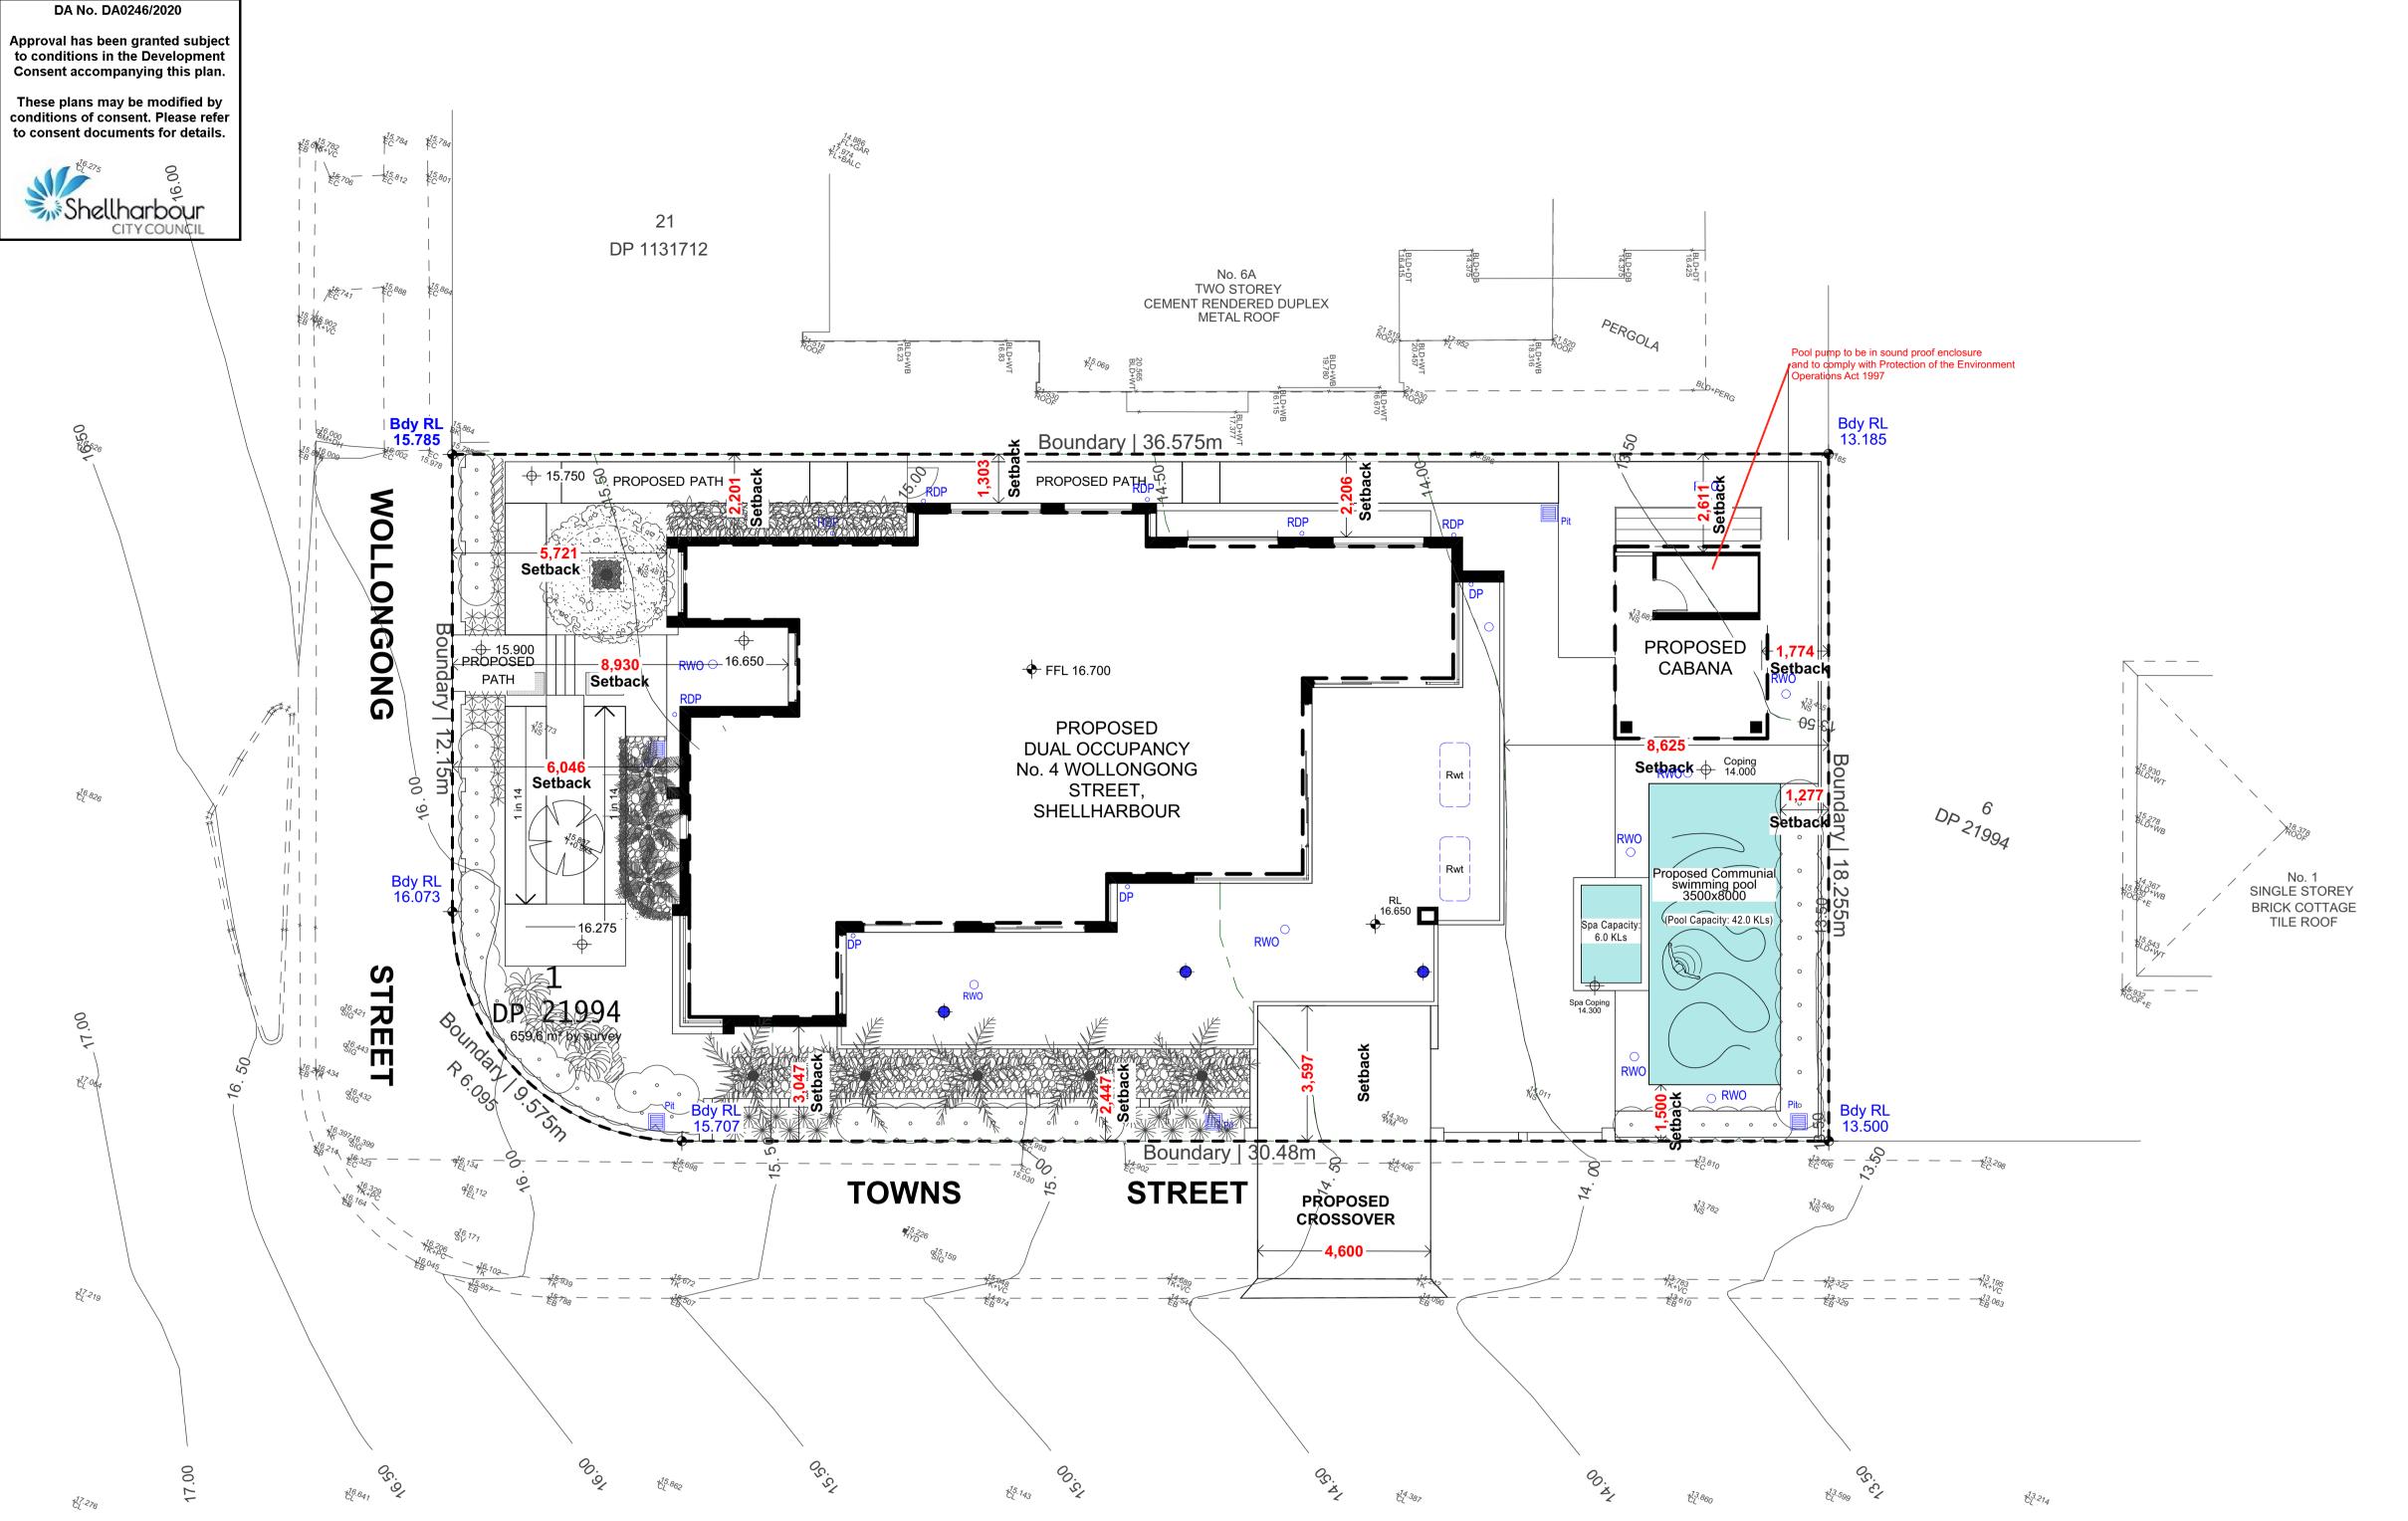

DEVELOPMENT SUMMARY

PROJECT: PROPOSED DUAL OCCUPANCY **SITE:** 4 WOLLONGONG STREET, SHELLHARBOUR LOT 1 | D.P 21994


SITE AREA: 659.6 m² (By Calc.)

NUMERICAL CONTROL:	PROPOSED
Ground GFA First GFA	164.58 m ² 164.58 m ²
Total GFA	329.16 m ²
FSR 0.5:1	0.50:1
LANDSCAPE AREA	162.64m ²
PRIVATE OPEN SPACE	LOT 1 , 82.67 m ² LOT 2 , 67.14 m ²


Site Plan


1:100

ISSUE DESCRIPTION	DATE NOTES	DRAWING TITLE	SCALE	NORTH
A ISSUE FOR DEVELOPMENT APPLICATION LODGEMENT	05/06/20	₹ E		Proposed Dual Occupancy
B ISSUE FOR DEVELOPMENT APPLICATION LODGEMENT	16/10/20	Site Plan		
C REVISED FOR APPROVAL	29/01/21 The plans, drawings and specifications incorporated in this document shall remain the	DESIGN LINK AUSTRALIA PTY LTD a Suite 1, Level 5, 410 Church St, Parramatta, NSW 2150 p PO BOX 3085 North Strathfield NSW 2137 DAGA STEP TATE DRAWING NO DAGA DAGA		4 Wollongong Street, Shellharbour
D REVISED FOR APPROVAL	29/01/21 copied wholly or in part without prior written consent of DESIGN LINK AUSTRALIA PTY LTD.	a Suite 1, Level 5, 410 Church St, Parramatta, NSW 2150	1:100 @ A1 or 1:200 @ A3	
	Figured dimensions shall take preference over scaling. Verify all dimensions on site	p PO BOX 3085 North Strathfield NSW 2137 p 02 9744 3116 e info@design-link.com.au	0 0.5 1.0 2.0m	JOB No. DATE DRAWN CHECKED SCALE 01820_DA 29/01/2021 J.D A.M As Shown on A1

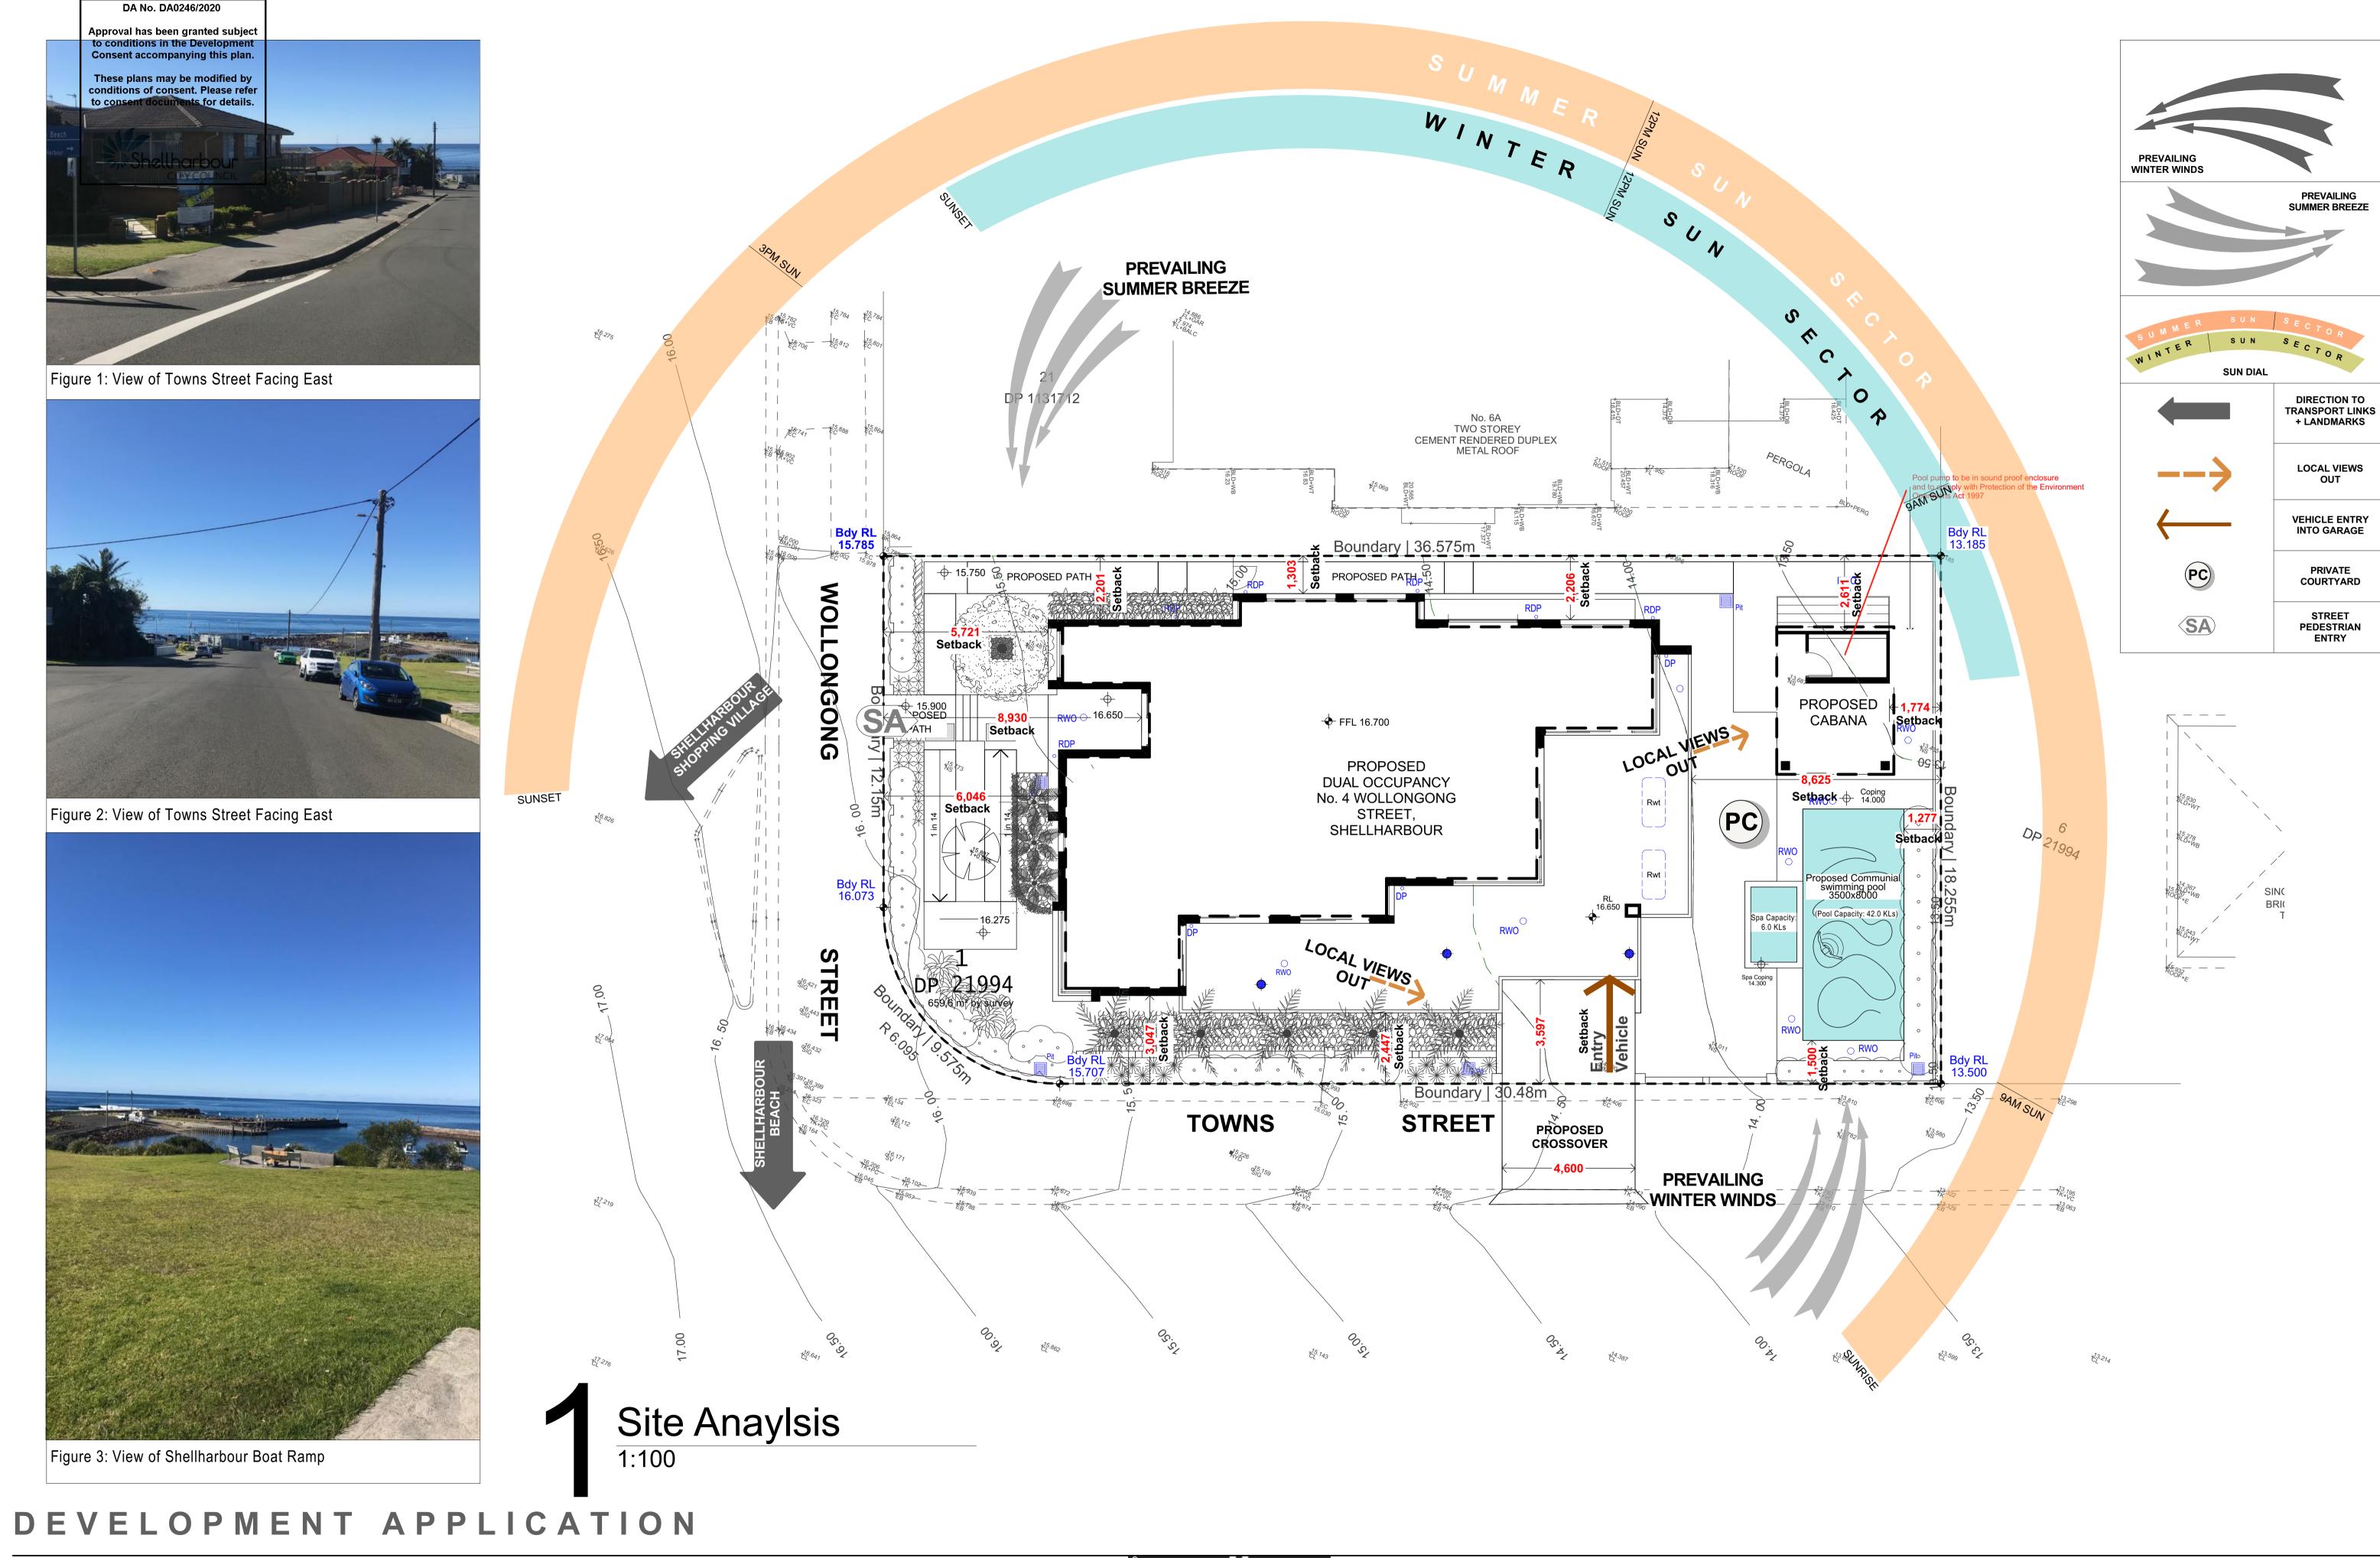

A	DESCRIPTION ISSUE FOR DEVELOPMENT APPLICATION LODGEMENT	05/06/20	NOTES	IA PTY L		DRAWING TITLE	SCALE	NORTH	N	Proposed Du	al Occur	nancy
В	ISSUE FOR DEVELOPMENT APPLICATION LODGEMENT	16/10/20		TRAL		Site Anaylsis			─ / I		_	
С	REVISED FOR APPROVAL	29/01/21	The plans, drawings and specifications incorporated in this document shall remain the	DESIGN LINK AUSTRALIA PTY LTD		DRAWING NO			⊿	Vollongong Str	reet, Sne	linarbour
D	REVISED FOR APPROVAL	29/01/21	copyright © of DESIGN LINK AUSTRALIA PTY LTD and must not be used, reproduced of copied wholly or in part without prior written consent of DESIGN LINK AUSTRALIA PTY LTD.	a Suite 1, Level 5, 410 Church St, Parramatta, NSW 2150			1:100 @ A1 or 1:200 @ A3		IOD No.	DATE	DDAMAN	OLIFOKED COM E
			Figured dimensions shall take preference over scaling. Verify all dimensions on site	p PO BOX 3085 North Strathfield NSW 2137 p 02 9744 3116 e info@design-link.com.au	<u>、</u> ノ	DA05	0 0.5 1.0 2.0m	X	JOB No. 01820_DA	29/01/2021	J.D	CHECKED SCALE A.M As Shown on A1

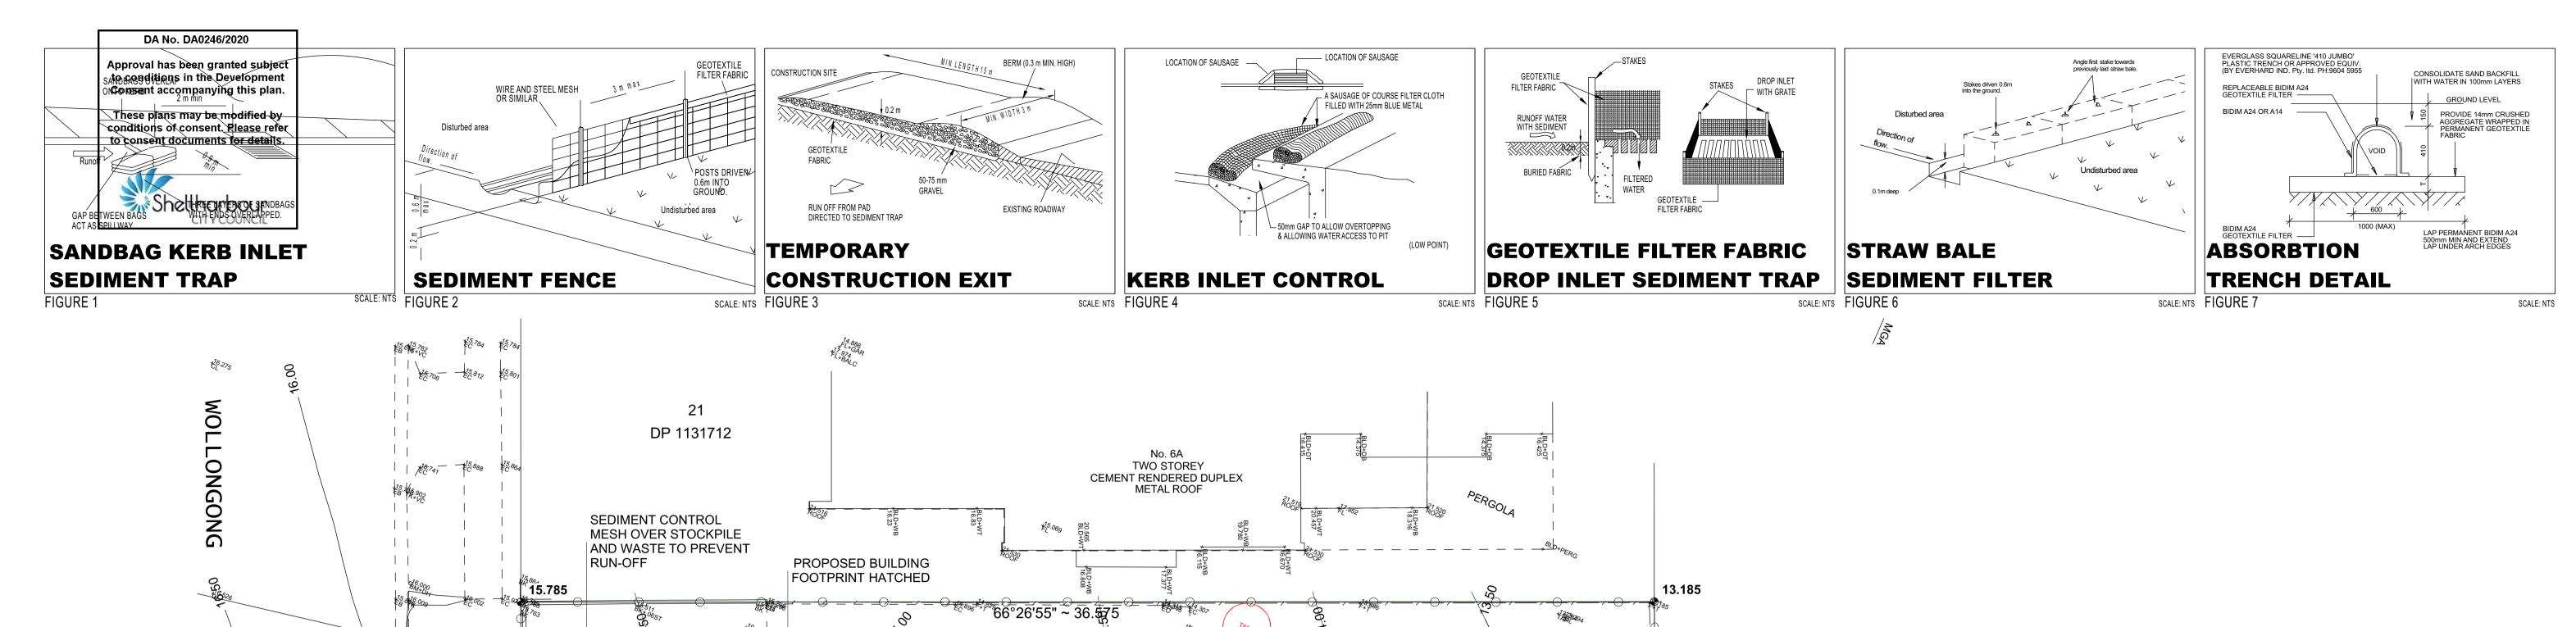

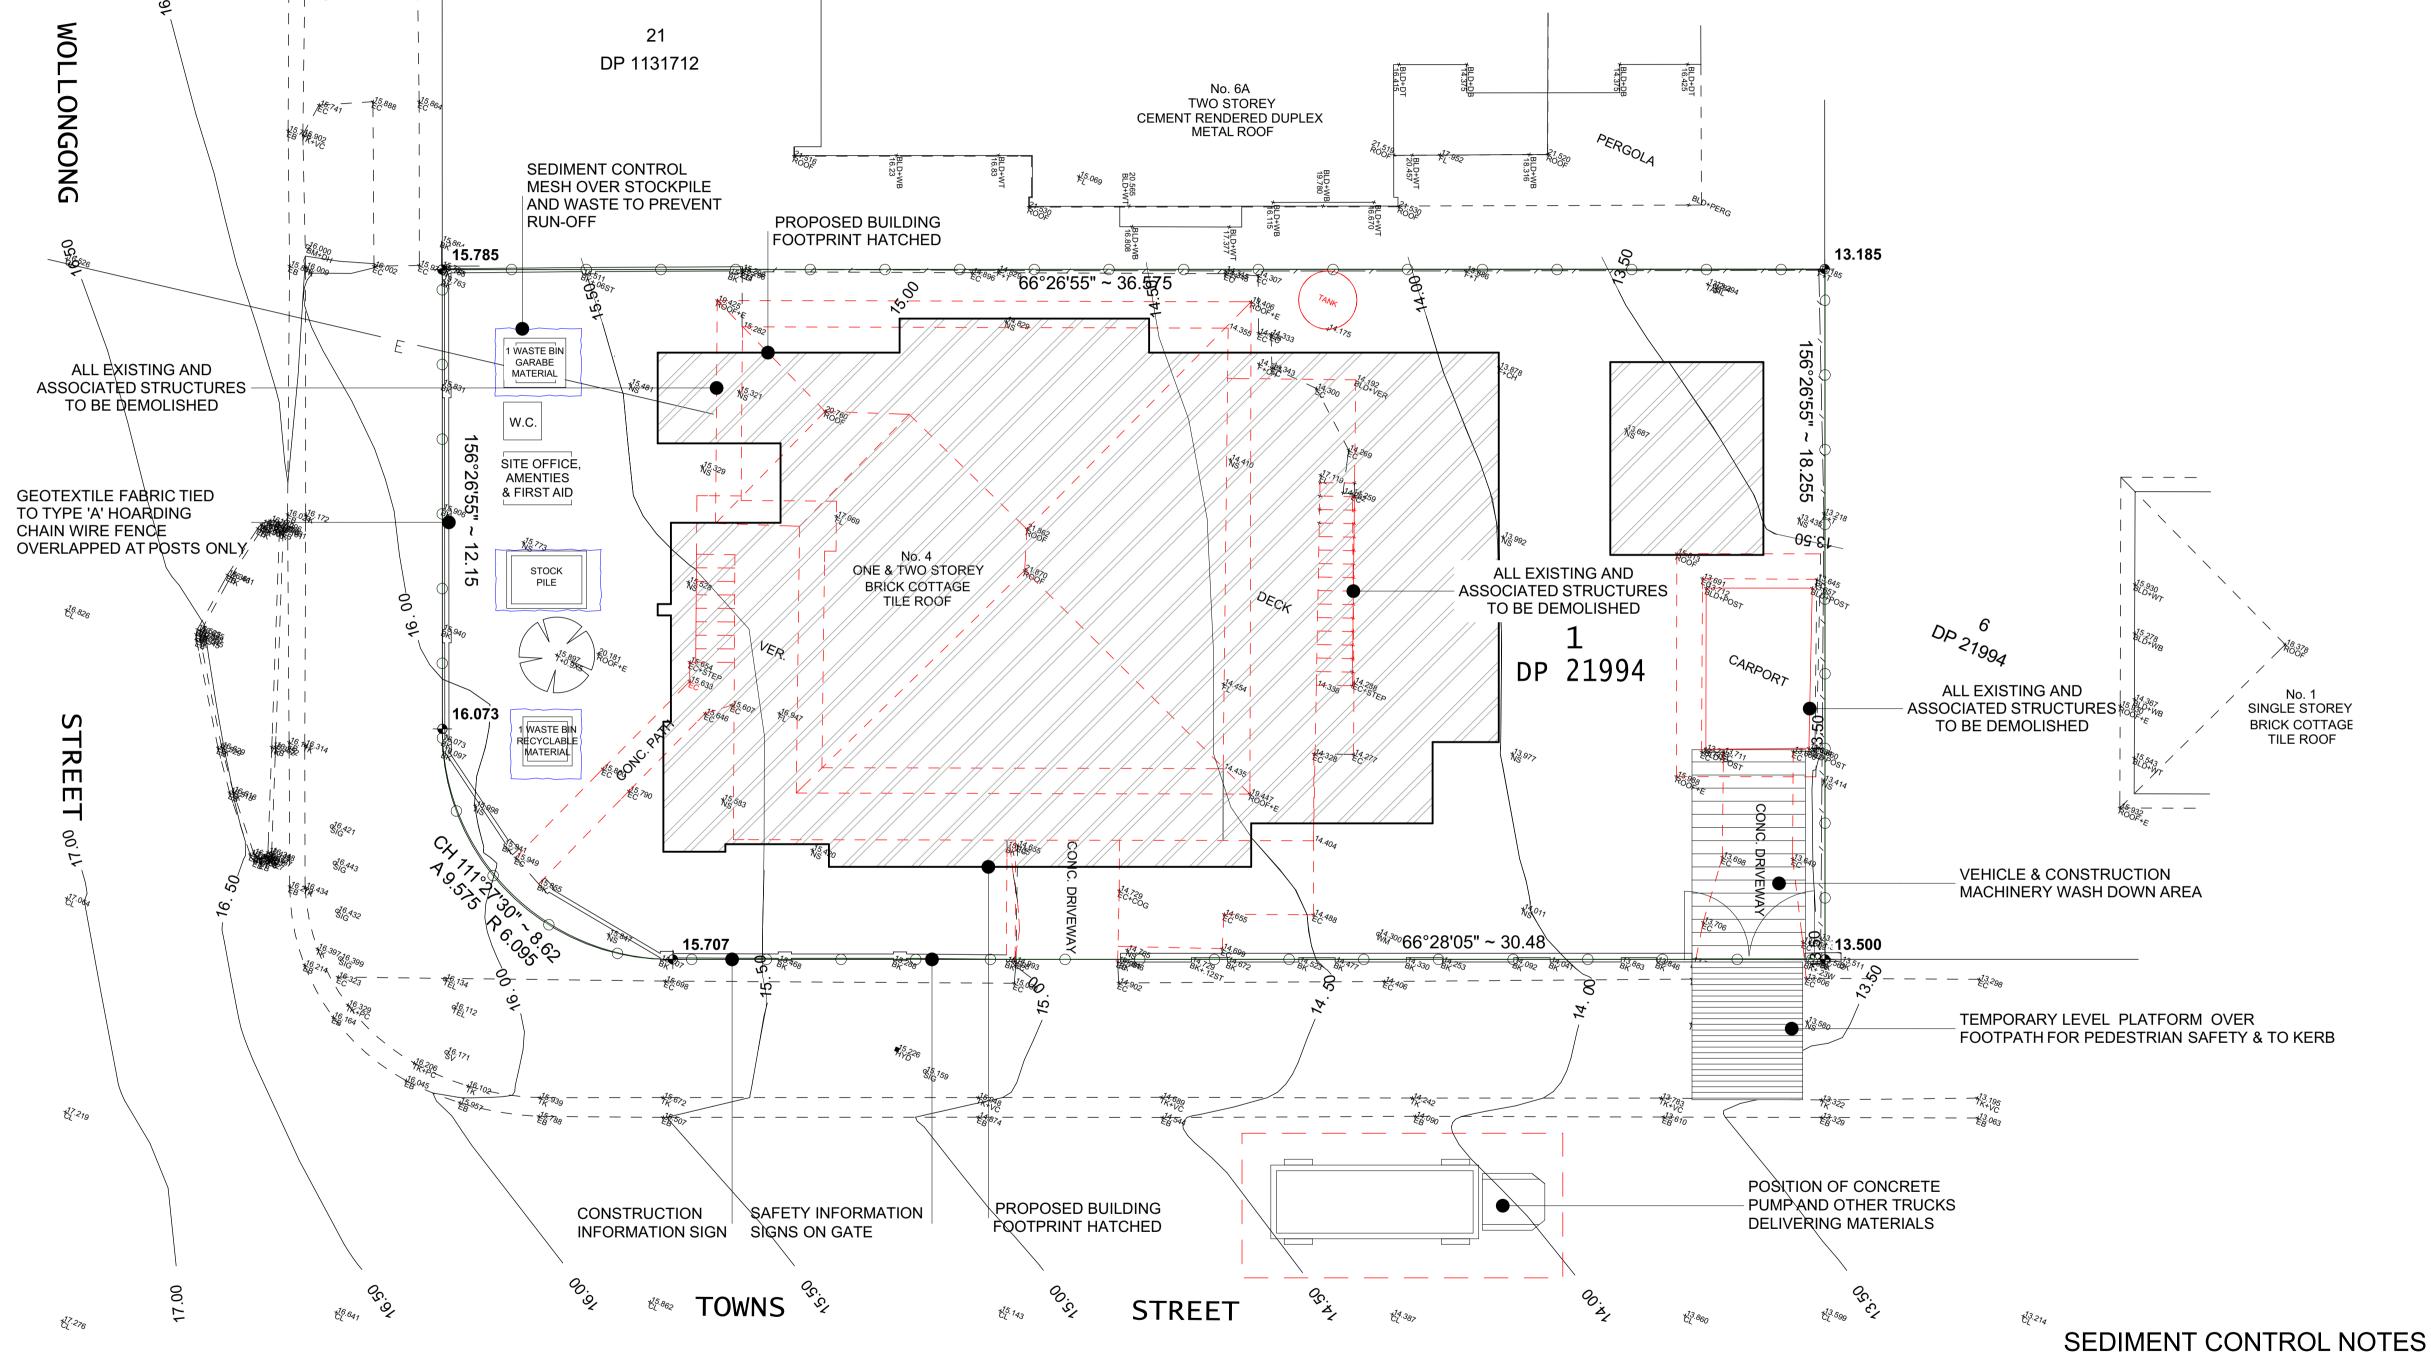




Soil & Water Management / Demoltion Plan

DEVELOPMENT APPLICATION

DATE | NOTES 05/06/20 ISSUE FOR DEVELOPMENT APPLICATION LODGEMENT ISSUE FOR DEVELOPMENT APPLICATION LODGEMENT 16/10/20 REVISED FOR APPROVAL The plans, drawings and specifications incorporated in this document shall remain the copyright © of DESIGN LINK AUSTRALIA PTY LTD and must not be used, reproduced or 29/01/21 REVISED FOR APPROVAL copied wholly or in part without prior written consent of DESIGN LINK AUSTRALIA PTY LTD. Figured dimensions shall take preference over scaling.

DESIGN LINK AUSTRALIA PTY LTD a Suite 1, Level 5, 410 Church St, Parramatta, NSW 2150 p PO BOX 3085 North Strathfield NSW 2137 **p** 02 9744 3116 **e** info@design-link.com.au

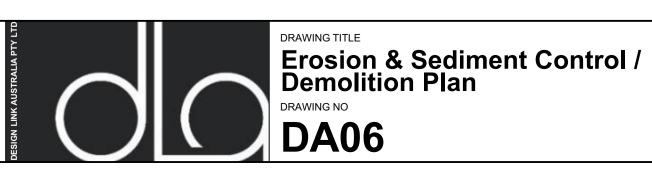

1:100 @ A1 or 1:200 @ A3

SCALE

of soil materials, including the maintenance period

4 Wollongong Street, Shellharbour

1. All erosion and sedimentation control measures , including revegetation and storage

5. All disturbed areas shall be revegetated as soon as the relevant works are completed

of soil and topsoil, shall be implemented to the standards of the soil conservation of NSW

2. All drainage works shall be constructed and stabilized as early as possible during development

4. All sediment basins and traps shall be cleaned when the structures are a maximum of 60% full

3. Sediment traps shall be constructed around all inlet pits , consisting of 300mm wide x 300mm deep trench.


6. Soil and topsoil stockpiles shall be located away from drainage lines and area where water may concentrate

7. Filter shall be constructed by stretching a filter fabric (propex) or approved equivalent between post at 3.0m centres. fabric shall be buried 150mm along its lower edge

Proposed Dual Occupancy

CHECKED SCALE As Shown on A1 01820 DA A.M



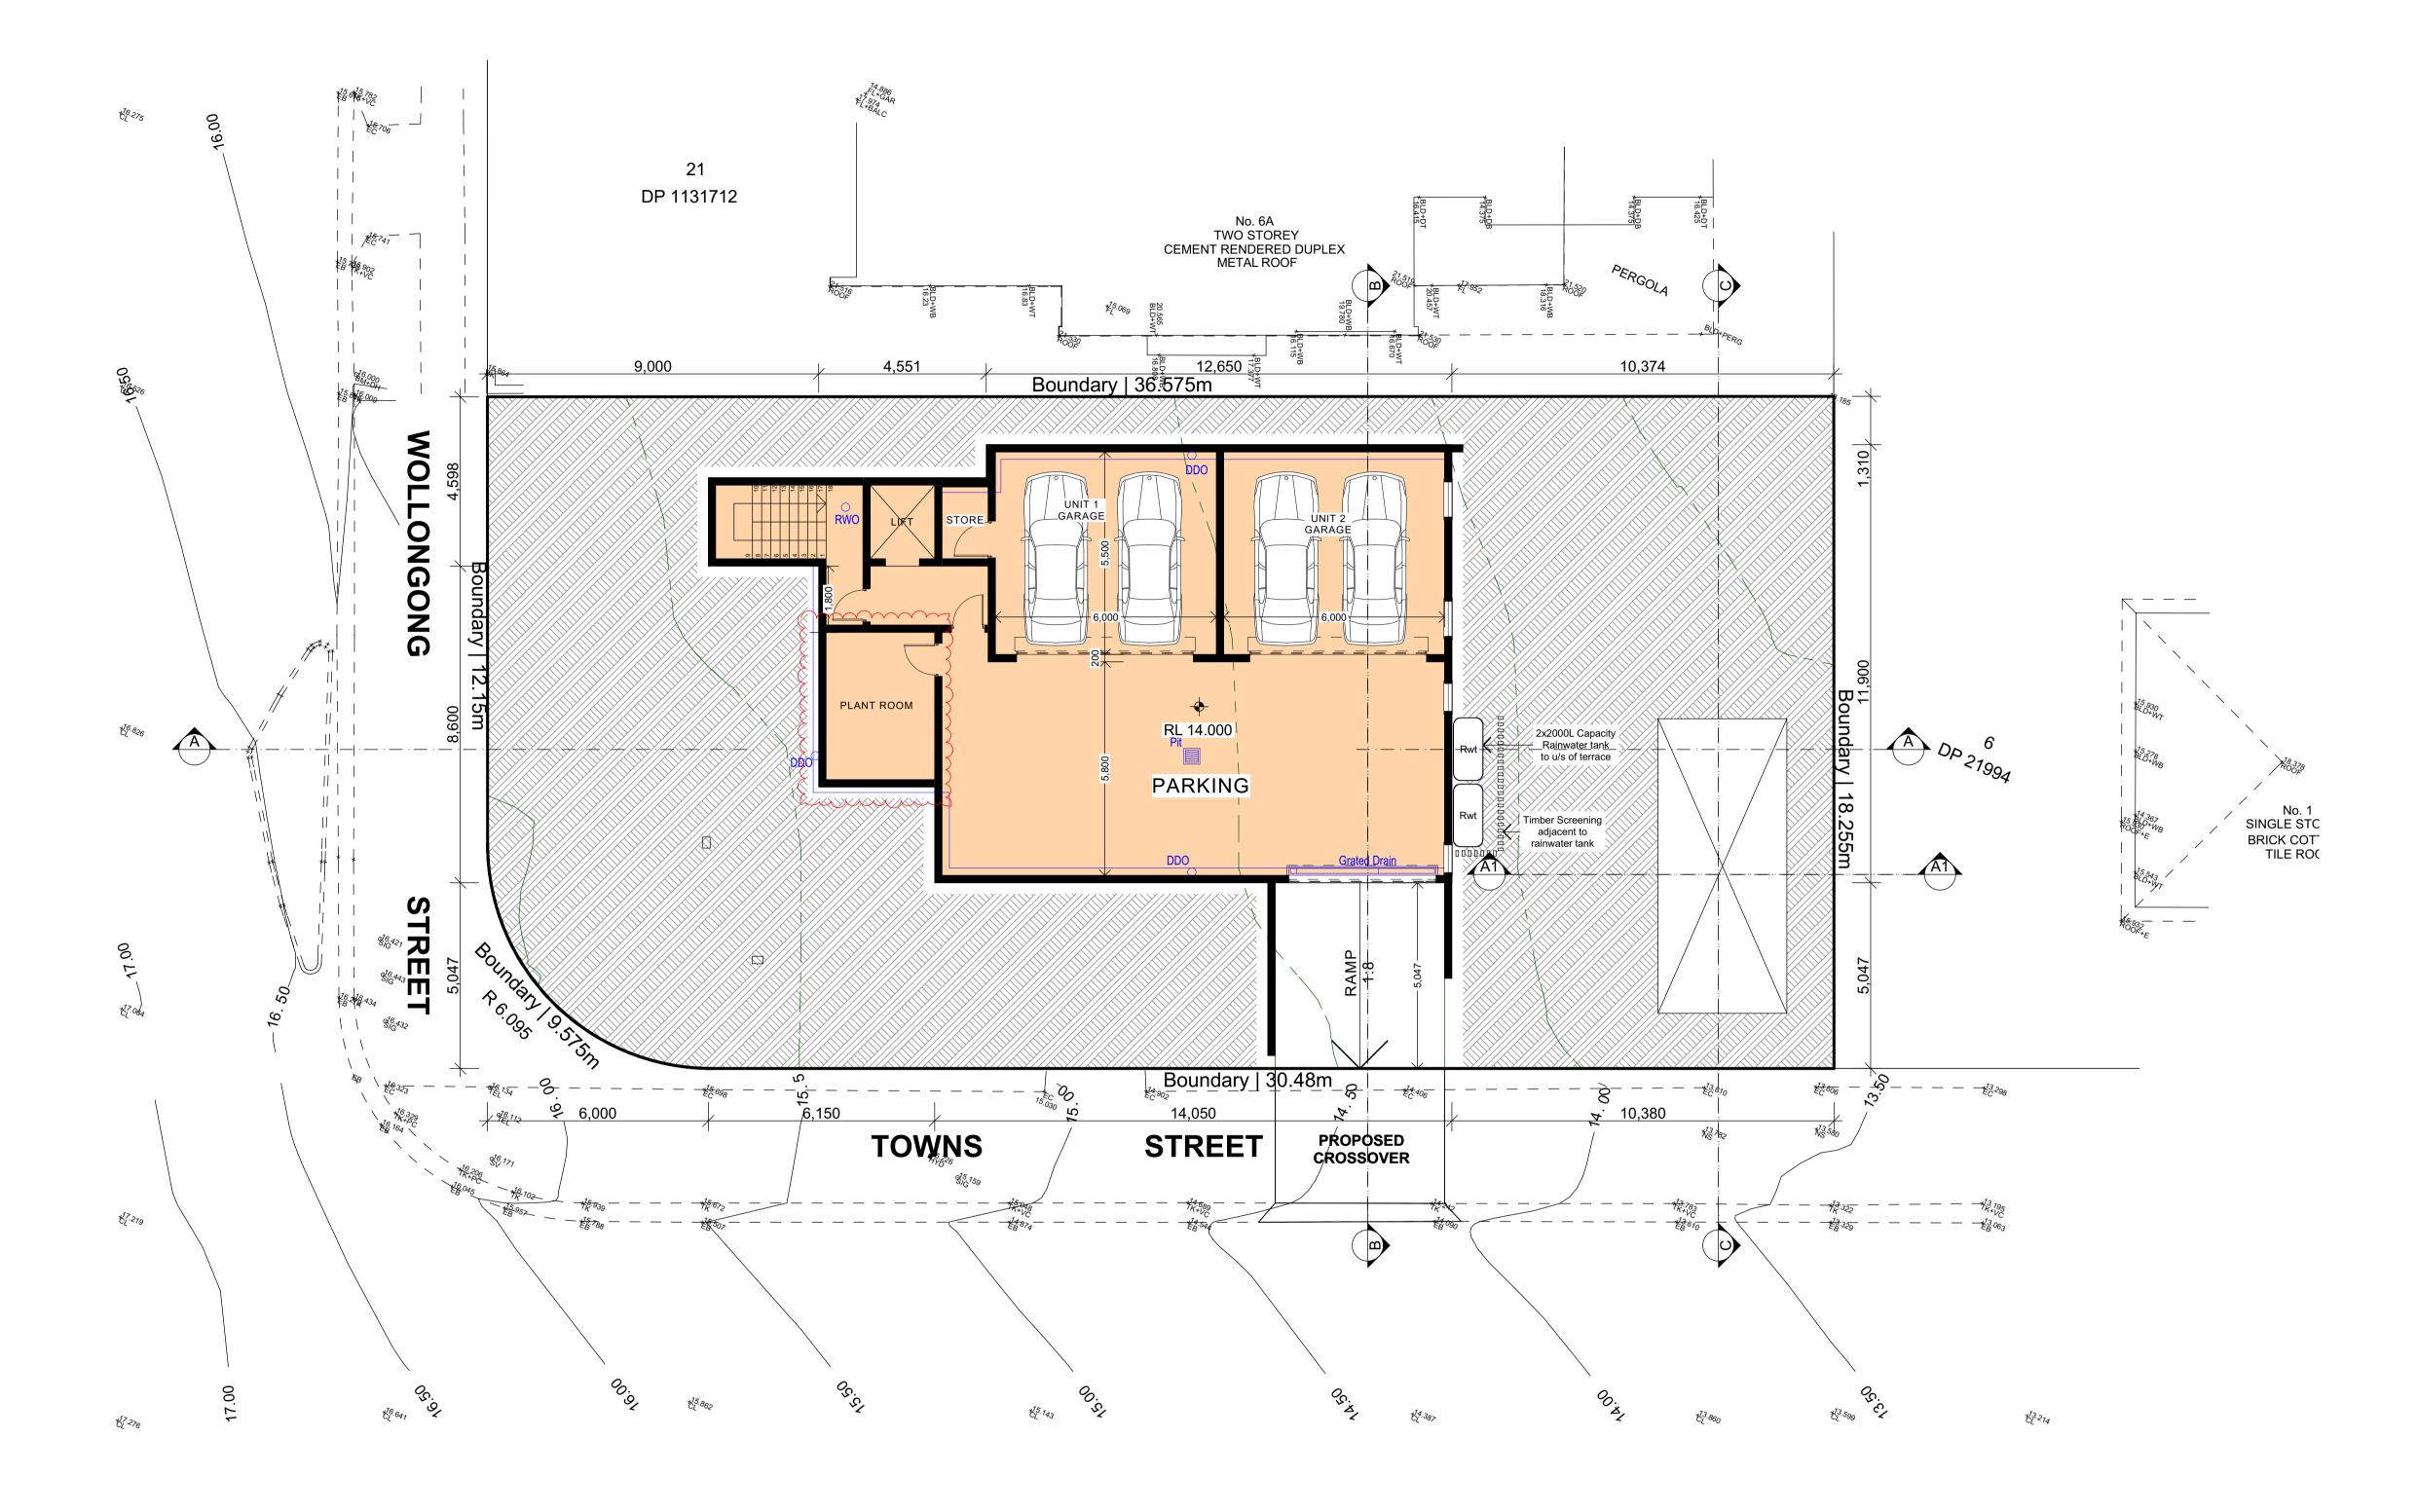


Car Parking Layout

1:100

SSUE DESCRIPTION	DATE NOTES	P DRAWING TITLE	SCALE	NORTH
ISSUE FOR DEVELOPMENT APPLICATION LODGEMENT	05/06/20	TA MANAGEMENT OF THE PROPERTY		Proposed Dual Occupancy
ISSUE FOR DEVELOPMENT APPLICATION LODGEMENT	16/10/20	Car Parking Plan		
REVISED FOR APPROVAL	29/01/21 The plans, drawings and specifications incorporated in this document shall remain the	DESIGN LINK AUSTRALIA PTY LTD		4 Wollongong Street, Shellharbour
REVISED FOR APPROVAL	copyright © of DESIGN LINK AUSTRALIA PTY LTD and must not be used, reproduced or copied wholly or in part without prior written consent of DESIGN LINK AUSTRALIA PTY LTD.	a Suite 1, Level 5, 410 Church St, Parramatta, NSW 2150	1:100 @ A1 or 1:200 @ A3	
	Figured dimensions shall take preference over scaling. Verify all dimensions on site	p PO BOX 3085 North Strathfield NSW 2137 p 02 9744 3116 e info@design-link.com.au	0 0.5 1.0 2.0m	JOB No. DATE DRAWN CHECKED SCALE 29/01/2021 J.D A.M AS Show



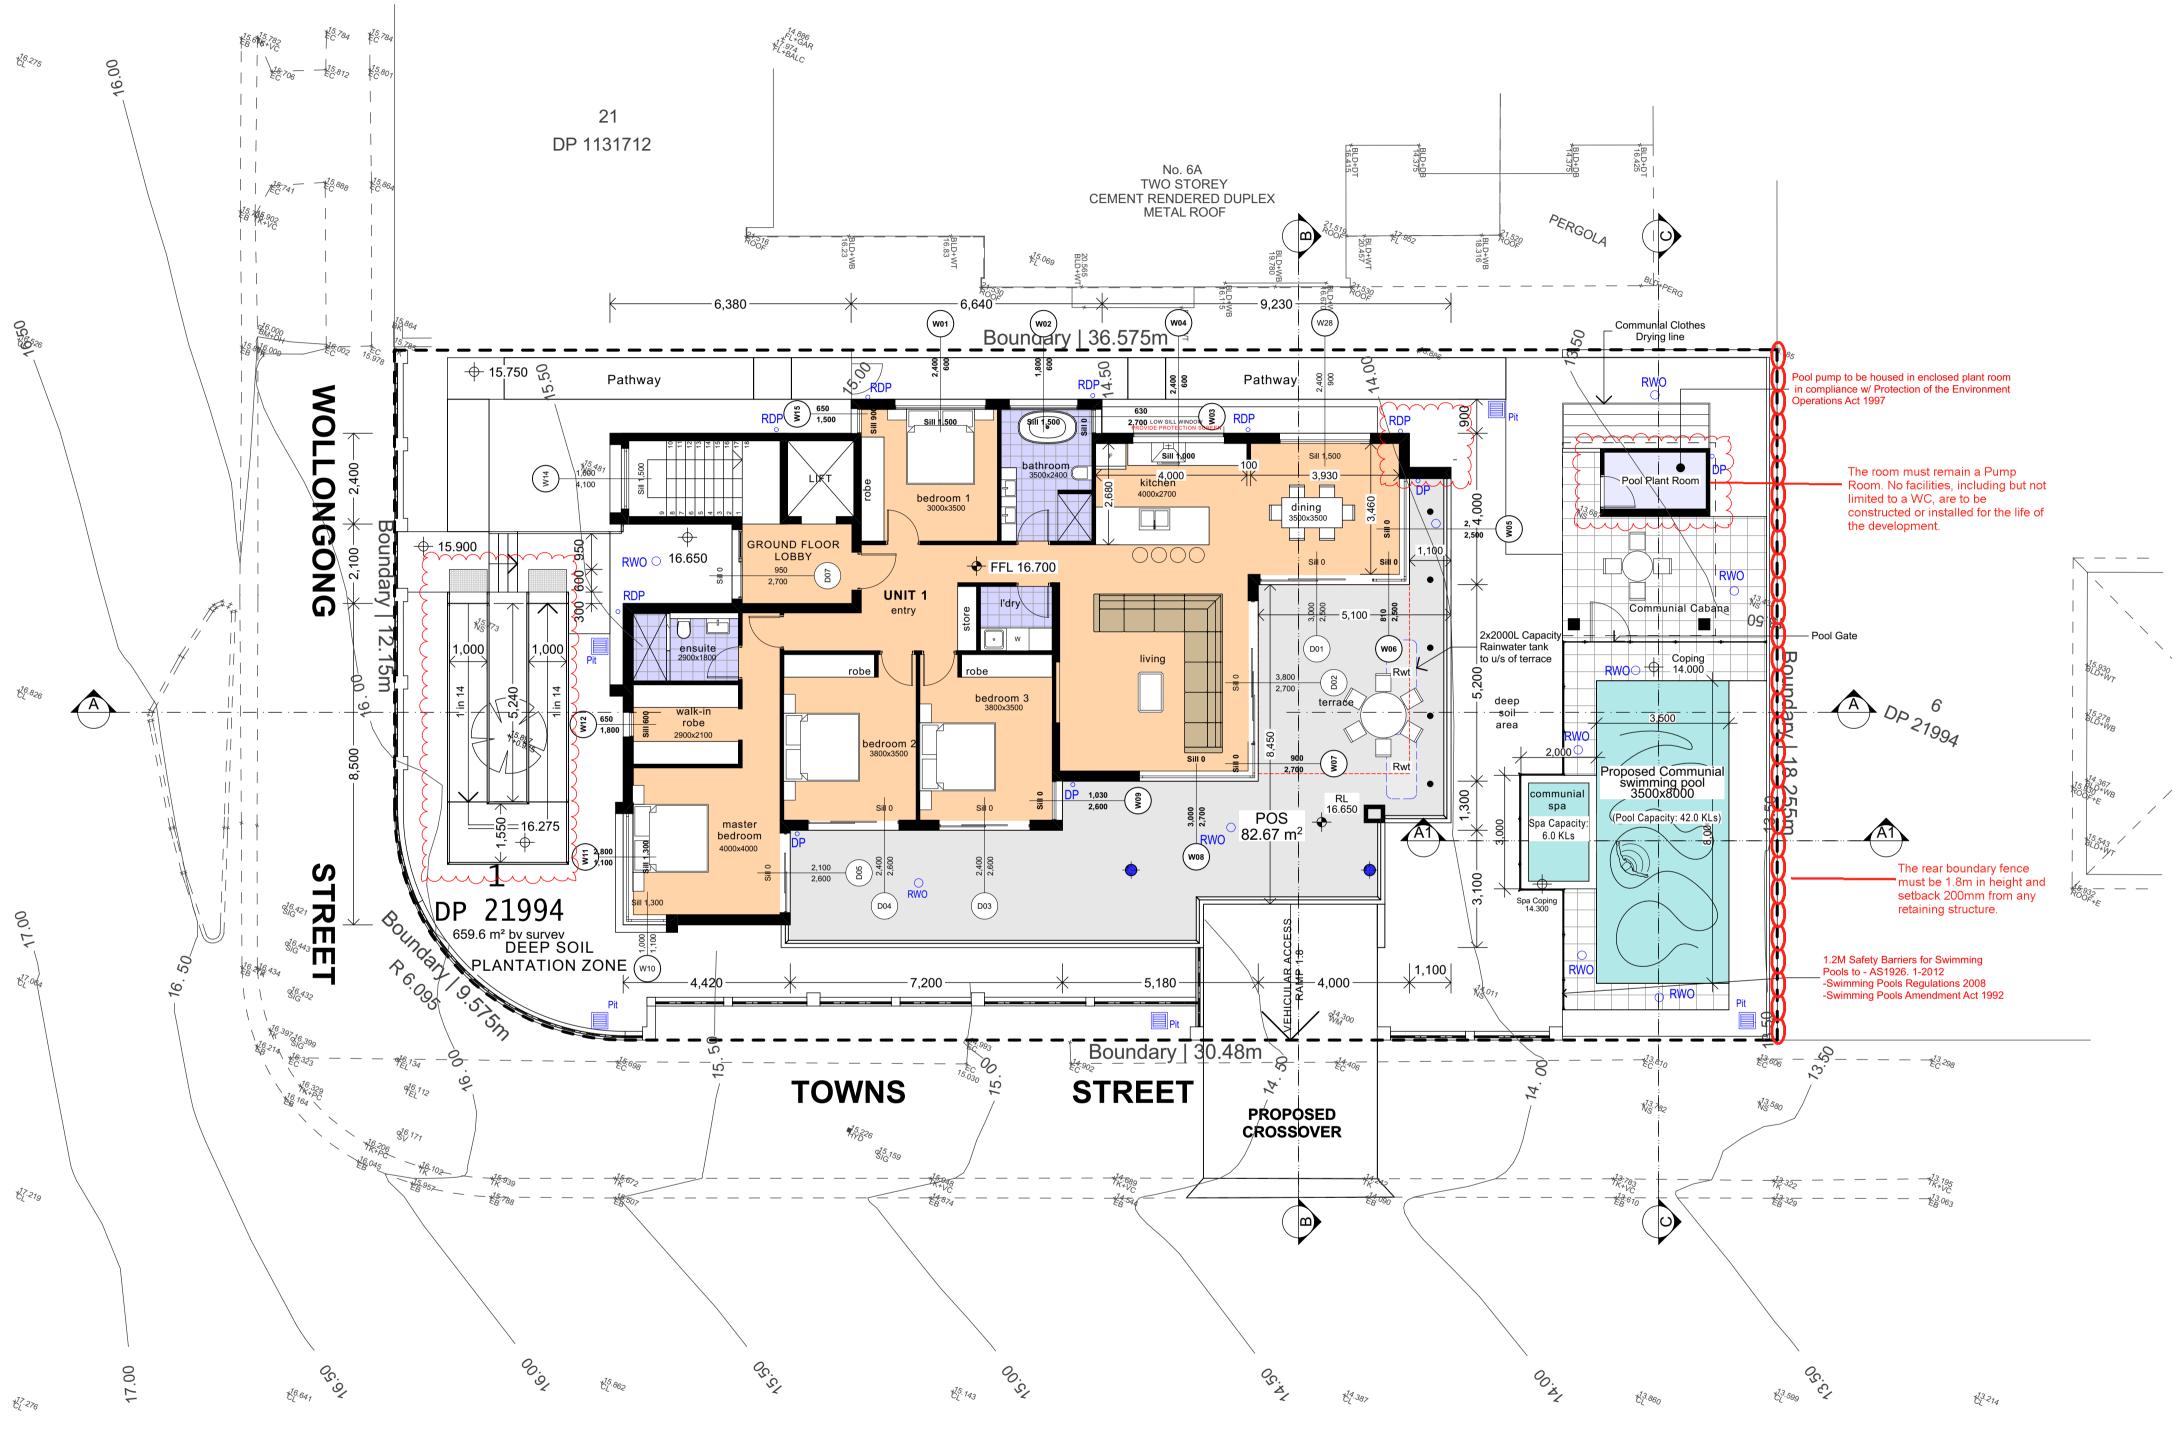


Ground Floor Plan

1:100

ISSUE DESCRIPTION	DATE	NOTES	DRAWING TITLE	SCALE	NORTH .
A ISSUE FOR DEVELOPMENT APPLICATION LODGEMENT	05/06/20		E ≤		Proposed Dual Occupancy
B ISSUE FOR DEVELOPMENT APPLICATION LODGEMENT	16/10/20		Ground Floor Plan		
C REVISED FOR APPROVAL	29/01/21	The plans, drawings and specifications incorporated in this document shall remain the	DESIGN LINK AUSTRALIA PTY LTD a Suite 1, Level 5, 410 Church St, Parramatta, NSW 2150 p PO BOX 3085 North Strathfield NSW 2137		4 Wollongong Street, Shellharbour
D REVISED FOR APPROVAL	29/01/21	copyright © of DESIGN LINK AUSTRALIA PTY LTD and must not be used, reproduced or copied wholly or in part without prior written consent of DESIGN LINK AUSTRALIA PTY LTD.	a Suite 1, Level 5, 410 Church St, Parramatta, NSW 2150	1:100 @ A1 or 1:200 @ A3	DODAL DATE DODAMAL CUECKED COALE
		Figured dimensions shall take preference over scaling. Verify all dimensions on site	p PO BOX 3085 North Strathfield NSW 2137 p 02 9744 3116 e info@design-link.com.au DA08	0 0.5 1.0 2.0m	JOB No. DATE DRAWN CHECKED SCALE 29/01/2021 J.D A.M As Shown on A1



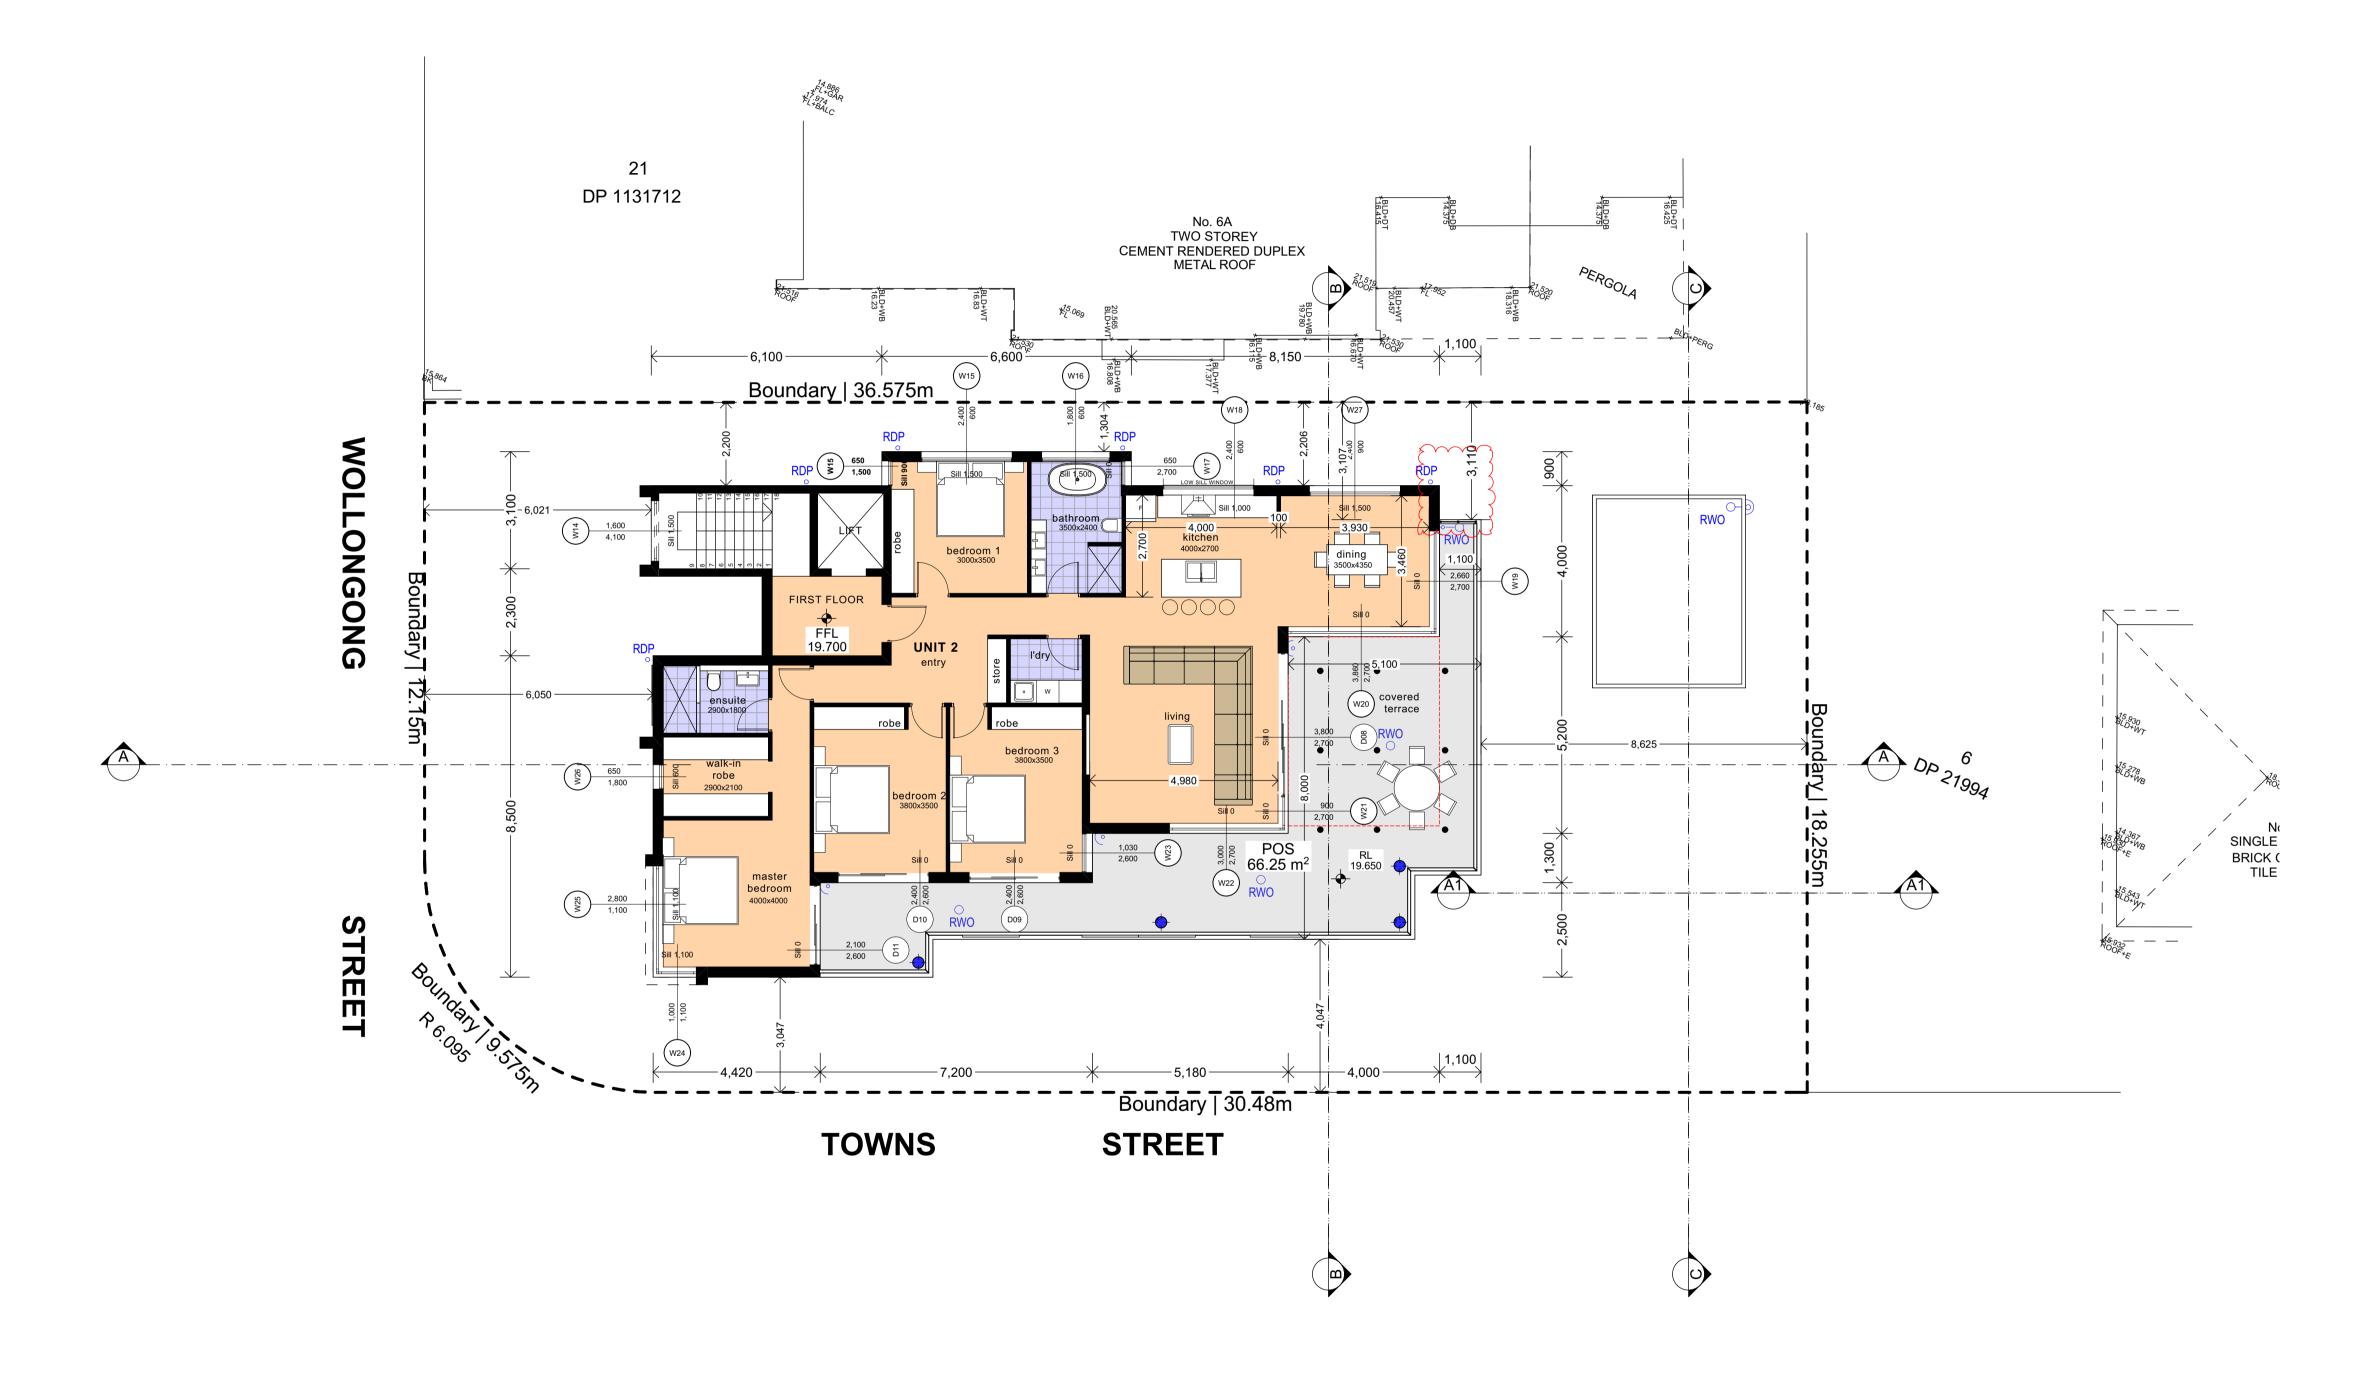


First Floor Plan

1:100

A B C D	DESCRIPTION ISSUE FOR DEVELOPMENT APPLICATION LODGEMENT ISSUE FOR DEVELOPMENT APPLICATION LODGEMENT REVISED FOR APPROVAL REVISED FOR APPROVAL	DATE 05/06/20 16/10/20 29/01/21 29/01/21	The plans, drawings and specifications incorporated in this document shall remain the copyright © of DESIGN LINK AUSTRALIA PTY LTD and must not be used, reproduced or copied wholly or in part without prior written consent of DESIGN LINK AUSTRALIA PTY LTD.	DESIGN LINK AUSTRALIA PTY LTD a Suite 1, Level 5, 410 Church St. Barramatta, NSW 2150 p PO BOX 3085 North Strath For MAX 2137 p 02 9744 3116 e info@design integrand	1:100 @ A1 or 1:200 @ A3	Proposed Dual Occupancy 4 Wollongong Street, Shellharbour JOB No. DATE DRAWN CHECKED SCALE
			Figured dimensions shall take preference over scaling. Verify all dimensions on site	p 02 9744 3116 e info@design=int.com.au	0 0.5 1.0 2.0m	01820_DA 29/01/2021 J.D A.M As Shown on A1




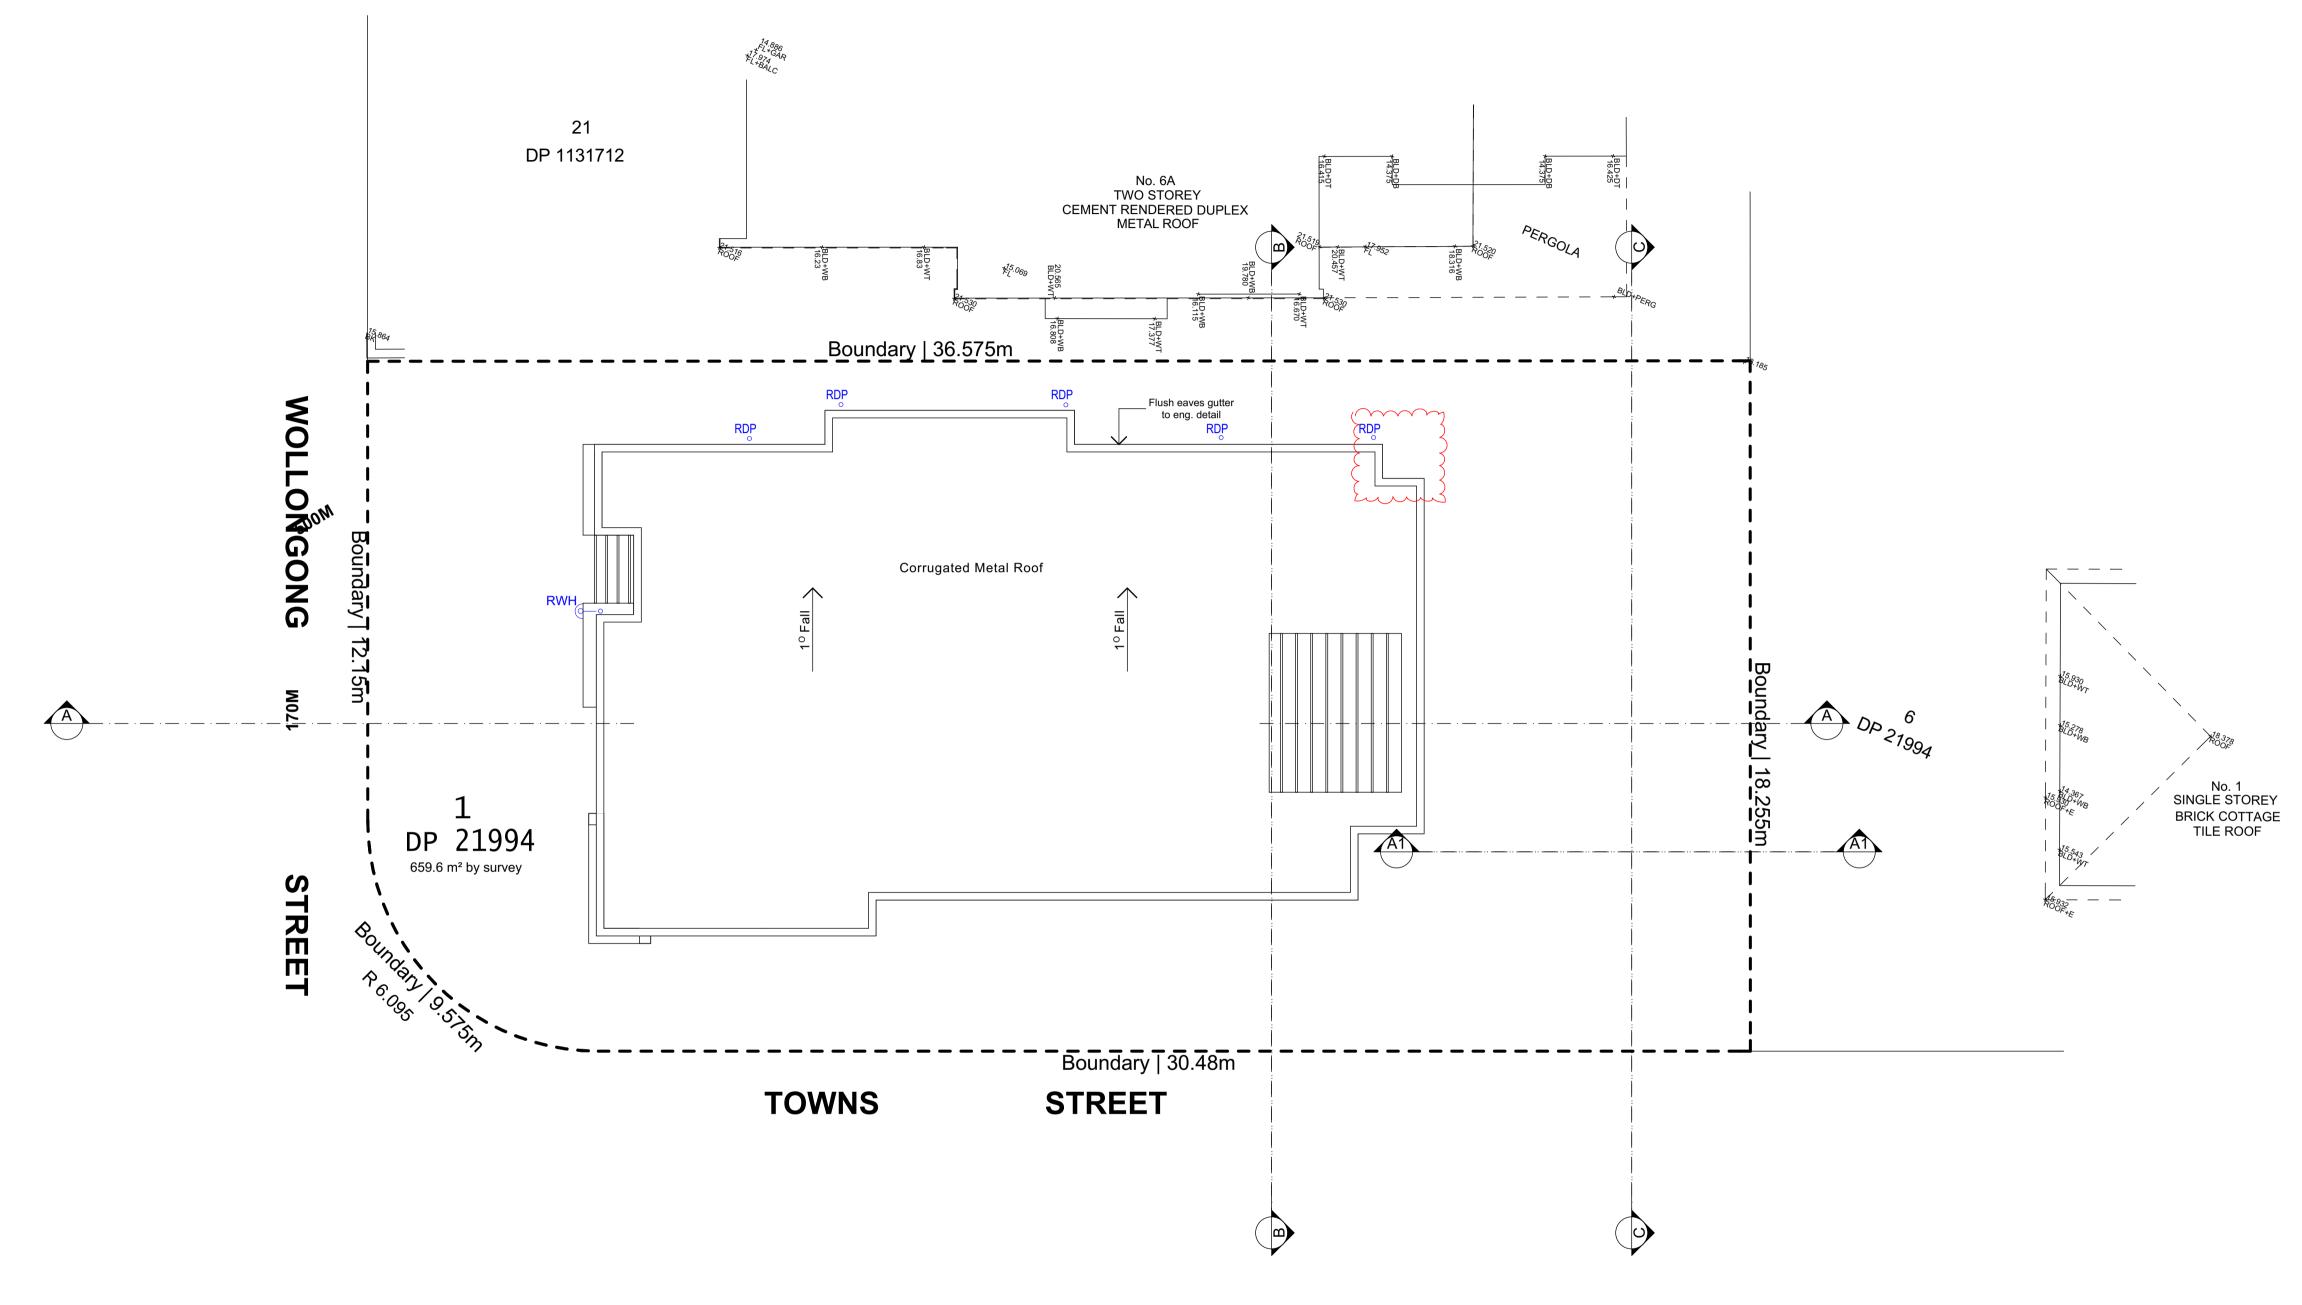


Roof Plan

1:100

ISSUE DESCRIPTION	DATE NOTES	DRAWING TITLE	SCALE NORTH
A ISSUE FOR DEVELOPMENT APPLICATION LODGEMENT	05/06/20	A P	Proposed Dual Occupancy
B ISSUE FOR DEVELOPMENT APPLICATION LODGEMENT	16/10/20	Roof Plan	
C REVISED FOR APPROVAL	29/01/21 The plans, drawings and specifications incorporated in this document shall remain the	DESIGN LINK AUSTRALIA PTY LTD	4 Wollongong Street, Shellharbour
D REVISED FOR APPROVAL	copyright © of DESIGN LINK AUSTRALIA PTY LTD and must not be used, reproduced or copied wholly or in part without prior written consent of DESIGN LINK AUSTRALIA PTY LTD.	a Suite 1 Level 5 410 Church St. Parramatta, NSW 2150	1:100 @ A1 or 1:200 @ A3
	Figured dimensions shall take preference over scaling. Verify all dimensions on site	p PO BOX 3085 North Strathfield NSW 2137 p 02 9744 3116 e info@design-link.com.au	JOB No. DATE DRAWN CHECKED SCALE 29/01/2021 J.D A.M AS Shown on A1

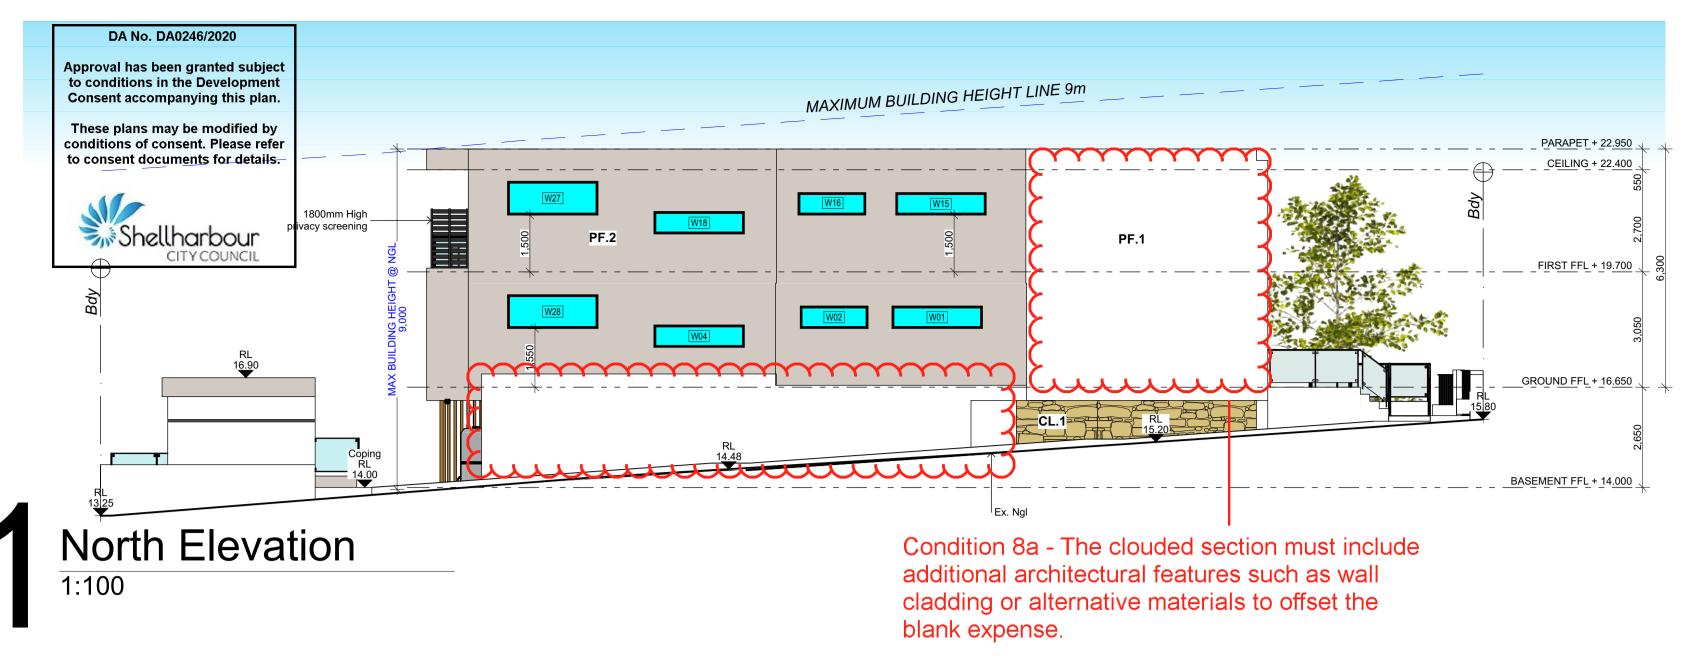




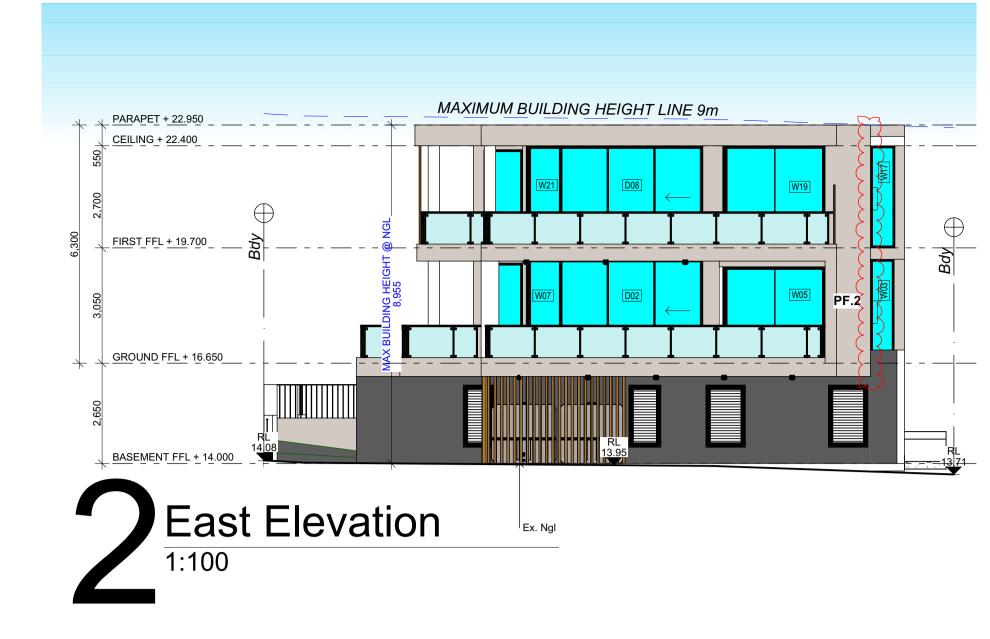


MATERIALS AND FINISHES


PF.2



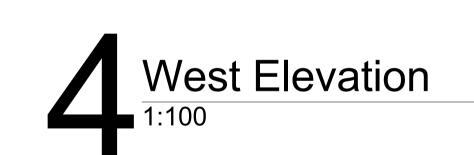

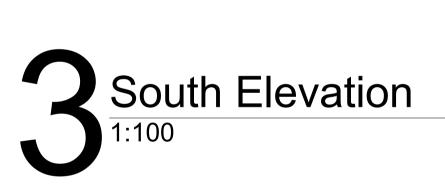




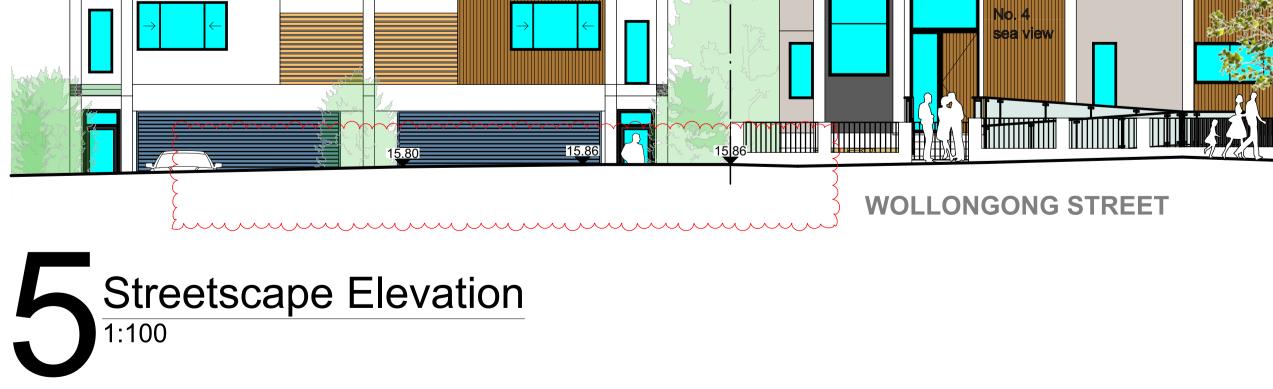




ISSUE DESCRIPTION	DATE NOTES	DRAWING TITLE	SCALE NORTH
A ISSUE FOR DEVELOPMENT APPLICATION LODGEMENT	05/06/20	₹	Proposed Dual Occupancy
B ISSUE FOR DEVELOPMENT APPLICATION LODGEMENT	16/10/20	Elevations	
C REVISED FOR APPROVAL	29/01/21 The plans, drawings and specifications incorporated in this document shall remain the	DESIGN LINK AUSTRALIA PTY LTD a Suite 1, Level 5, 410 Church St, Parramatta, NSW 2150 p PO BOX 3085 North Strathfield NSW 2137 p 00 0744 2116 p info @ design link corp ave	4 Wollongong Street, Shellharbour
D REVISED FOR APPROVAL	29/01/21 copyright © of DESIGN LINK AUSTRALIA PTY LTD and must not be used, reproduced or copied wholly or in part without prior written consent of DESIGN LINK AUSTRALIA PTY LTD.	a Suite 1, Level 5, 410 Church St, Parramatta, NSW 2150	1:100 @ A1 or 1:200 @ A3
	Figured dimensions shall take preference over scaling. Verify all dimensions on site	p PO BOX 3085 North Strathfield NSW 2137 p 02 9744 3116 e info@design-link.com.au	JOB No. DATE DRAWN CHECKED SCALE 29/01/2021 J.D A.M As Shown on A

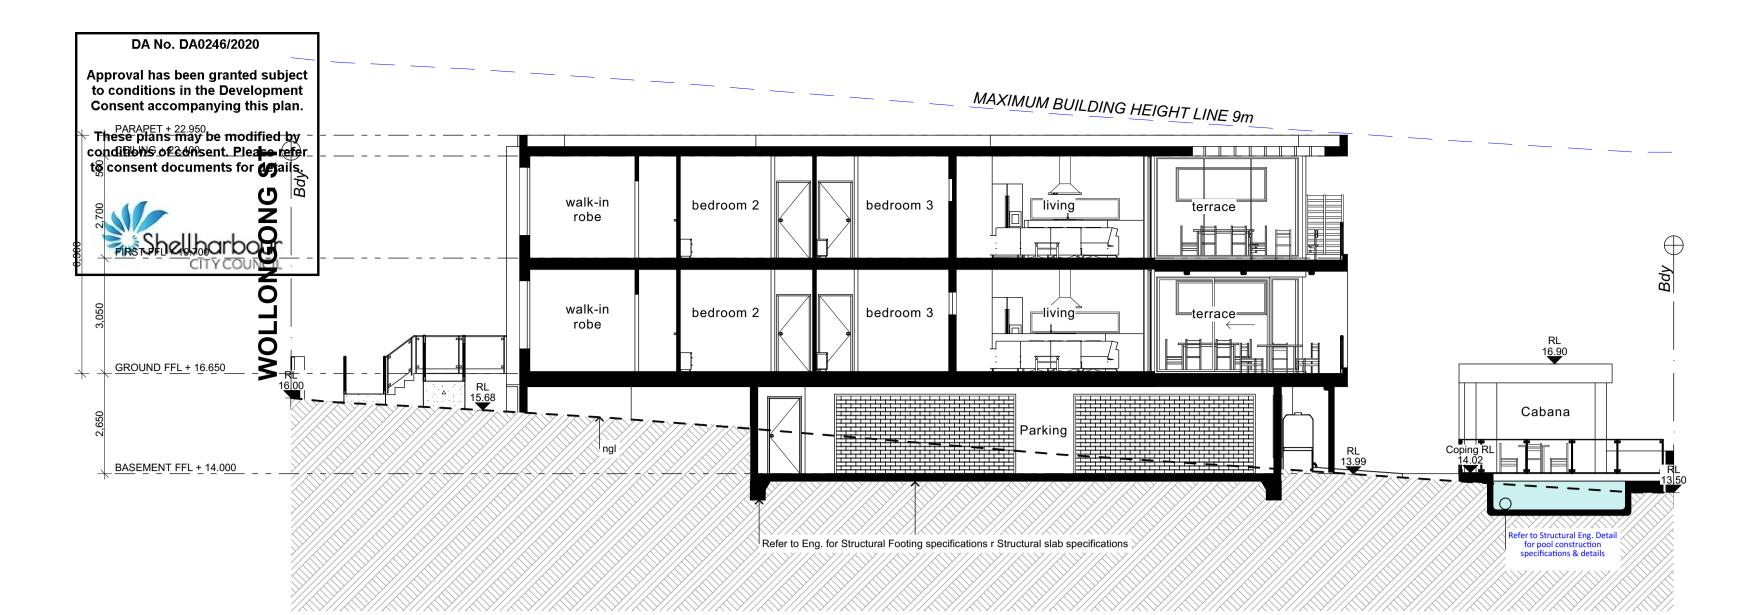


Section A - A

1:100

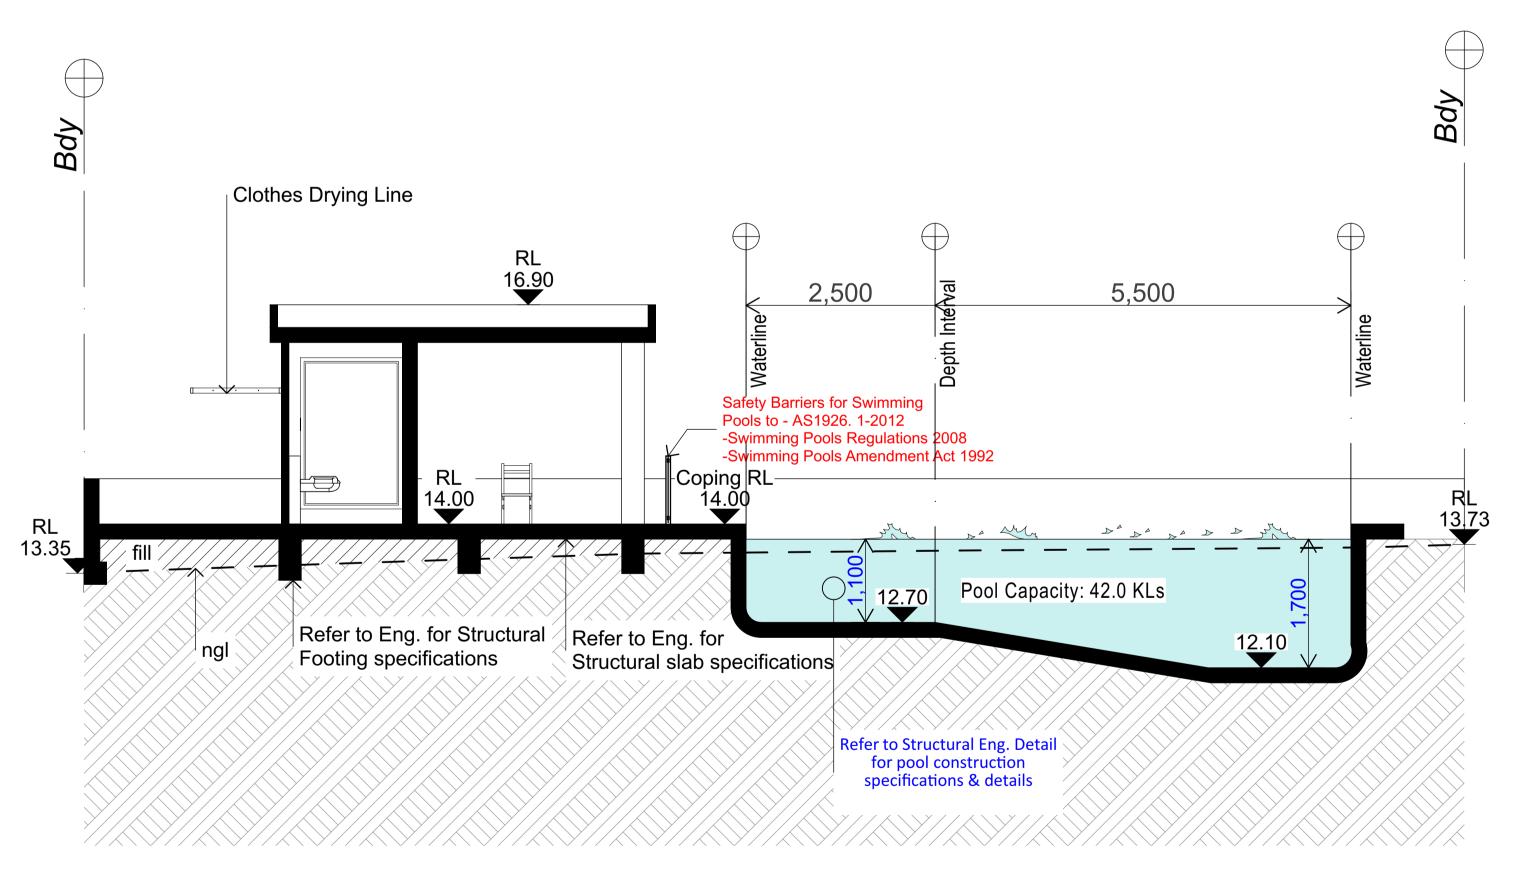

 $\underbrace{\frac{\text{Section C - C}}{1:50}}$

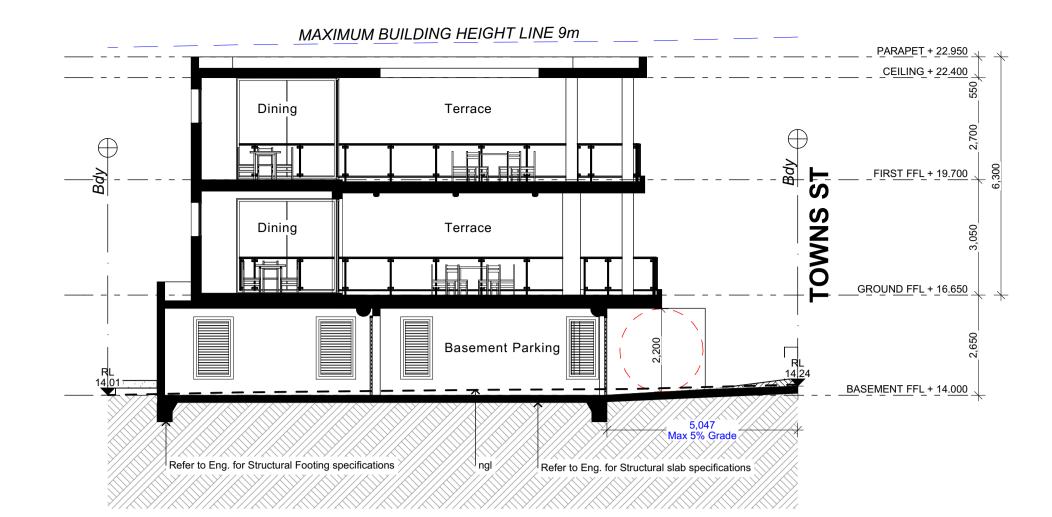

Section B - B

1:100



 Name:
 Robert Romanous

 Q/A David Howard

 Direct
 (02) 8484 4086

 Number:
 1300 787 302

 AAO:
 ABSA

 Assessor
 20039

 Number:
 4 Wollongong St, Shell Harbour

 Name:
 Software:

 BERSPro – v4.4.01

 Date:
 04/06/2020

 BASIX
 1103768M_02

 Certificate
 Group
 0004890650

NCC COMPLIANCE
In addition to BASIX Commitments; building compliance is required to comply with the 'New South Wales Additions' in the NCC 2017- Volume 1.
This includes New South Wales Part J(A). Specific mention is

made of the following provisions

- Building thermal construction in accordance with part J1.2
 If metal framed, sarking of R0.2 is required between stud
- and cladding as a thermal break
 Loss of ceiling insulation is compensated for by increased roof insulation in accordance with Part J1.3(c)

Any new air-conditioning system is installed in

- roof insulation in accordance with Part J1.3(c)
 Any roof lights, windows, doors and exhaust fans are sealed in accordance with Part J3
- accordance with Parts J5.2(a), J5.2(b), J5.2(c), J5.2(d), J5.2(f) & J5.2(g)

 Any new mechanical ventilation system is installed in
- accordance with Part J5.3.

 Any new miscellaneous exhaust system is installed in
- accordance with Part J5.4.
 Any new heated hot water system is installed in accordance with Part J7.2
- Any new energy monitoring equipment is installed in accordance with Part J8.3.

• Models rated with no downlights

- Light coloured roof for temperate or cool climates
- Kitchens / wet areas tiled/timber
 All other zones carpet
 Vents to wet areas / Jaunday / kitchen
- Vents to wet areas / laundry / kitchen
 Single story dwellings within 10m modelled
- as obstruction

 Double story dwellings within 20m modelled
- as obstruction
 Structures located at South are not modelled as obstruction
- BASIX TECHNICAL NOTES Defaults

Medium coloured external walls Walls to common areas modelled as external

- with zero solar absorptance
 Glazed corridors modelled with additional
- All ensuites are treated as conditioned
 Spaces without an openable window / door
- are included in the zone which they are accessed
- No mechanical heating or cooling appliances are modelled, including ceiling fans

Ref: BASIX-2324

CLIENT DETAILS

Page **1** of **2**




WATER Pass – 45/40%		THERMAL C	OMFORT			ENERGY			
		Pass –				Pass - 55/50%			
1 400 10, 10,0	Central 4000L Tank		G	LAZING		COMMON AREA			
Rain Water Tank	connected to landscape and toilets 100m² of Lawn +	Units			Fixed Windows around Living and	Lighting	Car Park Area – Fluorescent w/ motion sensors Plant Room - Fluorescent w/ motion sensors Garbage Room - Fluorescent w/ motion sensors		
Common	100m ² of low water				Dining	Lift	Gearless Traction w/ VVVF Motor		
Landscape	use/indigenous garden	1 and 2	U-value 4.80 1 and 2 SHGC 0.59 (± 5%) Single, Low-e		U-value 3.60 SHGC 0.54 (± 5%) Double, Clear	Ventilation	Car Park Area – No mech vent Store / Plant Room – No mech vent Garbage Room – Exhaust continuous		
Landscape	0m²			WALLS		DWELLINGS	Garbage Room – Exhaust continuous		
All Taps	5 Star			Cavity Brick – No Additional		Hot Water	Individual 6 Star Gas Instantaneous		
Ан тарз	5 5(4)	Unit 1 - Exteri	Unit 1 - External Walls		on	Heating	3.5 Star Heating and Cooling AC. No day and night		
All Showerheads	3 Star (4.5-6L/min)	Offic 1 - External walls		Infill Wall – Additional 75mm		/Cooling	zoning		
	, , ,			R2.0 Insulation		Lighting	Dedicated LED throughout		
All Toilet Flushers	4 Star				eneer – Additional 75mm	Ventilation	Bathroom - ducted to façade or roof w/ Manual Swi		
Common Pool	42kL	Unit 2 - Exteri	nal Walls	R2.0 Insulation Infill Wall – Additional 75mm R2.0 Insulation			Kitchen - ducted to façade or roof w/ Manual Switch Laundry - ducted to façade or roof w/ Manual Switch Well ventilated Fridge Space		
Common Spa	6kL w/spa cover					Appliances	Electric oven w/ gas cooktop		
· · · · · ·		Walls to corri	dors/lift	Additio	nal 75mm R2.0 Insulation	Photovoltaic	5kW system each dwelling		
						System			
		Internal Walls	in Units	No Add	litional Insulation	Other			
			ı	LOORS		Common Pool	Pumps on timer		
		All Suspended		Concre	te - Additional R2.50	and Spa Spa Heating	Gas only		
				ROOF					
		Units exposed	d roof	Metal F	- Additional R3.0 Roof - Additional R1.8 ive Blanket				


Ref: BASIX- 2324 Page **2** of **2**

DEVELOPMENT APPLICATION

DRAWING TITLE DATE | NOTES SCALE **Proposed Dual Occupancy** ISSUE FOR DEVELOPMENT APPLICATION LODGEMENT 05/06/20 **Sections** ISSUE FOR DEVELOPMENT APPLICATION LODGEMENT 16/10/20 4 Wollongong Street, Shellharbour **DESIGN LINK AUSTRALIA PTY LTD** REVISED FOR APPROVAL The plans, drawings and specifications incorporated in this document shall remain the copyright © of DESIGN LINK AUSTRALIA PTY LTD and must not be used, reproduced or 29/01/21 a Suite 1, Level 5, 410 Church St, Parramatta, NSW 2150
p PO BOX 3085 North Strathfield NSW 2137 1:100 @ A1 or 1:200 @ A3 29/01/21 REVISED FOR APPROVAL copied wholly or in part without prior written consent of DESIGN LINK AUSTRALIA PTY LTD. CHECKED SCALE Figured dimensions shall take preference over scaling. Verify all dimensions on site 01820 DA **p** 02 9744 3116 **e** info@design-link.com.au As Shown on A1 A.M

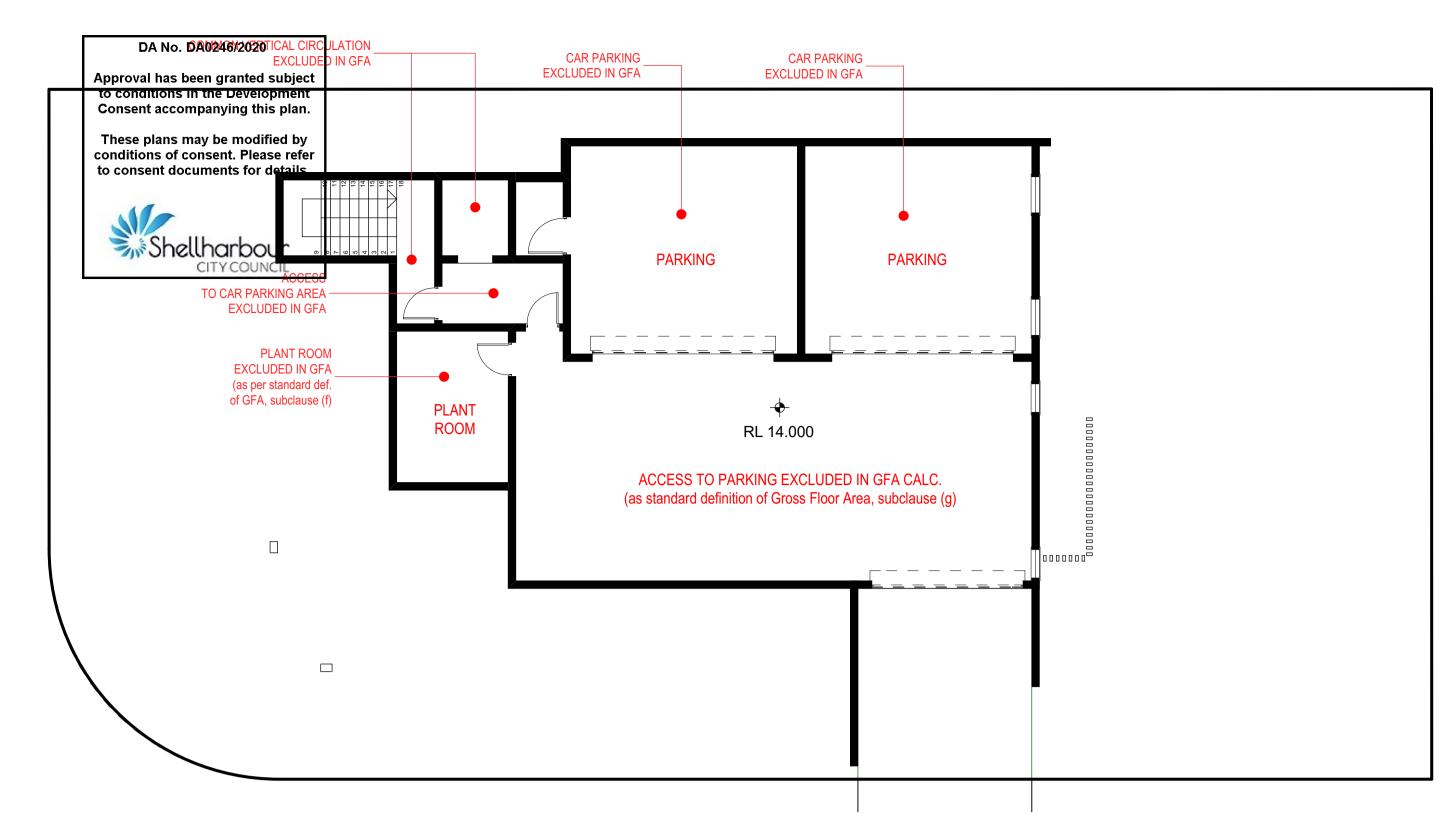



Basement Plan - Area Calculation 1:100

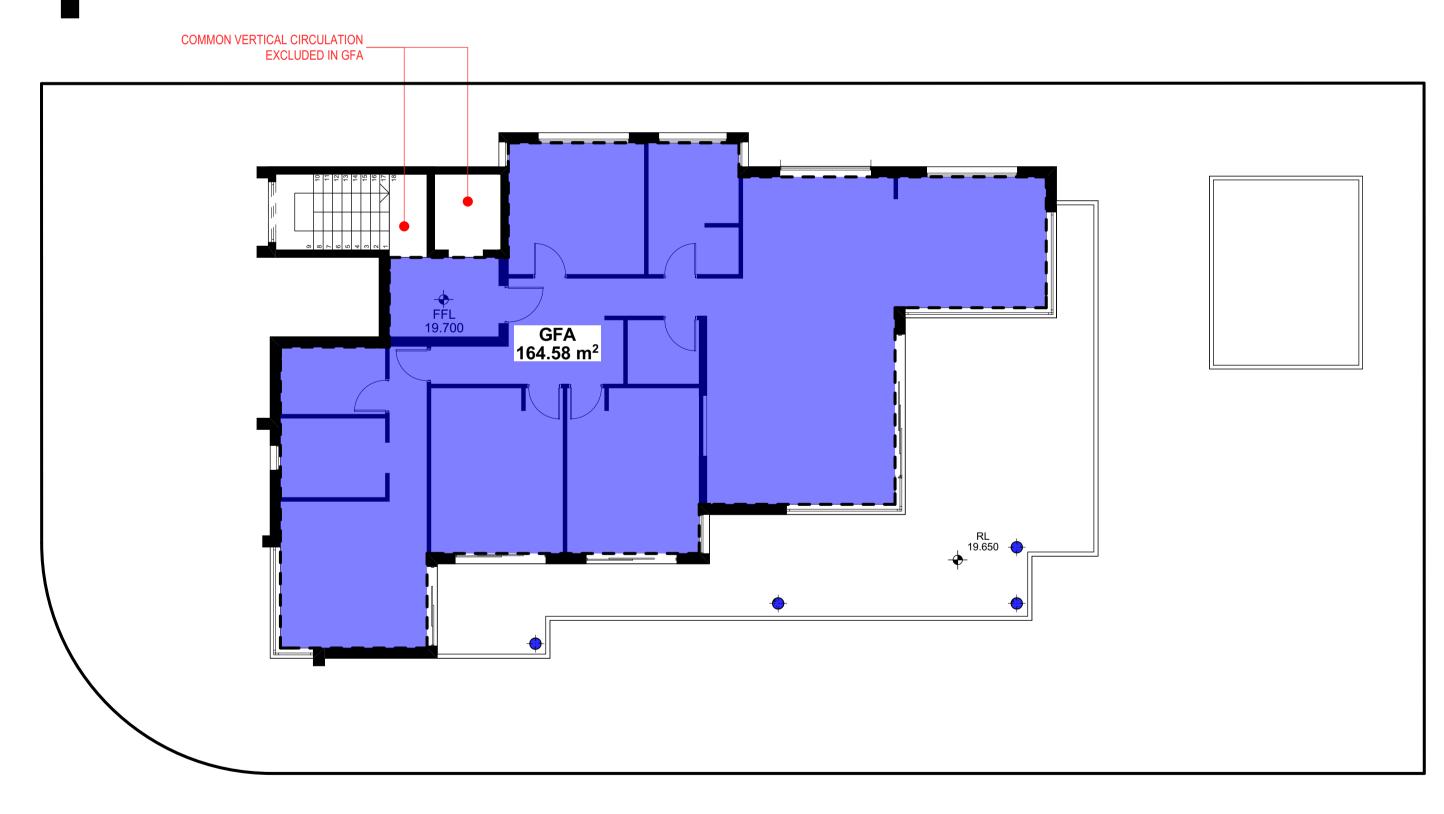

First Floor Plan - Area Calculation


DEVELOPMENT APPLICATION

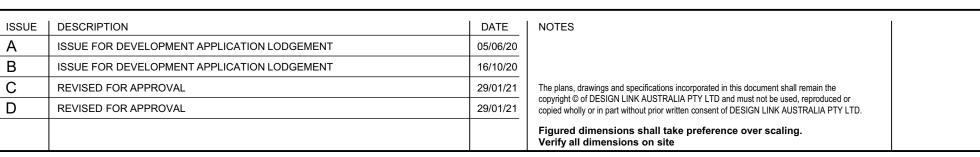

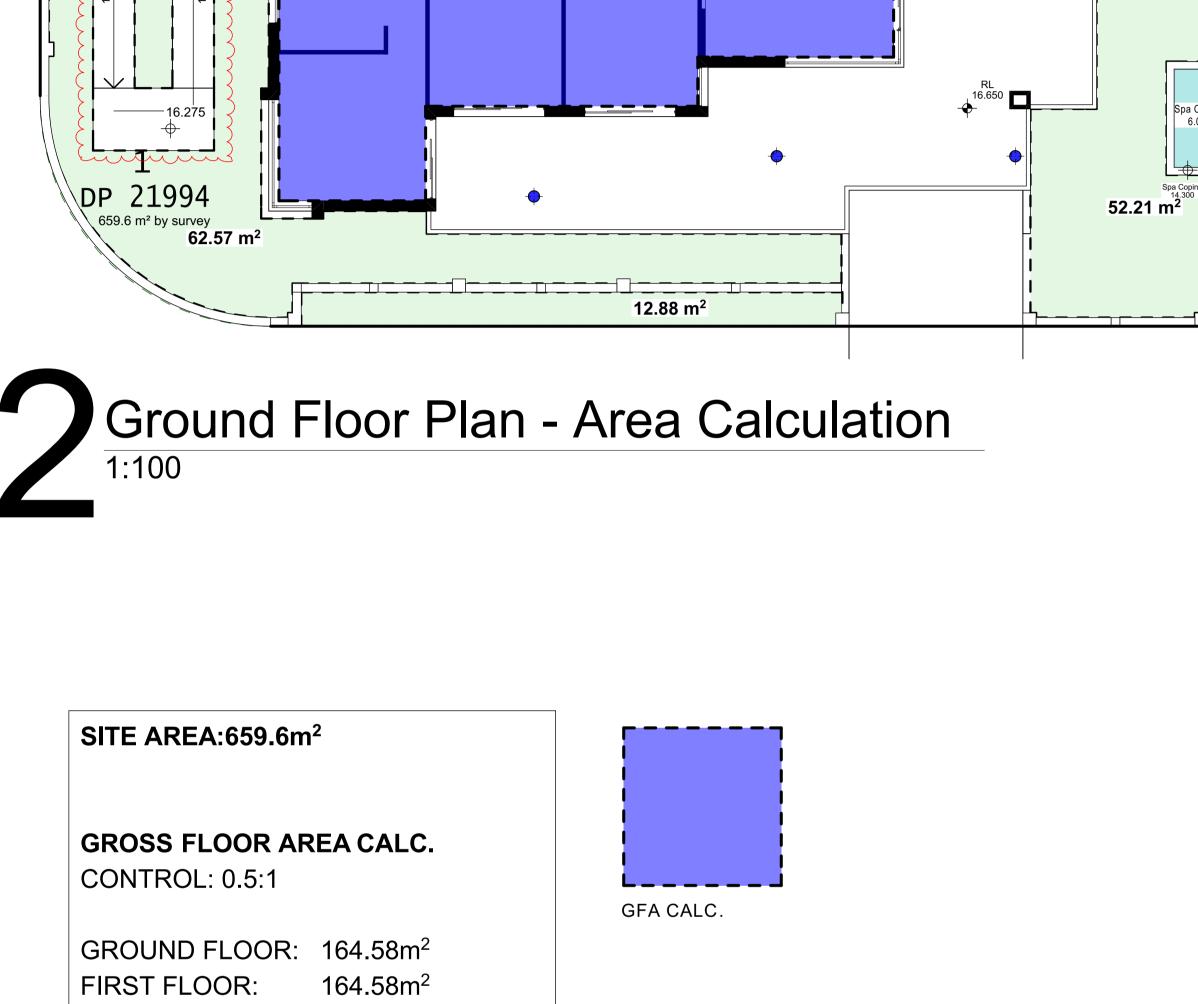

FFL 16.700

GFA 164.58 m²

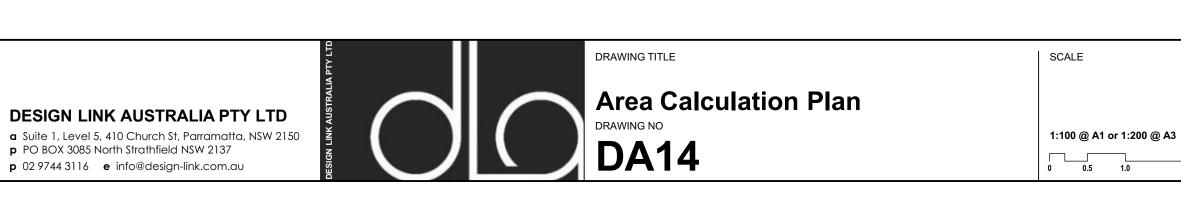

329.16m²

TOTAL LANDSCAPED AREA; 162.64m²

TOTAL GFA:

p PO BOX 3085 North Strathfield NSW 2137

p 02 9744 3116 **e** info@design-link.com.au

PROPOSED FSR: 0.50:1

LANDSCAPE AREA.

COMMON VERTICAL CIRCULATION


17.01 m²

5.49 m²

+ 15.900

EXCLUDED IN GFA

16.650

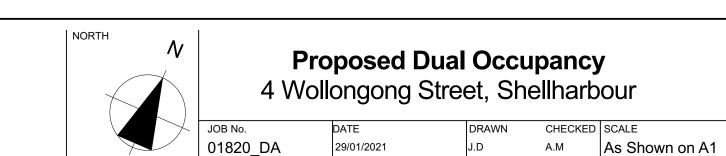


\$ MY

Coping 14.000


(Pool Capacity: 42.0 KLs)

12.48 m²


Spa Capacity: 6.0 KLs

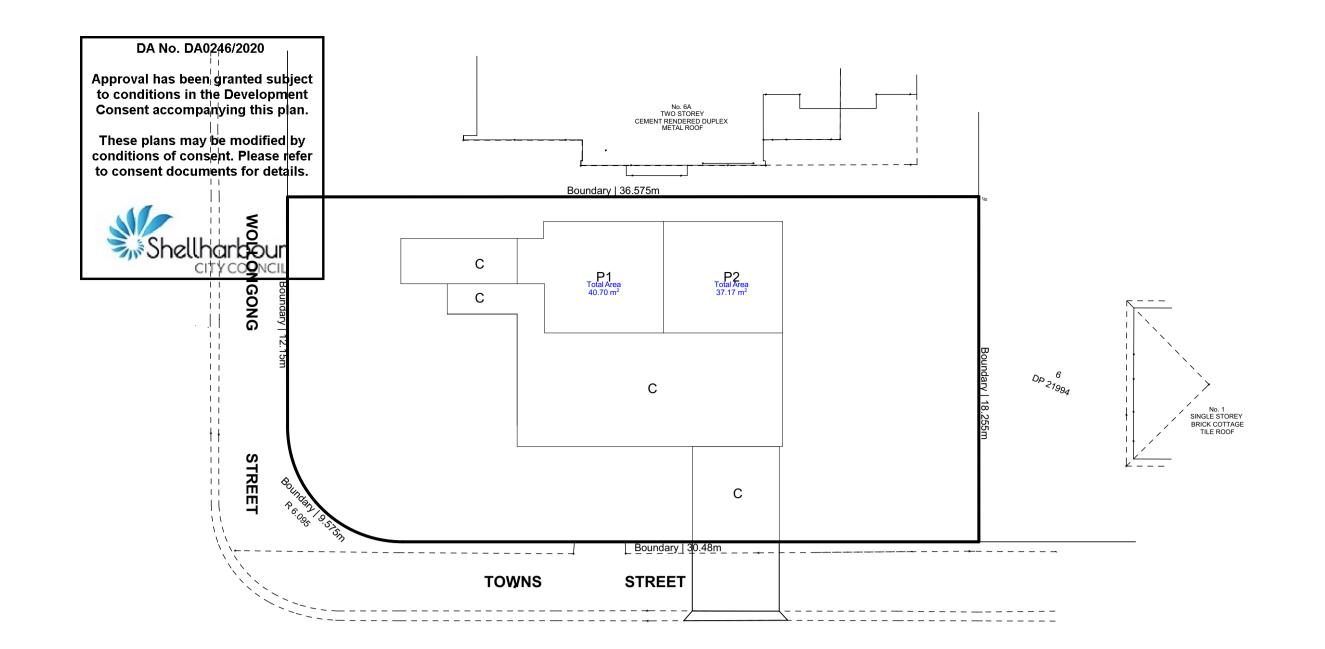

Basement Plan - Subdivison

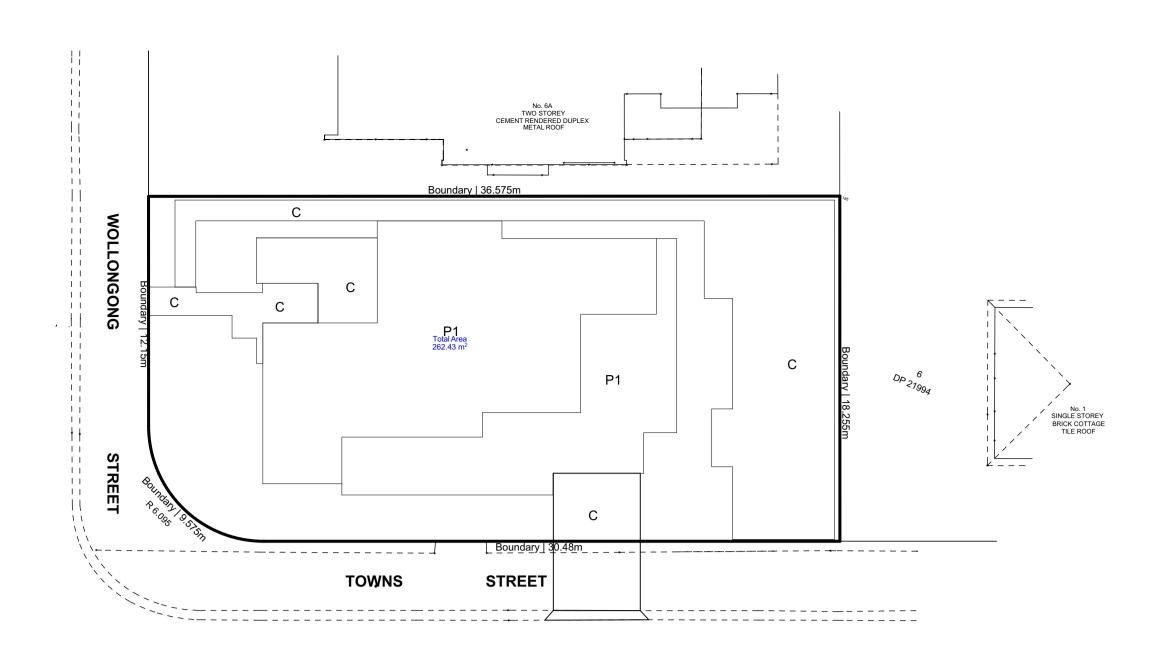

Ground Floor Plan - Subdivison

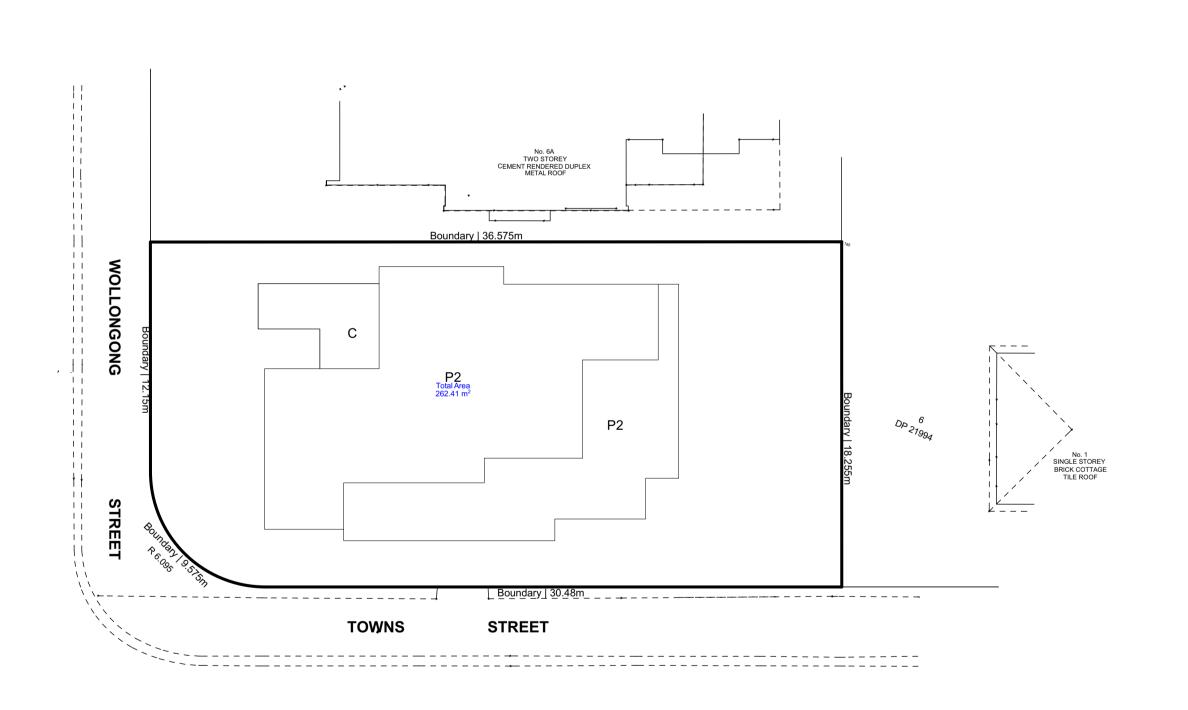

First Floor Plan - Subdivison

STRATA-SUBDIVISON CALCULATION

PROJECT: PROPOSED DUAL OCCUPANCY **SITE:** 4 WOLLONGONG STREET, SHELLHARBOUR LOT 1 | D.P 21994

SITE AREA: 659.6 m² (By Calc.)

NUMERICAL CONTROL:	PROPOSEI
Unit 1 Subdvision Area (Inclu. Garage)	303.13 m ²
Unit 2 Subdvision Area (Inclu. Garage)	299.60 m ²

DEVELOPMENT APPLICATION

DATE | NOTES

A ISSUE FOR DEVELOPMENT APPLICATION LODGEMENT

B ISSUE FOR DEVELOPMENT APPLICATION LODGEMENT

16/10/20

C REVISED FOR APPROVAL

D REVISED FOR APPROVAL

29/01/21

D REVISED FOR APPROVAL

29/01/21

D REVISED FOR APPROVAL

29/01/21

29/01/21

29/01/21

29/01/21

Figured dimensions shall take preference over scaling.

Verify all dimensions on site


D ESIGN LINK AUSTRALIA PTY LTD

a Suite 1, Level 5, 410 Church St, Parramatta, NSW 2150

p PO BOX 3085 North Strathfield NSW 2137

p 02 9744 3116 e info@design-link.com.au



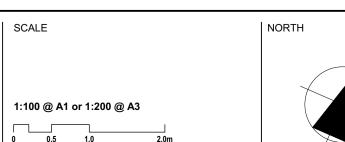



KEY:


 JOB No.
 DATE
 DRAWN
 CHECKED
 SCALE

 01820_DA
 29/01/2021
 J.D
 A.M
 As Shown on A1

C - COMMON PROPERTY

P1 - UNIT 1 PROPERTY

P2 - UNIT 2 PROPERTY

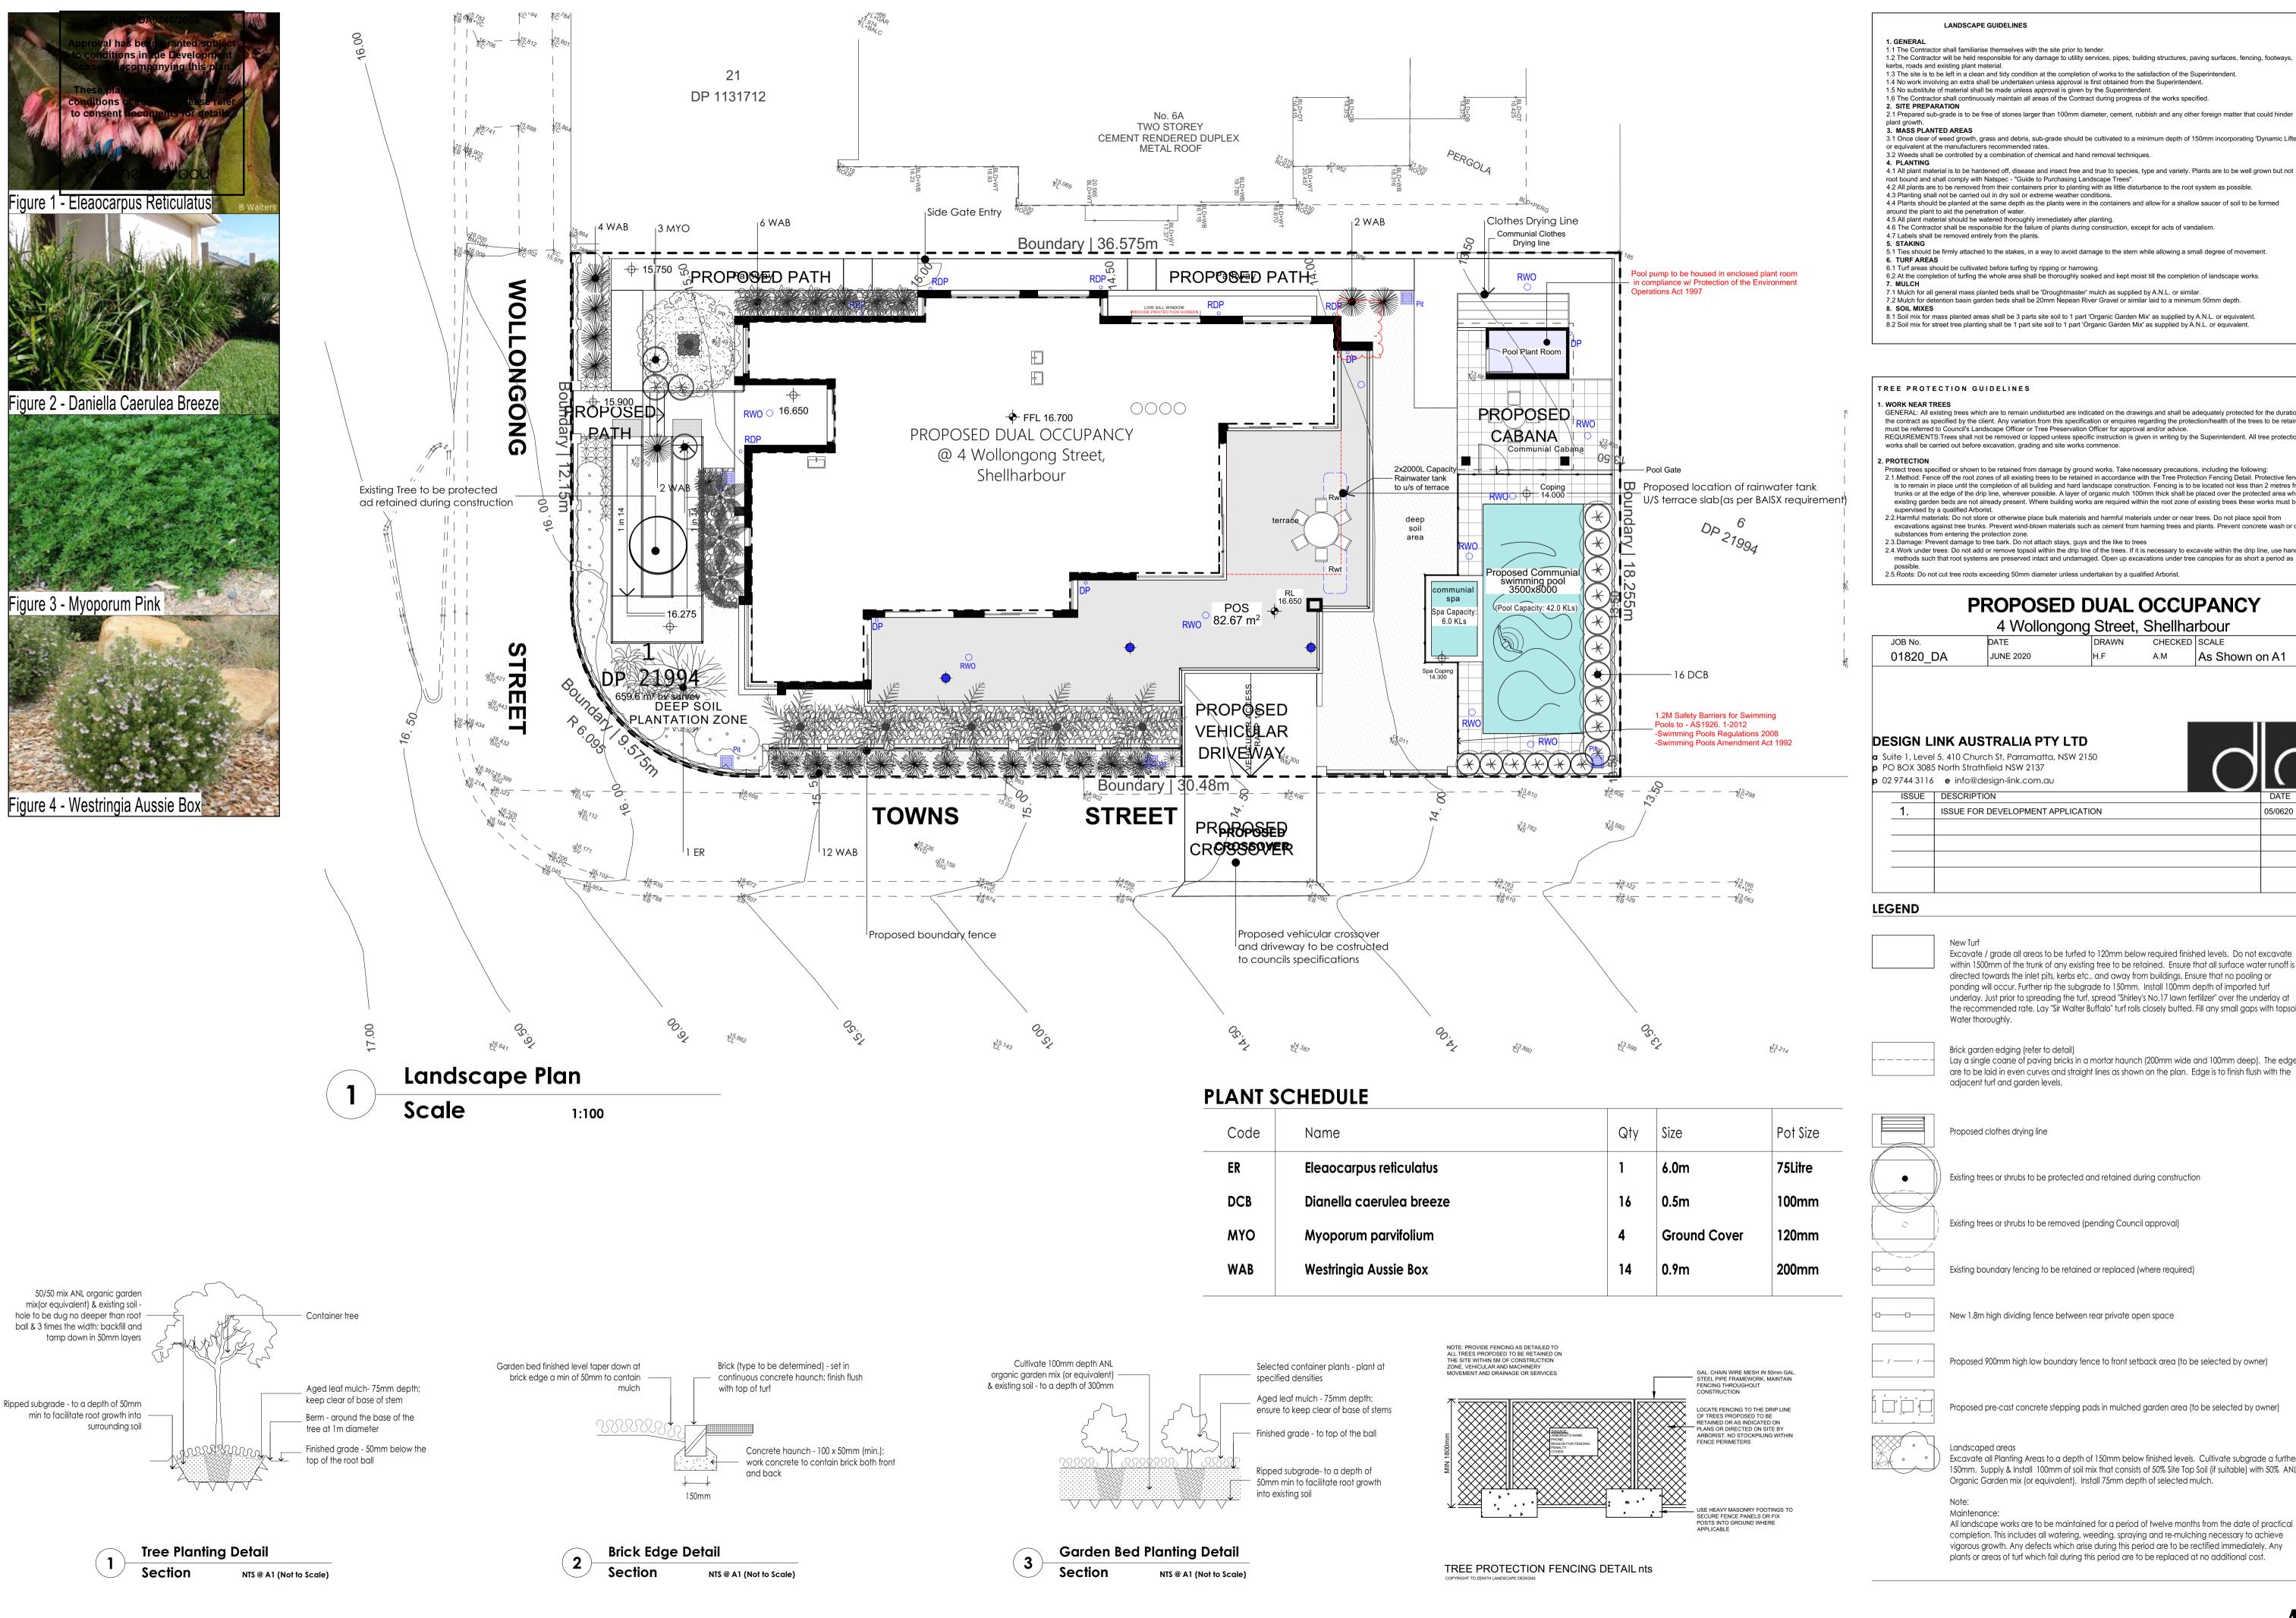

LANDSCAPE GUIDELINES

.1 The Contractor shall familiarise themselves with the site prior to tender.

1.2 The Contractor will be held responsible for any damage to utility services, pipes, building structures, paving surfaces, fencing, footways, kerbs, roads and existing plant material.

1.3 The site is to be left in a clean and tidy condition at the completion of works to the satisfaction of the Superintendent 1.4 No work involving an extra shall be undertaken unless approval is first obtained from the Superintendent. 1.5 No substitute of material shall be made unless approval is given by the Superintendent.

1.6 The Contractor shall continuously maintain all areas of the Contract during progress of the works specified.
 2. SITE PREPARATION

plant growth.

3. MASS PLANTED AREAS 3.1 Once clear of weed growth, grass and debris, sub-grade should be cultivated to a minimum depth of 150mm incorporating 'Dynamic Lifter'

or equivalent at the manufacturers recommended rates. 3.2 Weeds shall be controlled by a combination of chemical and hand removal techniques.

4.1 All plant material is to be hardened off, disease and insect free and true to species, type and variety. Plants are to be well grown but not

root bound and shall comply with Natspec - "Guide to Purchasing Landscape Trees".

4.2 All plants are to be removed from their containers prior to planting with as little disturbance to the root system as possible. 4.3 Planting shall not be carried out in dry soil or extreme weather conditions.4.4 Plants should be planted at the same depth as the plants were in the containers and allow for a shallow saucer of soil to be formed

around the plant to aid the penetration of water. 4.5 All plant material should be watered thoroughly immediately after planting.4.6 The Contractor shall be responsible for the failure of plants during construction, except for acts of vandalism.

4.7 Labels shall be removed entirely from the plants.

5.1 Ties should be firmly attached to the stakes, in a way to avoid damage to the stem while allowing a small degree of movement.

 $6.1\ \text{Turf}$ areas should be cultivated before turfing by ripping or harrowing. 6.2 At the completion of turfing the whole area shall be thoroughly soaked and kept moist till the completion of landscape works.

7.1 Mulch for all general mass planted beds shall be 'Droughtmaster' mulch as supplied by A.N.L. or similar.
7.2 Mulch for detention basin garden beds shall be 20mm Nepean River Gravel or similar laid to a minimum 50mm depth.

8.1 Soil mix for mass planted areas shall be 3 parts site soil to 1 part 'Organic Garden Mix' as supplied by A.N.L. or equivalent. 8.2 Soil mix for street tree planting shall be 1 part site soil to 1 part 'Organic Garden Mix' as supplied by A.N.L. or equivalent.

TREE PROTECTION GUIDELINES

GENERAL: All existing trees which are to remain undisturbed are indicated on the drawings and shall be adequately protected for the duration of the contract as specified by the client. Any variation from this specification or enquires regarding the protection/health of the trees to be retained must be referred to Council's Landscape Officer or Tree Preservation Officer for approval and/or advice.

REQUIREMENTS:Trees shall not be removed or lopped unless specific instruction is given in writing by the Superintendent. All tree protection works shall be carried out before excavation, grading and site works commence.

Protect trees specified or shown to be retained from damage by ground works. Take necessary precautions, including the following:

- 2.1.Method: Fence off the root zones of all existing trees to be retained in accordance with the Tree Protection Fencing Detail. Protective fencing is to remain in place until the completion of all building and hard landscape construction. Fencing is to be located not less than 2 metres from trunks or at the edge of the drip line, wherever possible. A layer of organic mulch 100mm thick shall be placed over the protected area where existing garden beds are not already present. Where building works are required within the root zone of existing trees these works must be supervised by a qualified Arborist.
- 2. Harmful materials: Do not store or otherwise place bulk materials and harmful materials under or near trees. Do not place spoil from excavations against tree trunks. Prevent wind-blown materials such as cement from harming trees and plants. Prevent concrete wash or other
- substances from entering the protection zone. 2.3.Damage: Prevent damage to tree bark. Do not attach stays, guys and the like to trees
- 2.4. Work under trees: Do not add or remove topsoil within the drip line of the trees. If it is necessary to excavate within the drip line, use hand methods such that root systems are preserved intact and undamaged. Open up excavations under tree canopies for as short a period as

PROPOSED DUAL OCCUPANCY

4 Wollongong Street, Shellharbour

Ħ.	01820_DA	JUNE 2020	H.F	A.M	As Shown o	n A1
"(
	DEGICALLINIK ALIG	TDALLA DTV LTD				
	DESIGN LINK AUS					
	a Suite 1, Level 5, 410 Churc		50			

PO BOX 3085 North Strathfield NSW 2137

02 9744 3116 **e** info@design-link.com.au

ISSUE | DESCRIPTION ISSUE FOR DEVELOPMENT APPLICATION

Excavate / grade all areas to be turfed to 120mm below required finished levels. Do not excavate within 1500mm of the trunk of any existing tree to be retained. Ensure that all surface water runoff is directed towards the inlet pits, kerbs etc.. and away from buildings. Ensure that no pooling or ponding will occur. Further rip the subgrade to 150mm. Install 100mm depth of imported turf underlay. Just prior to spreading the turf, spread "Shirley's No.17 lawn fertilizer" over the underlay at the recommended rate. Lay "Sir Walter Buffalo" turf rolls closely butted. Fill any small gaps with topsoil. Water thoroughly.

Brick garden edging (refer to detail)

Lay a single coarse of paving bricks in a mortar haunch (200mm wide and 100mm deep). The edges are to be laid in even curves and straight lines as shown on the plan. Edge is to finish flush with the adjacent turf and garden levels.

Proposed clothes drying line

Existing trees or shrubs to be protected and retained during construction

Existing trees or shrubs to be removed (pending Council approval)

Existing boundary fencing to be retained or replaced (where required)

New 1.8m high dividing fence between rear private open space

Proposed 900mm high low boundary fence to front setback area (to be selected by owner)

Proposed pre-cast concrete stepping pads in mulched garden area (to be selected by owner)




150mm. Supply & Install 100mm of soil mix that consists of 50% Site Top Soil (if suitable) with 50% ANL Organic Garden mix (or equivalent). Install 75mm depth of selected mulch. Note:

Maintenance:

All landscape works are to be maintained for a period of twelve months from the date of practical completion. This includes all watering, weeding, spraying and re-mulching necessary to achieve vigorous growth. Any defects which arise during this period are to be rectified immediately. Any plants or areas of turf which fail during this period are to be replaced at no additional cost.



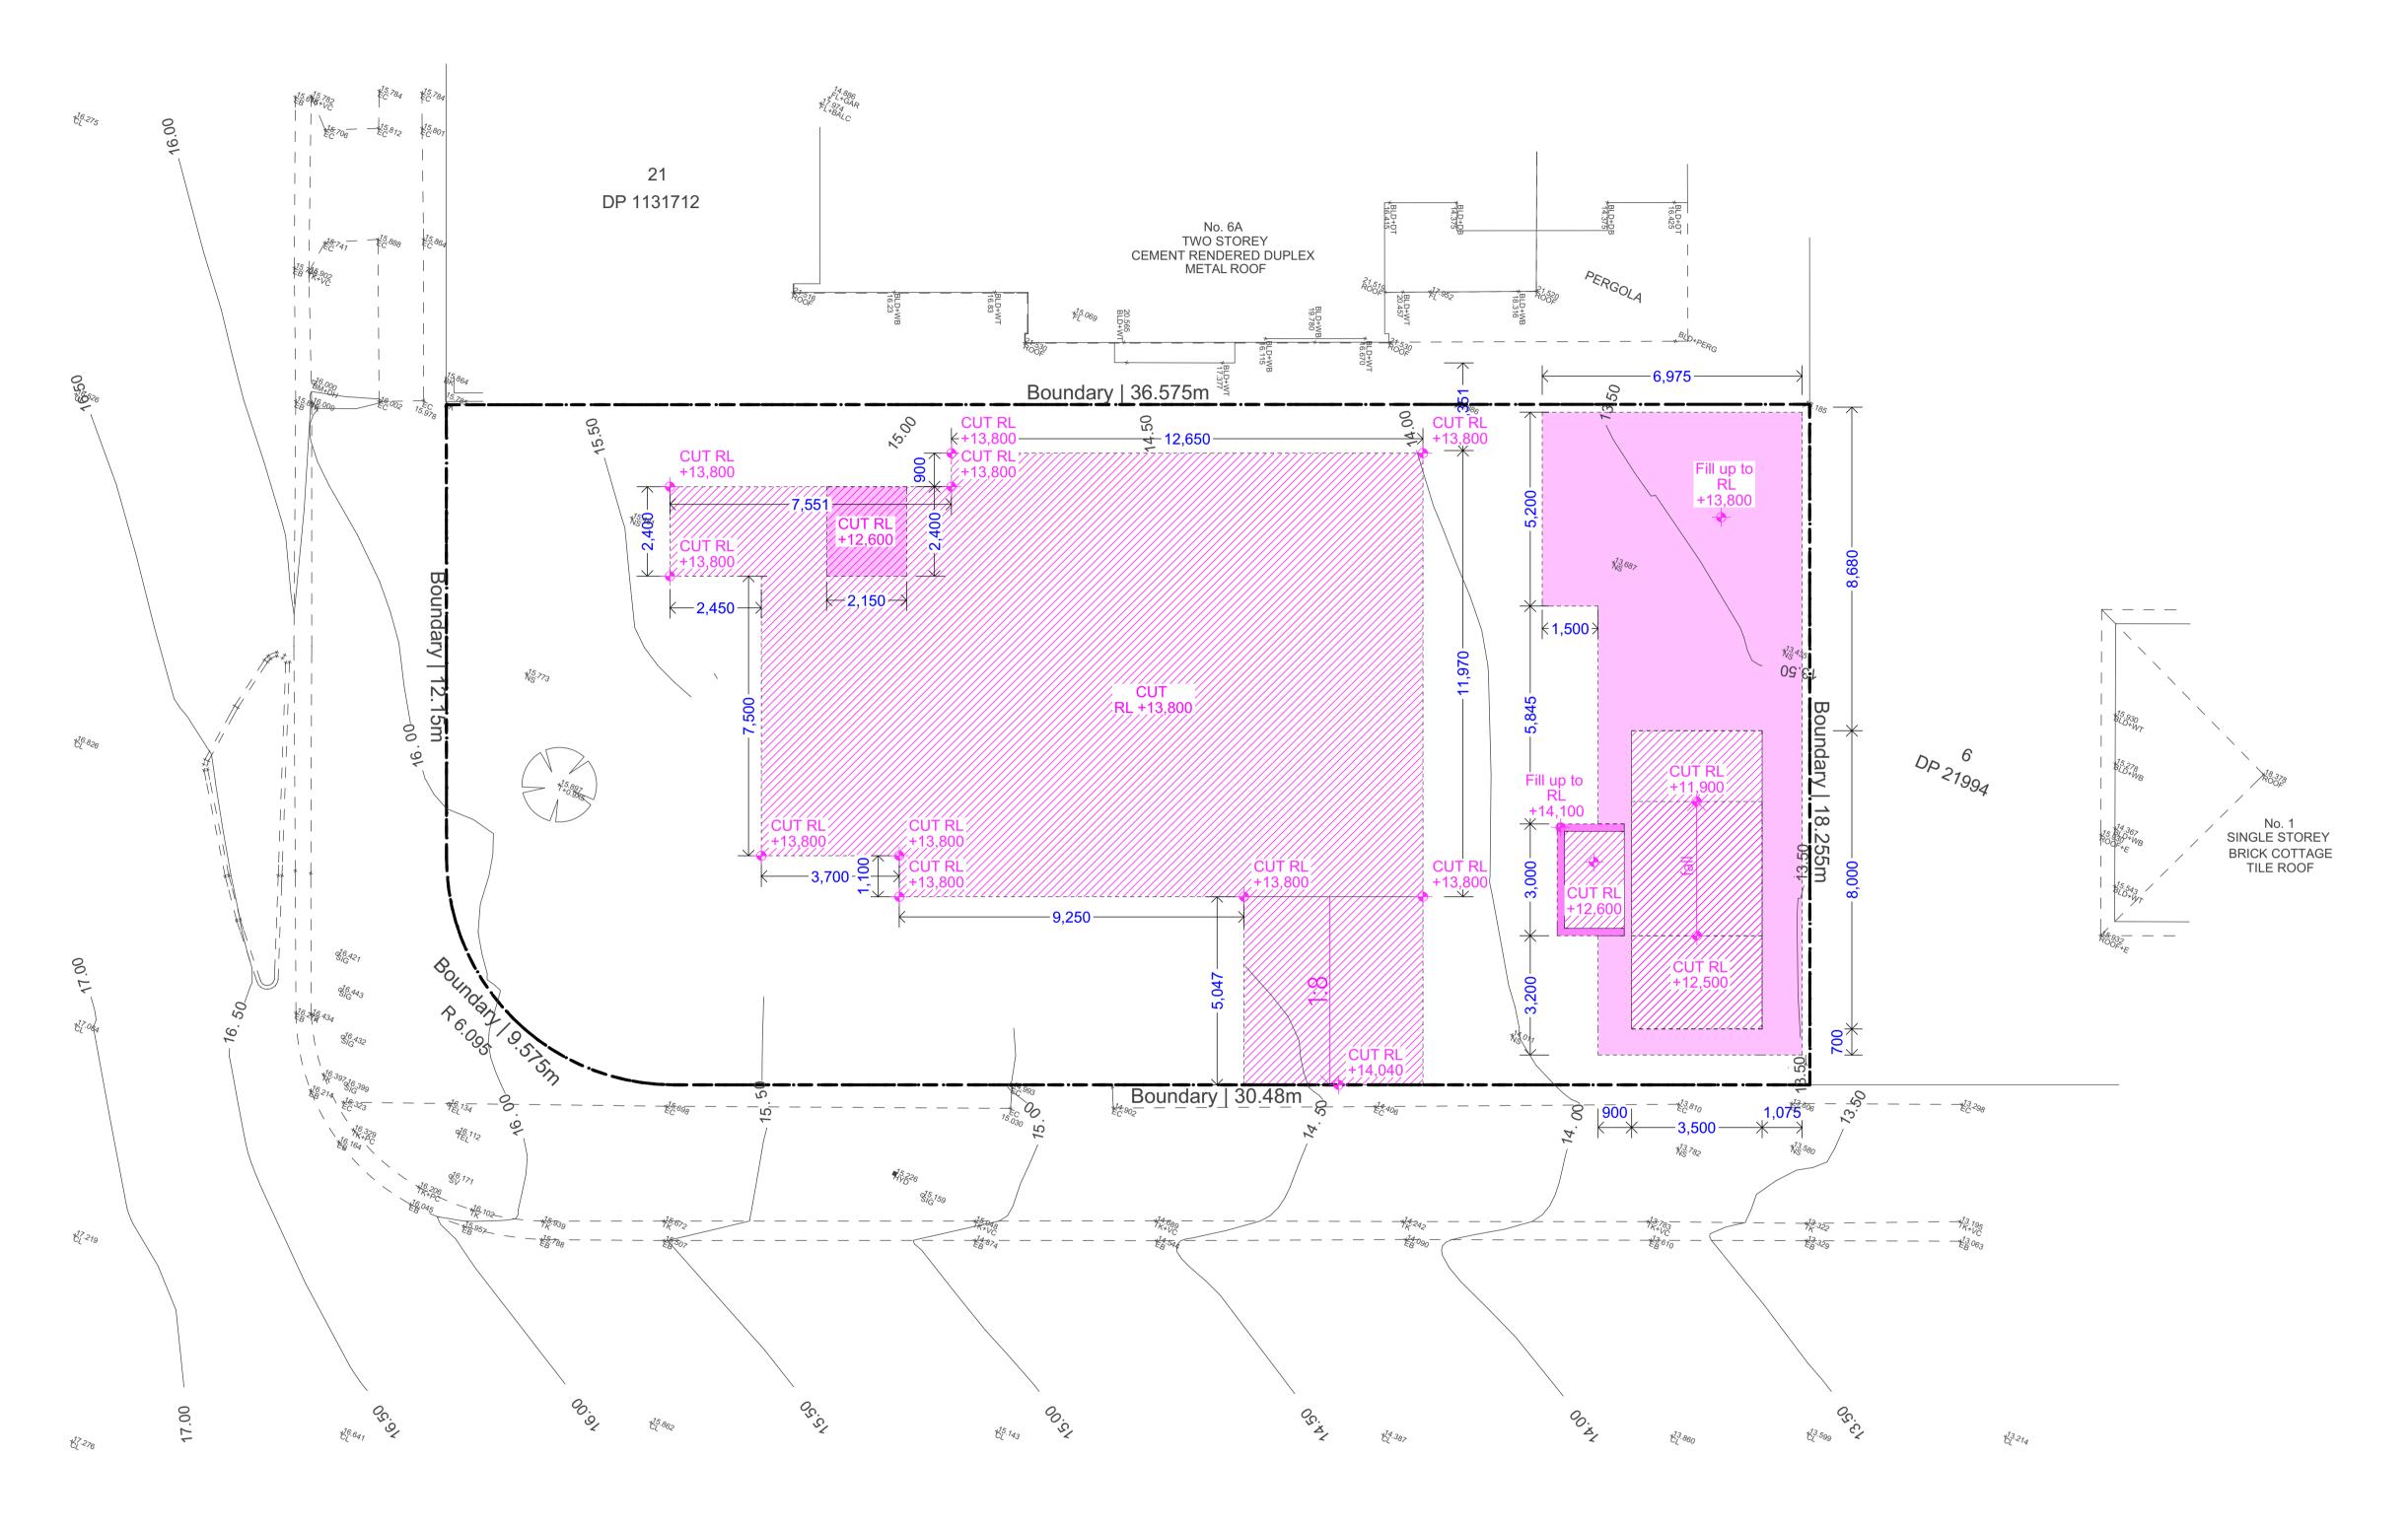

01 CUT & FILL PLAN 1:100


ISSUE	DESCRIPTION	DATE	NOTES	DRAWING TITLE	SCALE	NORTH .
Α	ISSUED FOR DEVELOPMENT APPLICATION LODGEMENT	16/10/20		Cut 2 Fill plan		Proposed Dual Occupancy
			The plans, drawings and specifications incorporated in this document shall remain the copyright © of DESIGN LINK AUSTRALIA PTY LTD and must not be used, reproduced or	DESIGN LINK AUSTRALIA PTY LTD		4 Wollongong Street, Shellharbour
			copied wholly or in part without prior written consent of DESIGN LINK AUSTRALIA PTY LTD. Figured dimensions shall take preference over scaling. Verify all dimensions on site	a Suite 1, Level 5, 410 Church St, Parramatta, NSW 2150 p PO BOX 3085 North Strathfield NSW 2137 p 02 9744 3116 e info@design-link.com.au	1:100 @ A1 or 1:200 @ A3 0 0.5 1.0 2.0m	JOB No. DATE DRAWN CHECKED SCALE 01820_DA 2/11/2020 J.D A.M As Shown on A1

DA No. DA0246/2020

Approval has been granted subject to conditions in the Development Consent accompanying this plan.

These plans may be modified by conditions of consent. Please refer to consent documents for details.




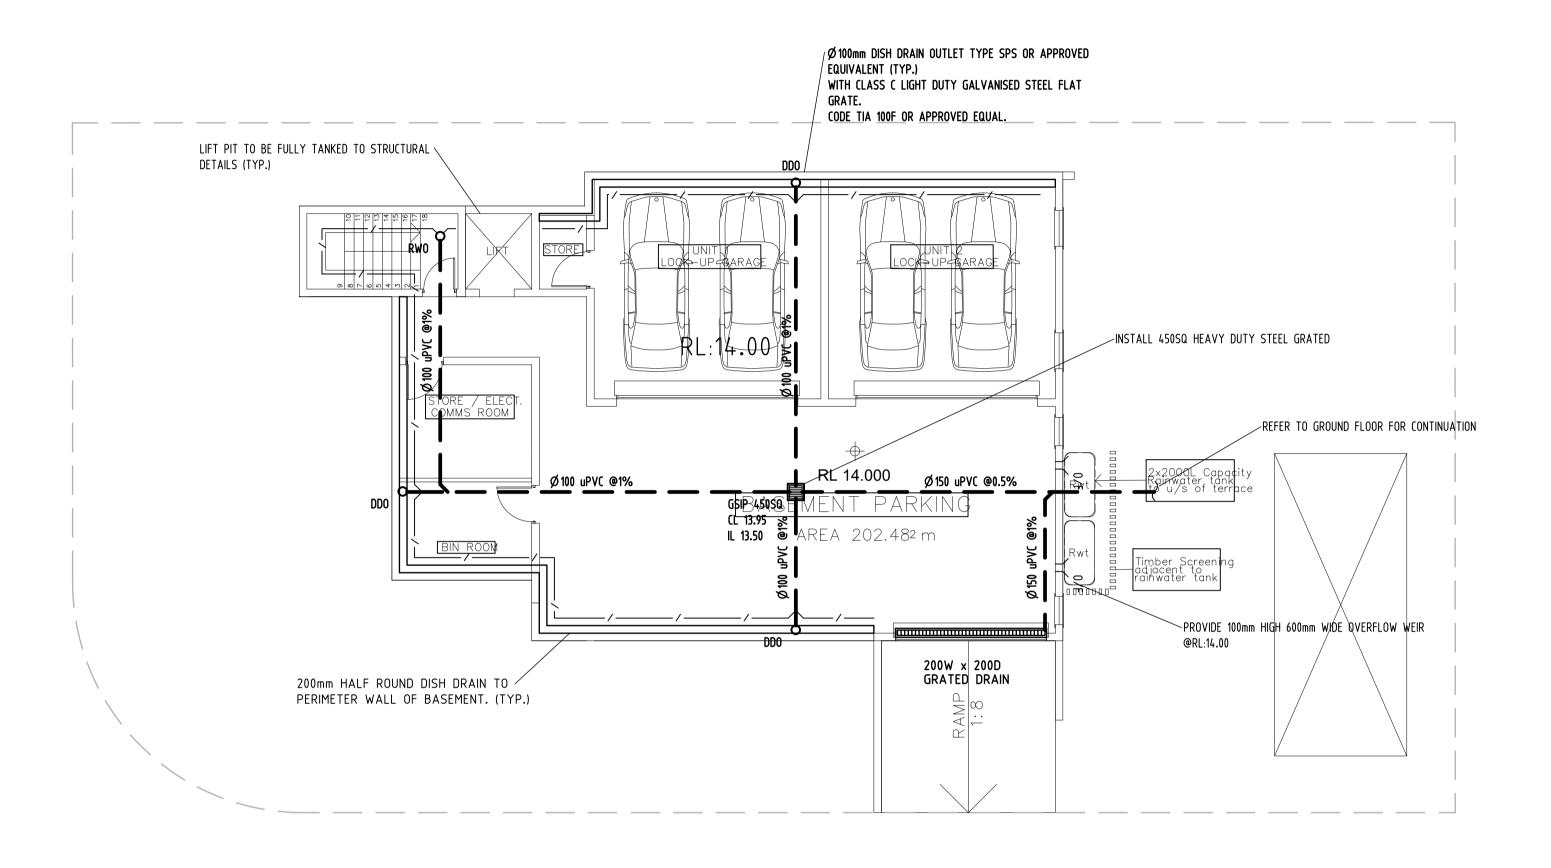



BASEMENT FLOOR PLAN

SCALE 1:100 (A1)

SCALE 1:200 (A3)

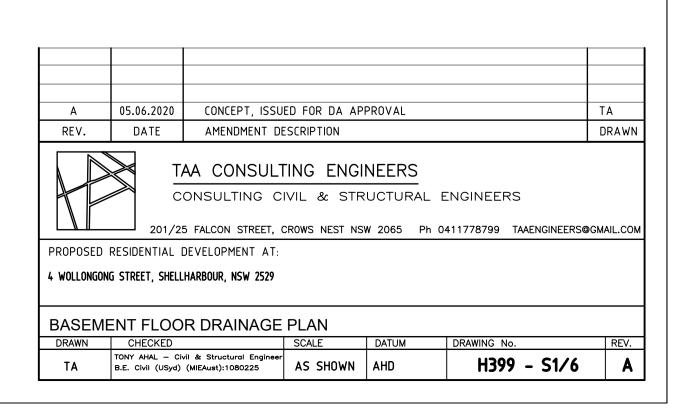

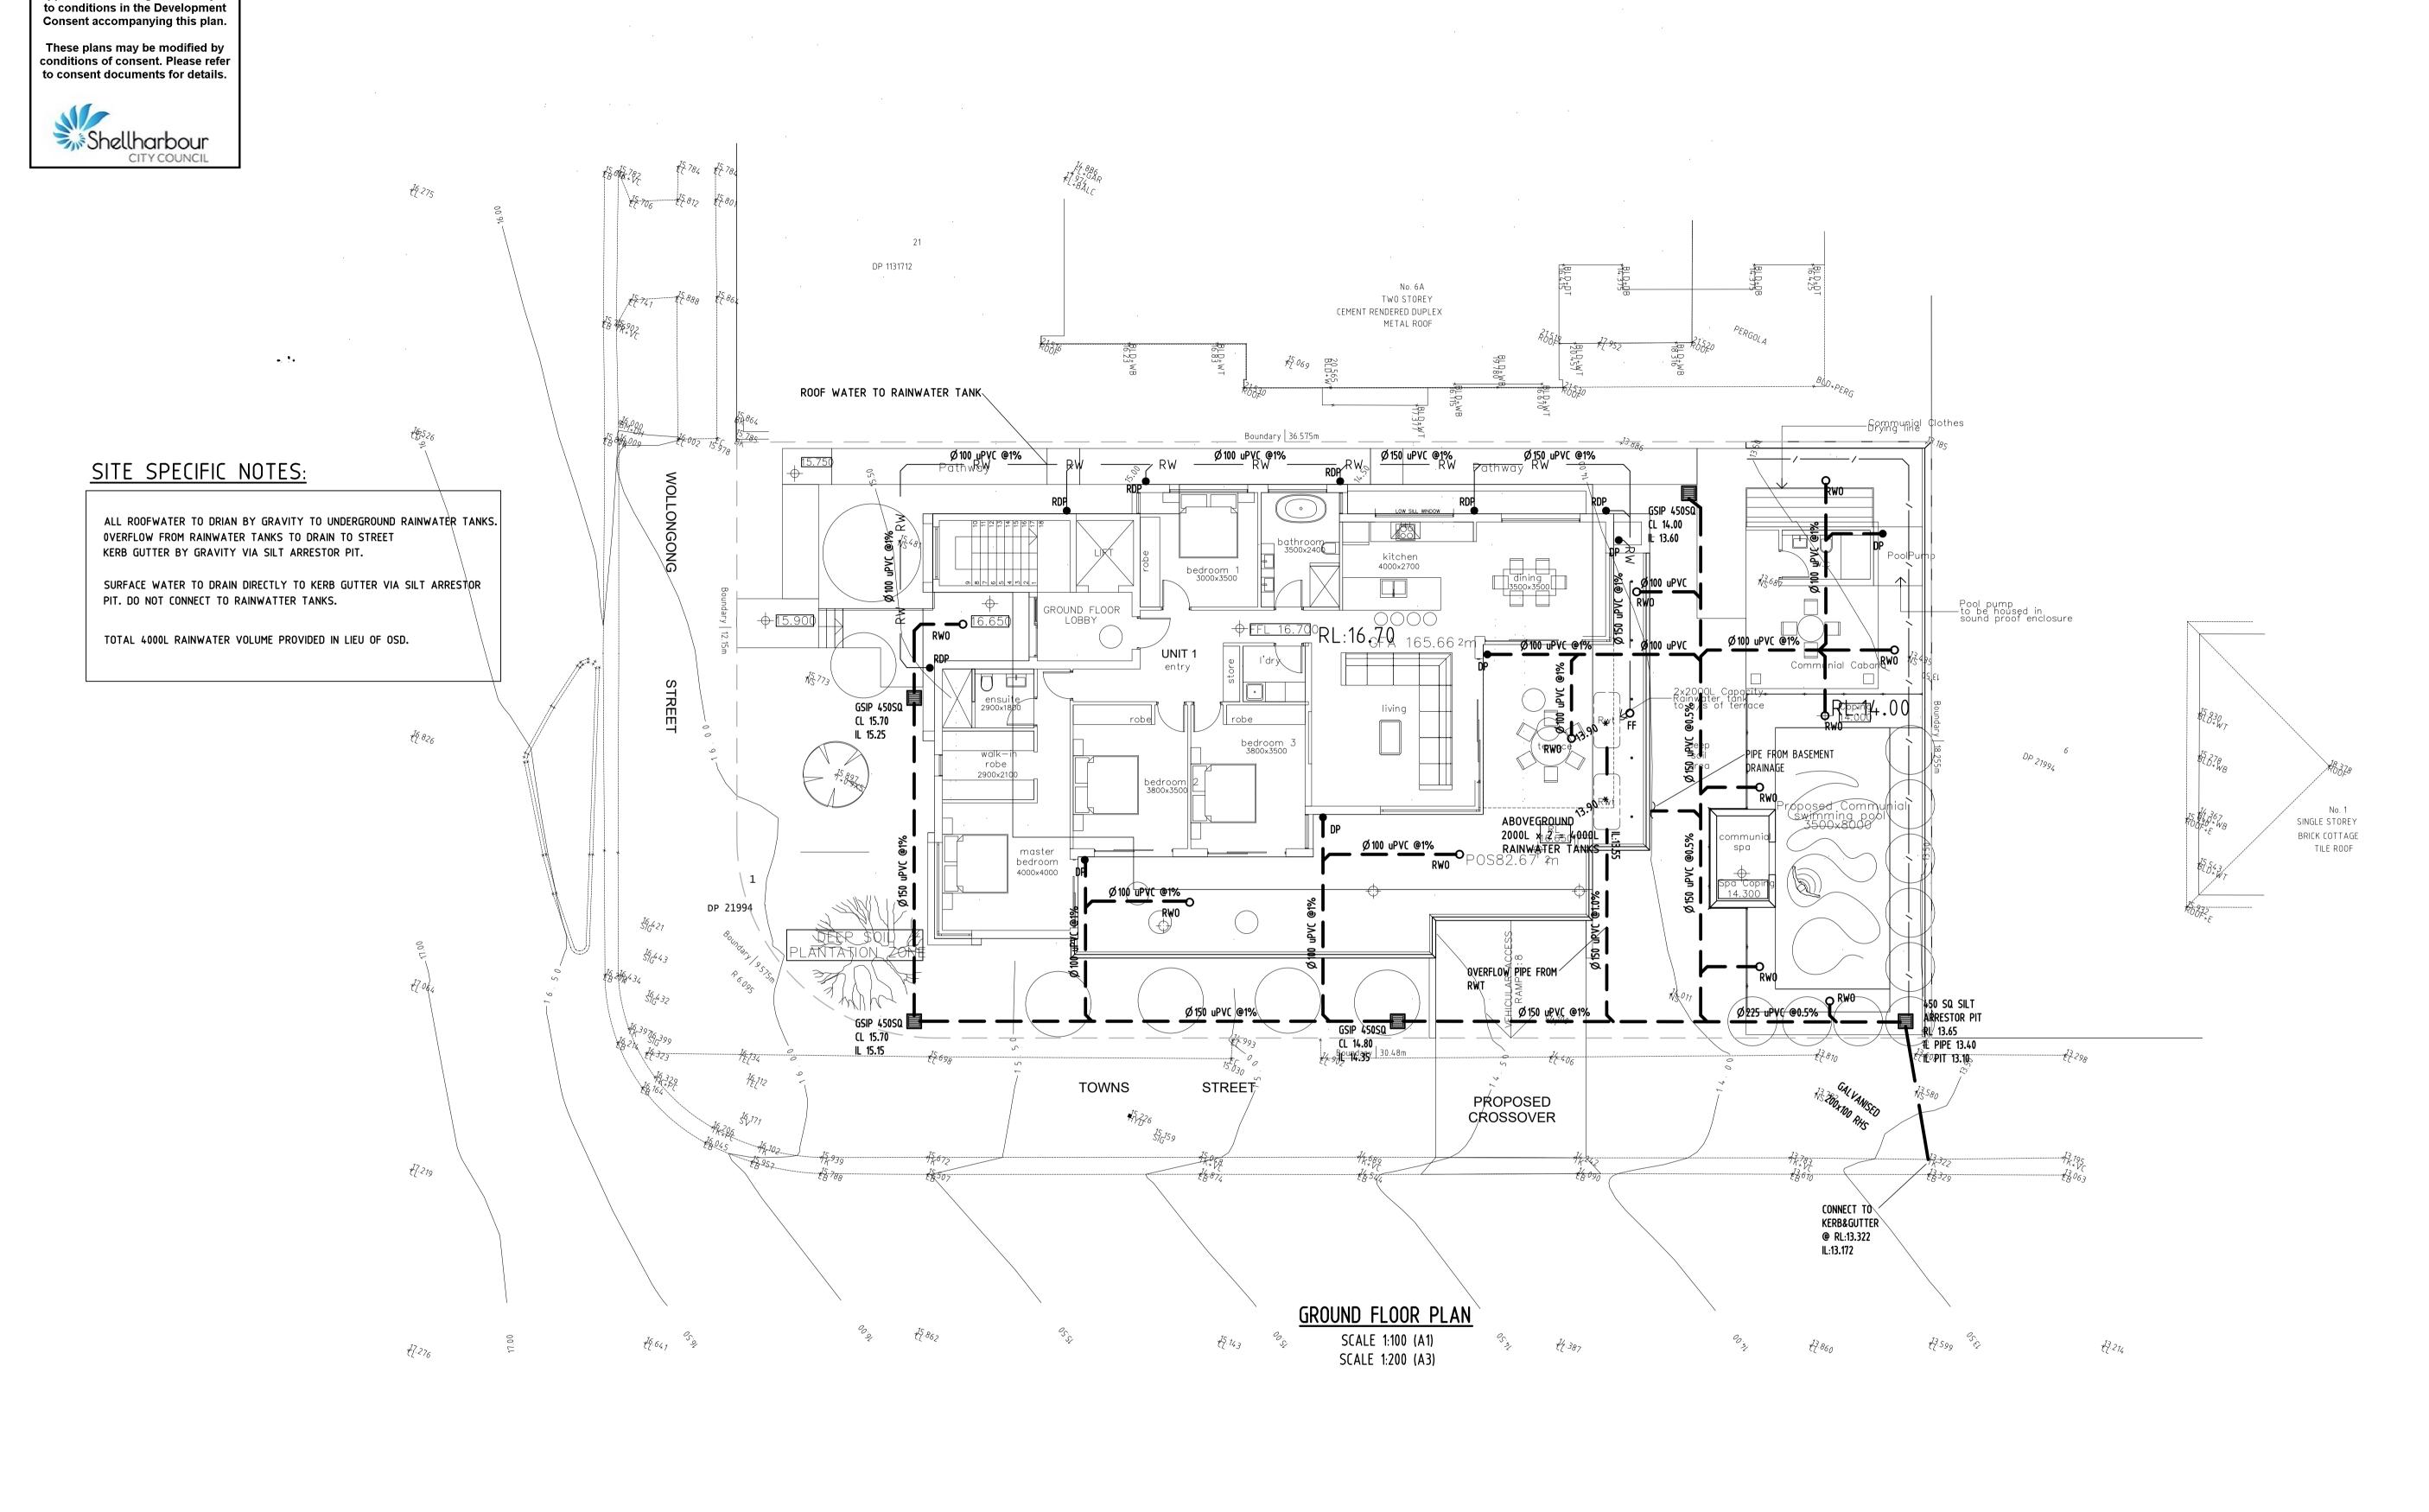

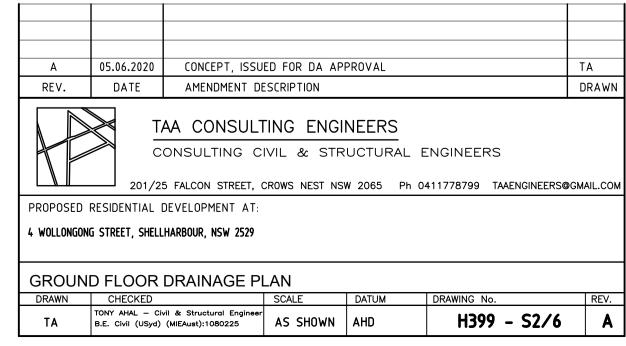

DA No. DA0246/2020


Approval has been granted subject

DA No. DA0246/2020

Approval has been granted subject to conditions in the Development Consent accompanying this plan.


These plans may be modified by conditions of consent. Please refer to consent documents for details.



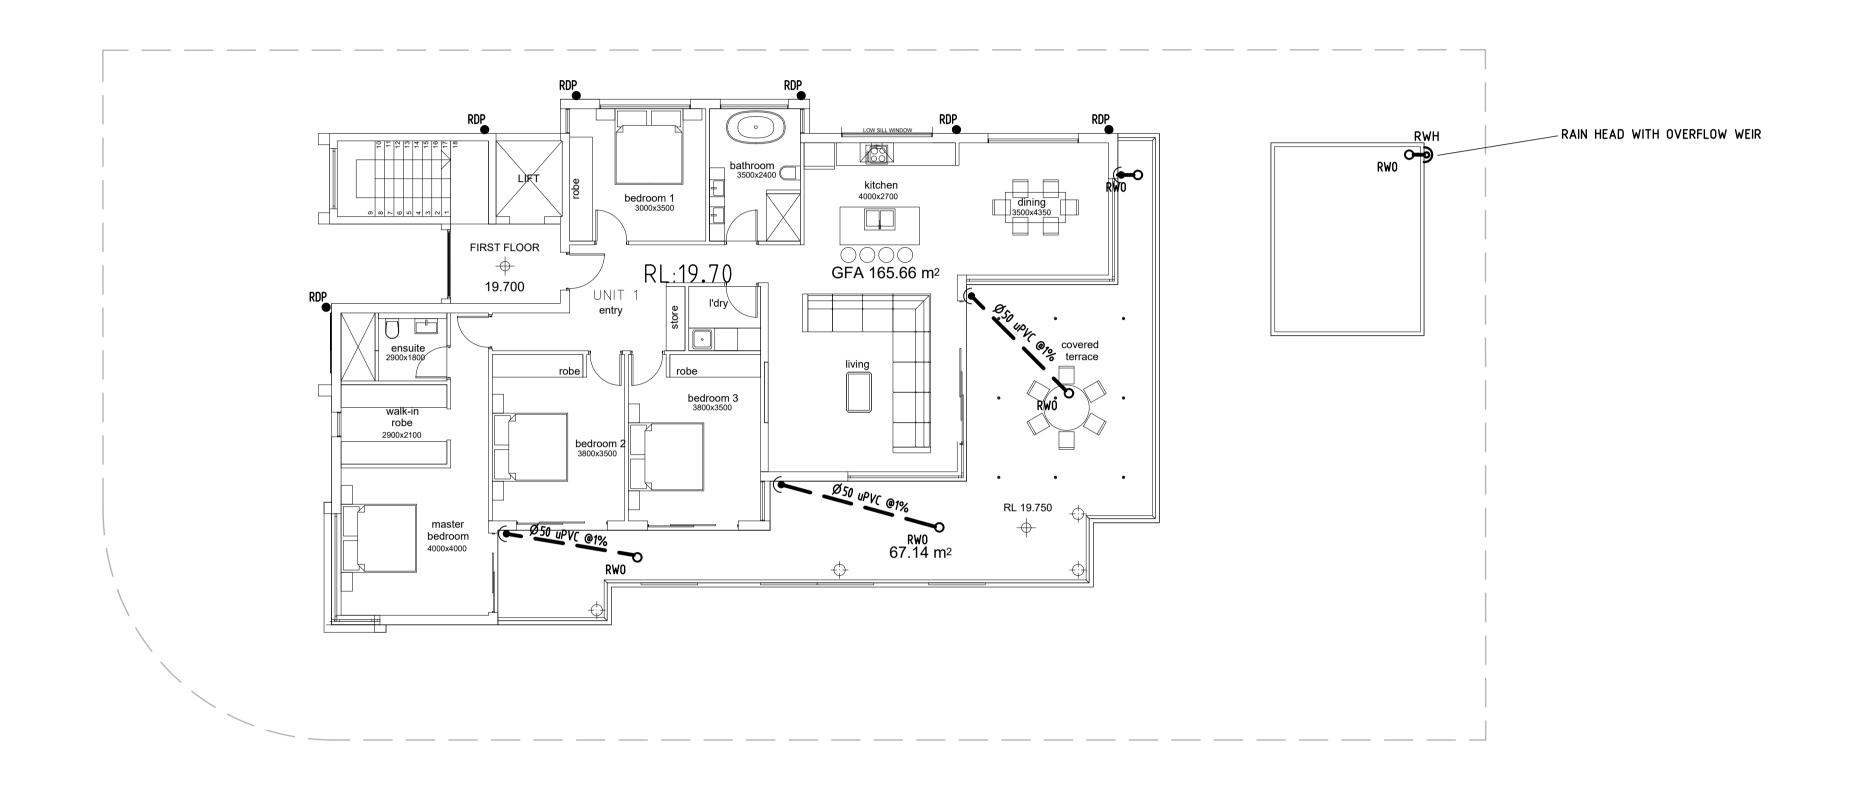

FIRST FLOOR PLAN

SCALE 1:100 (A1) SCALE 1:200 (A3)

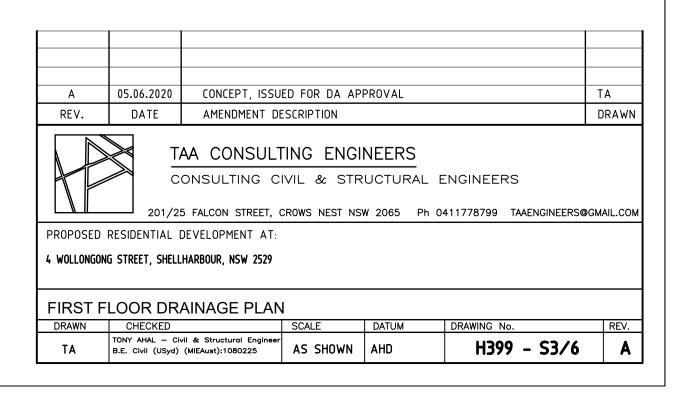


DA No. DA0246/2020

Approval has been granted subject to conditions in the Development Consent accompanying this plan.

These plans may be modified by conditions of consent. Please refer to consent documents for details.




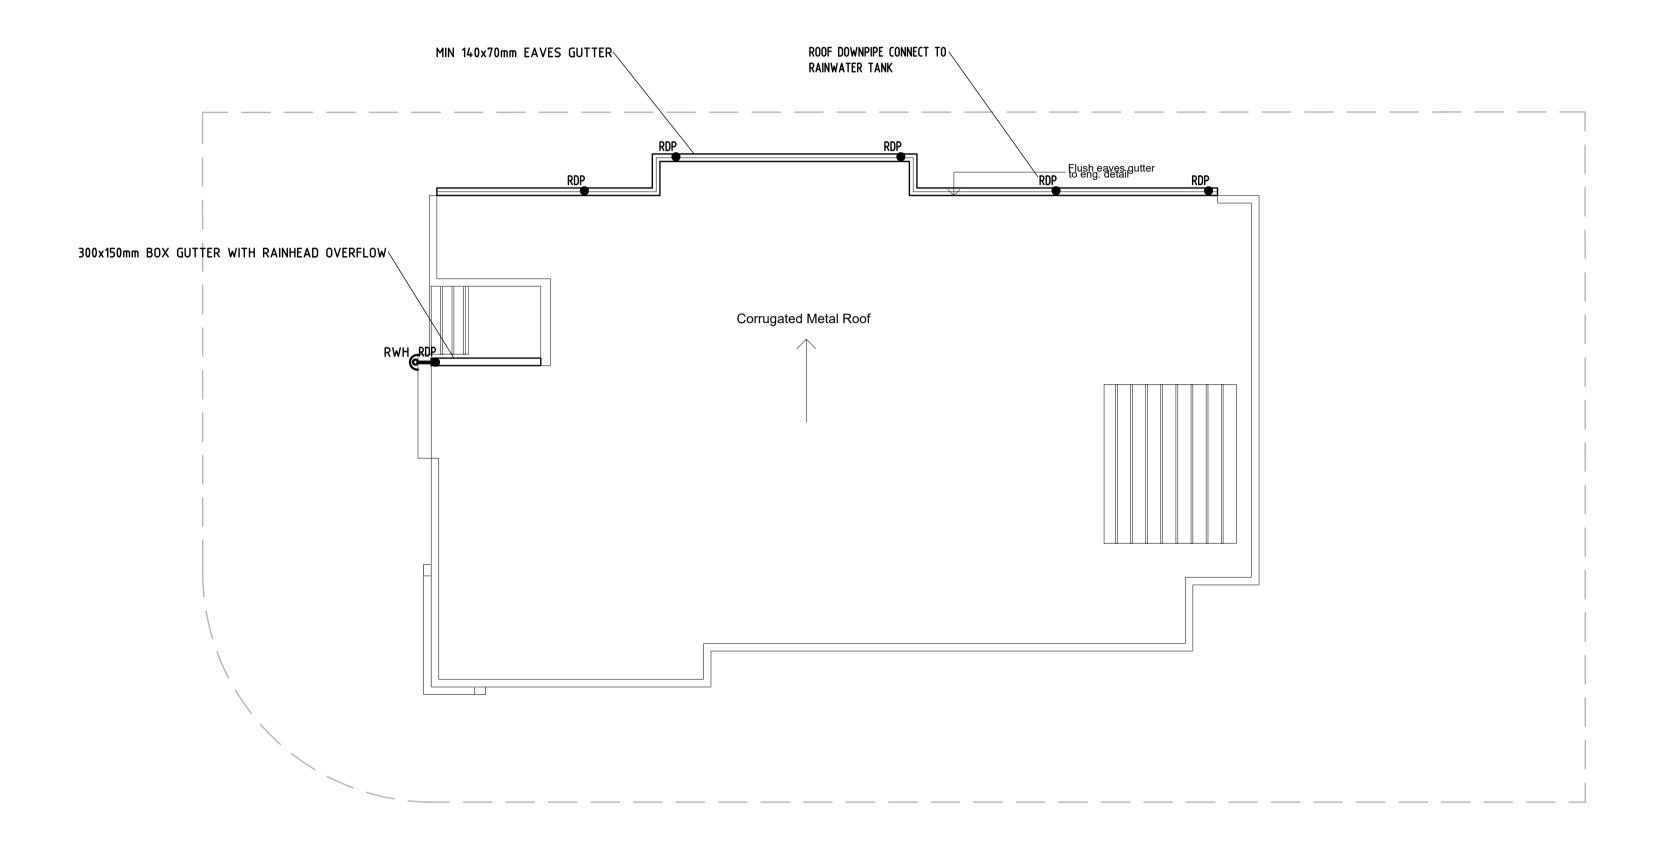


ROOF PLAN


SCALE 1:100 (A1)


SCALE 1:200 (A3)

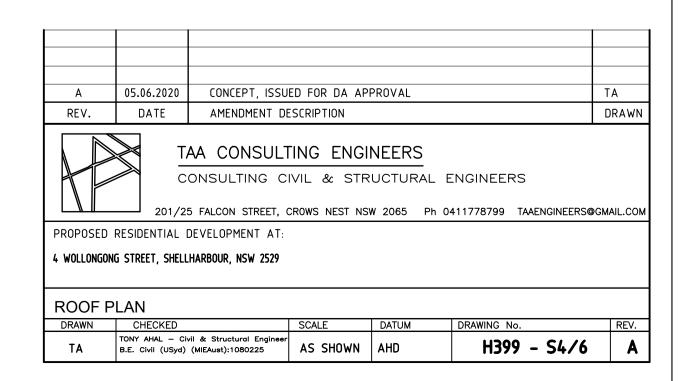




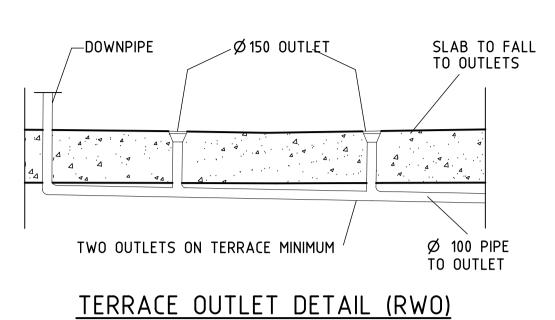


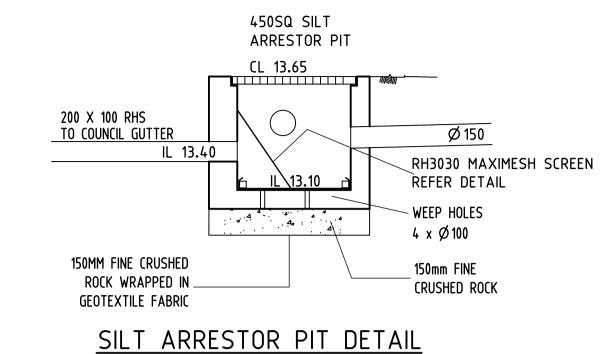

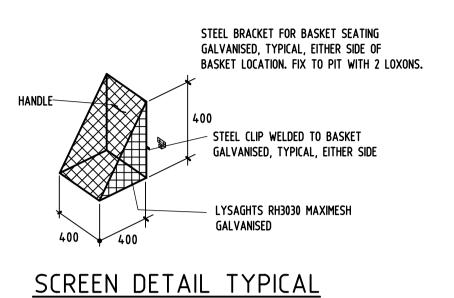


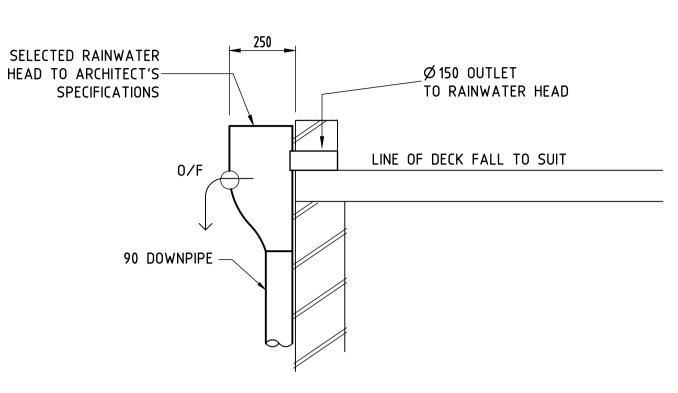



RAIN WATER HEAD DETAIL TYPICAL

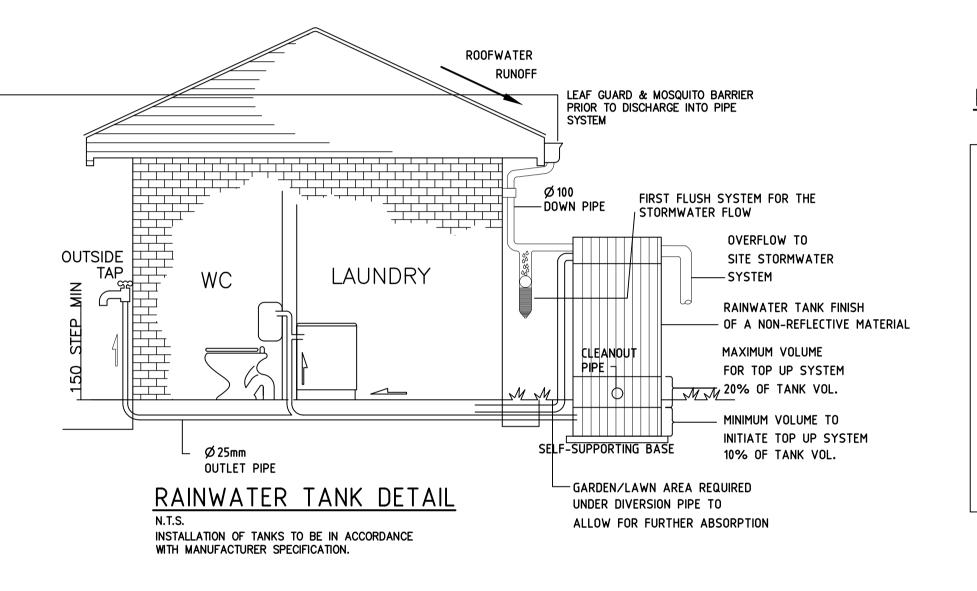

RAINWATER TANK NOTES:

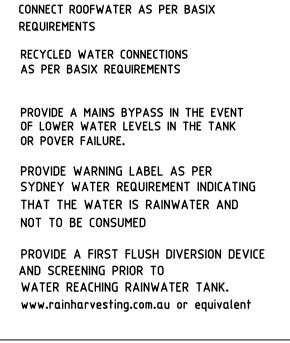

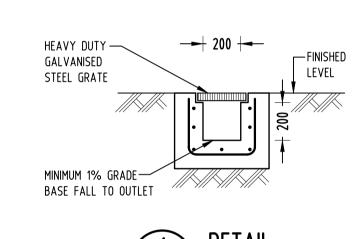


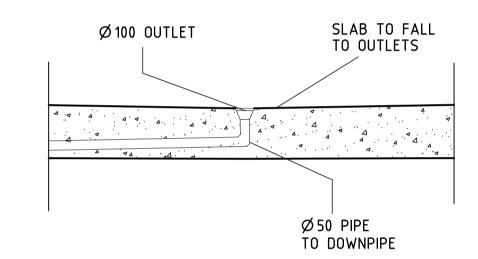



DETAIL


GRATED TRENCH DRAIN
NOT TO SCALE

BALCONY OUTLET DETAIL (RWO)

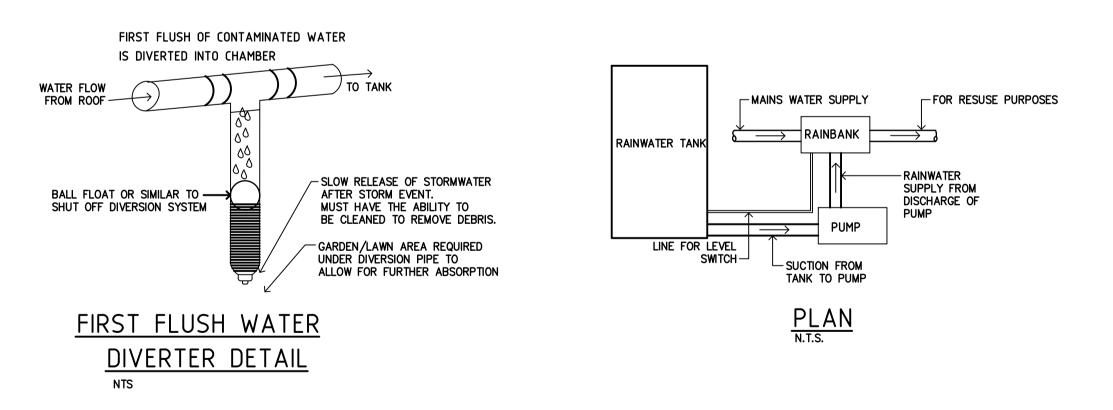

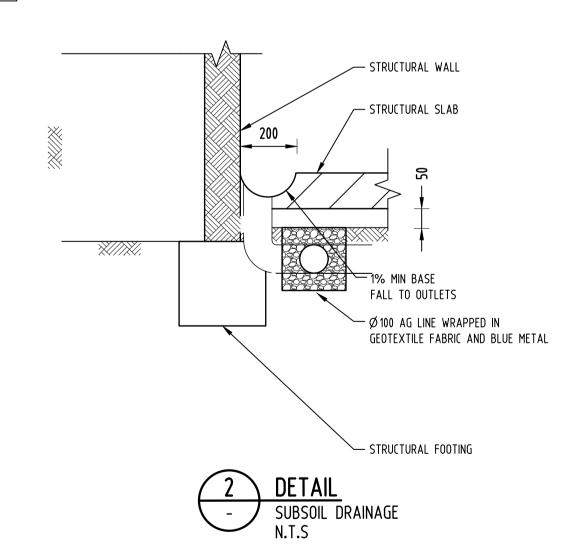

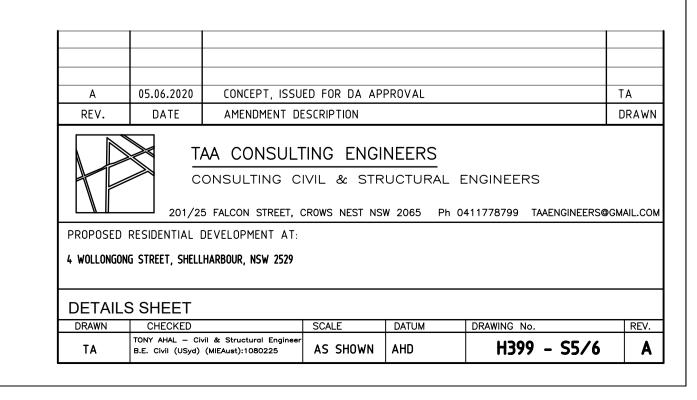

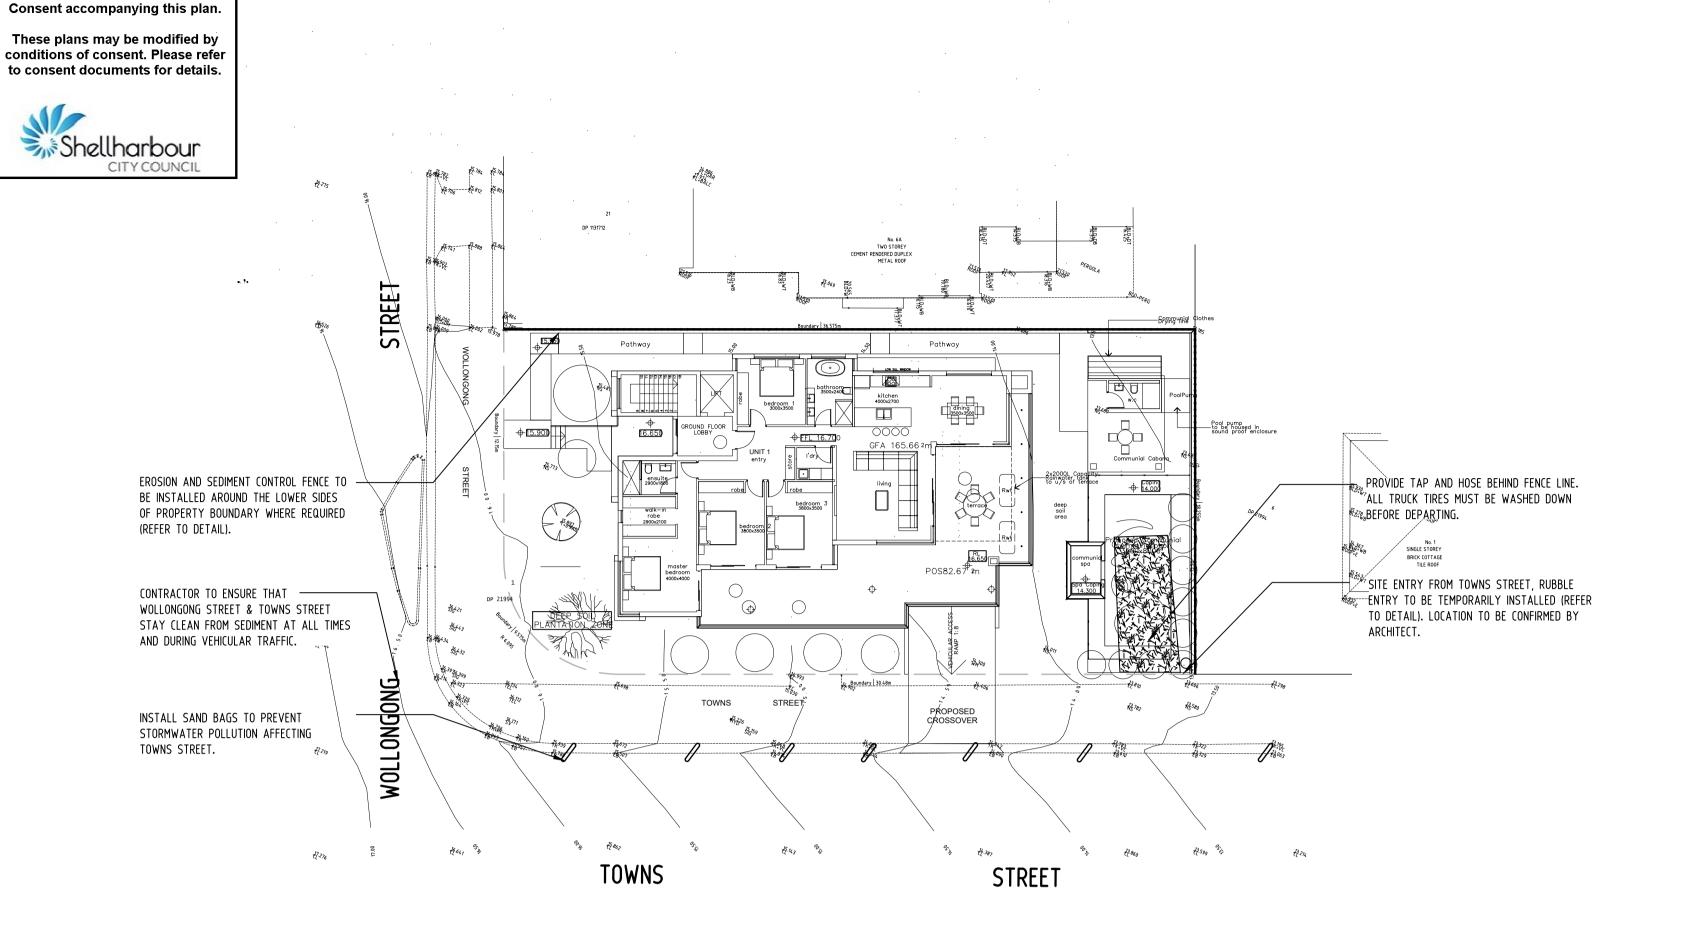

EROSION & SEDIMENTATION CONTROL NOTES

- 1. CONTRACTOR SHALL PROVIDE SEDIMENT FENCING MATERIAL DURING CONSTRUCTION TO THE LOW SIDE OF THE WORKS. TIE SEDIMENT FENCING MATERIAL TO CYCLONE WIRE SECURITY FENCE. SEDIMENT CONTROL FABRIC SHALL BE AN APPROVED MATERIAL (EG. HUMES PROPEX SILT STOP) STANDING 300mm ABOVE GROUND & EXTENDING 150mm BELOW GROUND.
- 2. EXISTING DRAINS LOCATED WITHIN THE SITE SHALL ALSO BE ISOLATED BY SEDIMENT FENCING MATERIAL.
- 3. NO PARKING OR STOCKPILING OF MATERIALS IS PERMITTED ON THE LOWER SIDE OF THE SEDIMENT FENCE.
- 4. GRASS VERGES SHALL BE MAINTAINED AS MUCH AS PRACTICAL TO PROVIDE A BUFFER ZONE TO THE CONSTRUCTION SITE.
- 5. CONSTRUCTION ENTRY/EXIT SHALL BE VIA THE LOCATION NOTED ON THE DRAWING. CONTRACTOR SHALL ENSURE ALL DROPPABLE SOIL & SEDIMENT IS REMOVED PRIOR TO CONSTRUCTION TRAFFIC EXITING SITE. CONTRACTOR SHALL ENSURE ALL CONSTRUCTION TRAFFIC ENTERING & LEAVING THE SITE DO SO IN A FORWARD DIRECTION.


GENERAL NOTES


- THIS PLAN IS A CONCEPT PLAN ONLY FOR STORMWATER DISPOSAL & EROSION CONTROL. IT IS NOT SUITABLE FOR CONSTRUCTION. THIS PLAN SHOULD BE ADAPTED BY THE BUILDER DURING DEMOLITION, EXCAVATION & CONSTRUCTION PHASES TO ENSURE ADEQUATE PERFORMANCE.
- 2. ALL DRAINAGE LAYOUT & DETAILS ARE DIAGRAMMATIC & INDICATIVE ONLY. ACTUAL LOCATION, SIZES, LEVELS & GRADES MAY ALTER WHEN DETAIL DESIGN WORKS ARE DOCUMENTED.


CLAY SOILS

A SYSTEM SHALL BE INSTALLED TO EITHER:

- 1. TRANSPORT STORMWATER RUNOFF WITH SUSPENDED SOLIDS FROM SITE VIA PUMP TRUCKS.
- 2. TREAT THE STORMWATER RUNOFF WITH SUSPENDED SOLIDS SO THE DISCHARGE WATER QUALITY TO COUNCIL STORMWATER DRAINAGE SYSTEM HAS A MAXIMUM CONCENTRATION OF SUSPENDED SOLIDS THAT DOES NOT EXCEED 50 MILLIGRAMS PER LITRE IN ACCORDANCE WITH THE PROTECTION OF THE ENVIRONMENT OPERATION ACT (POEO 1997) AND SHALL BE APPROVED BY LOCAL COUNCIL

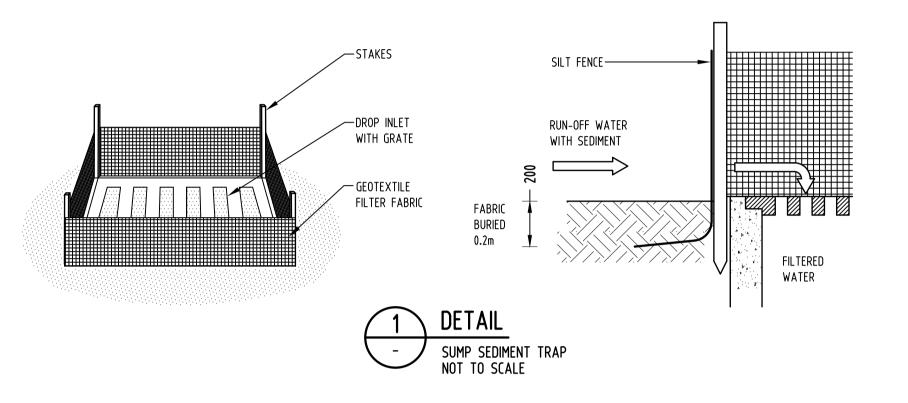

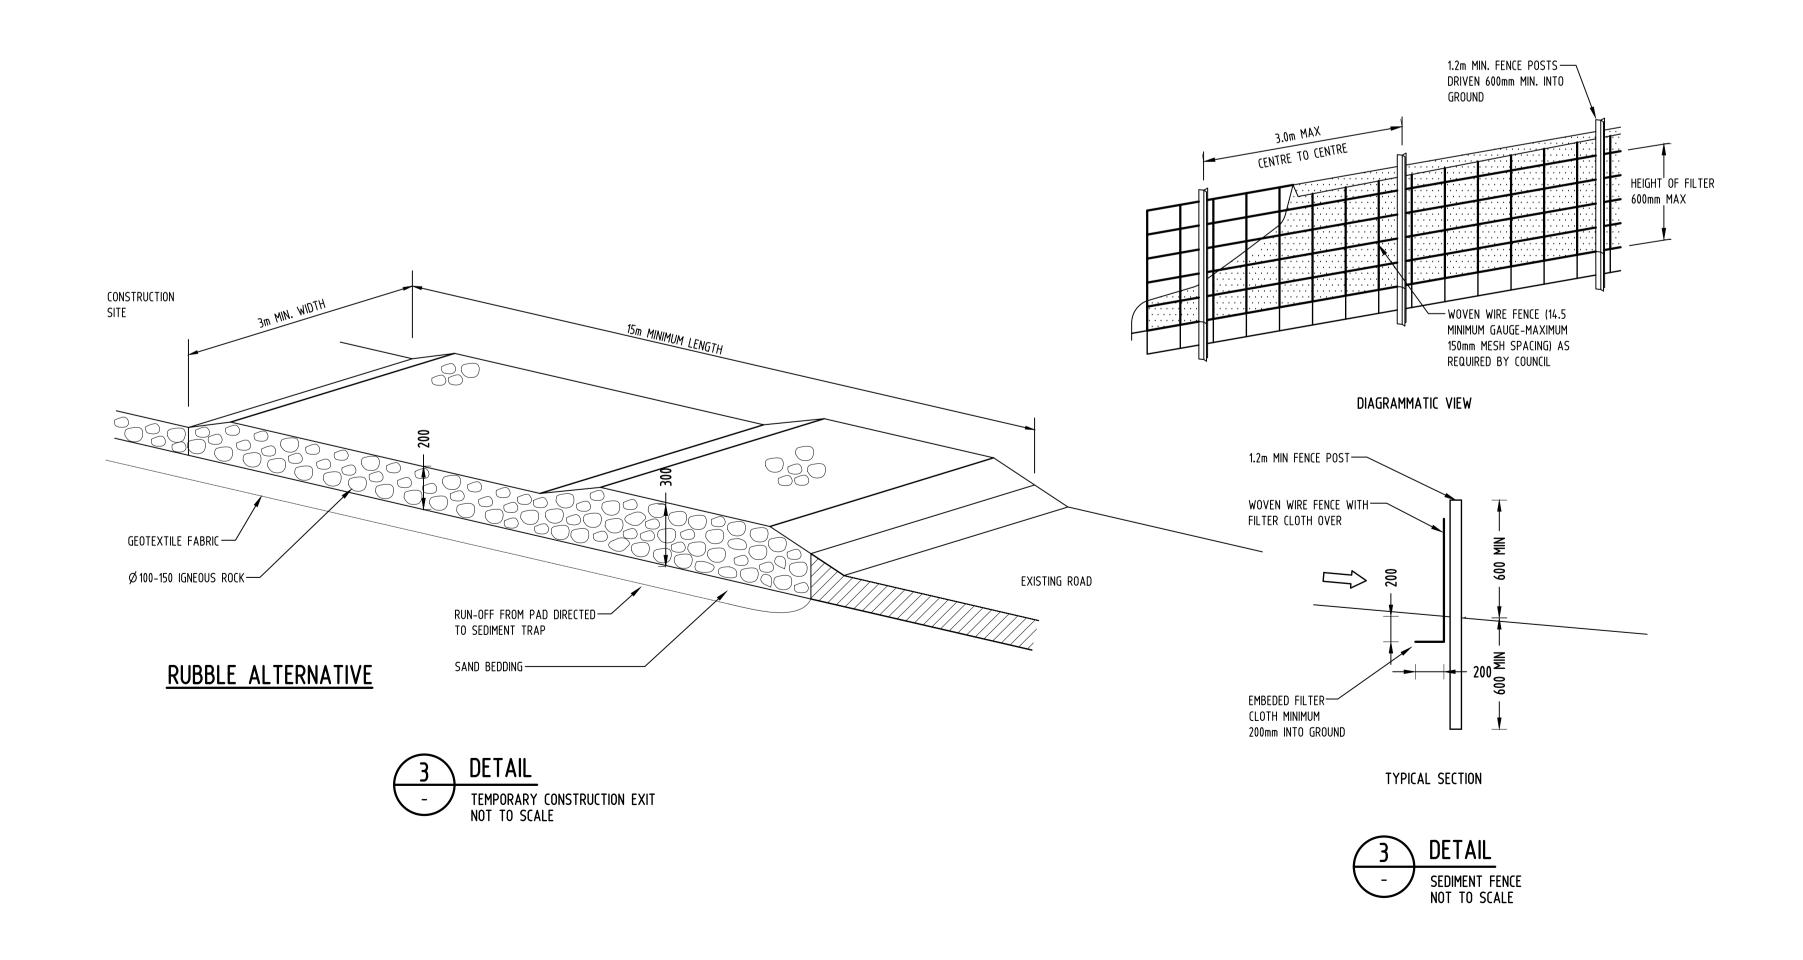

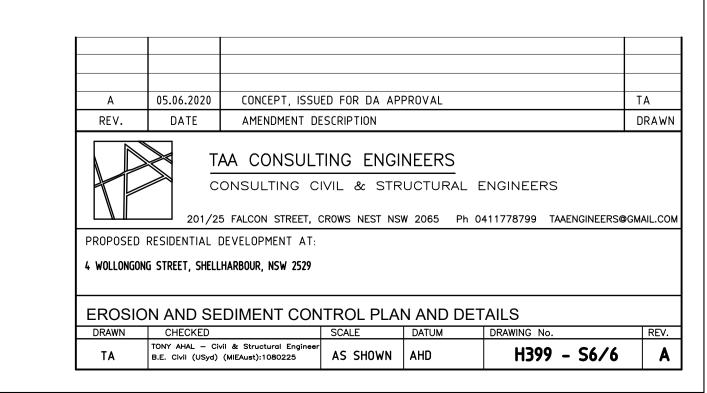

DA No. DA0246/2020

Approval has been granted subject to conditions in the Development

Nil

Nil

Nil

Nil

Nil

Nil

one completion to

recycling company

crushing and

to stockpile at

transfer station

remainder to land-

remainder to metal

Refer to attachment

recyclers

scape suppliers

Approval has been granted subject to conditions in the Development Consent accompanying this plan.

These plans may be modified by conditions of consent. Please refer to consent documents for details.

WASTE MANAGEMENT PLAN 4 Wollongong Street, Shellharbour

SECTION ONE - DEMOLITION STAGE Shellharabaurs on site DESTINATION **DISPOSAL** REUSE AND RECYCLING **Estimated** Type of **ON-SITE OFF-SITE** Material Volume Specify contractor and Specify proposed resuse or Specify contractor and cubic metres on-site recycling methods landfil site recucling outlet Excavation 0.5 remainder to landfill Keep and re-use topsoil Material for landscaping. siteStore on-site. Use some behind retaining walls. 0.5 Green Will be separated. stumps and large Waste Some chipped & stored landscape suppliers trunks separated on-site for re-use on for composting or landscaping reuse Nil**Bricks** 10 Clean lime mortar from Concrete mortar bricks. Re-use bricks bricks to crushing in new footings. Broken and recycling bricks for internal walls company

Existing driveway to remain during

Re-use for formwork

& studwork. Chip

remainder for use in landscaping

Break-up & use in

Broken tiles for fill

On-site sale

landscaping

Nil

construction

2.5

2

2

1

1

Concrete

Timber -

Please

specify

oregon & pine

Plasterboard

Metals

gutters

lead

Other-

roof tiles

door

fittings

water pipes

WASTE MANAGEMENT PLAN: CONSTRUCTION

	SECTION TWO - CONSTRUCTION STAGE					
MATERIAL	LO ON OITE	DESTINATION				
MATERIALS ON-SITE		REUSE AND	DISPOSAL			
Type of Estimated Volume cubic metres		ON-SITE Specify proposed resuse or on-site recycling methods	OFF-SITE Specify contractor and recucling outlet	Specify contractor and landfil site		
Excavation Material						
Green Waste	-	Covered in SECTION 1 As part of demolition				
Bricks	2.5	Use for fill behind retaining walls.	Remainder to crushing and recycling company	Nil		
Concrete	1.5	Use for fill behind retaining walls	remainder to crushing and recycling company	Nil		
Timber - Please specify oregon pine	2	Chip for landscaping. Sell some for firewood.	remainder to landscape suppliers for chipping and composting	Nil		
particle board finishes skirting and architraves						
Plasterboard	1.5	Break-up & use in landscaping	remainder to landscape suppliers	Nil		
Metals Copper 0.5 Nil steel reo mesh aluminium		some to metal recyclers for reuse	Remainder to landfill site by waste contractors			
Other- Plastics Nil		Refer to attachment				

ESTIMATING WASTE

As a guide to estimating waste for inclusion in the waste management plan mentioned above.

TRADE	WASTE ALLOWANCE %
Bricks Brick accessories Concrete Concrete reinforcement Concrete membrane Carpentry Roof tiling Drywall, plasterboard Tiles	2 - 5 10 5 - 10 < 1 10 3 - 15 5 5 - 10 2 - 10

Demolition Waste & Recycling List

Waste Reduction & Recovery Tips:

Materials:	Company Name	Company Address	Contact Details	
Excavation Material / Soil Waste	Enviroguard			
Green Waste	Ecocycle			
Bricks	Brandown			
Concrete	Brandown			
Timber	Artistic Popular Furniture			
Metals	Parramatta Scrap Metal			
Roof Tiles	Obsolete Tiles			
Door Fittings	Recycling Works			
Plastics	Chromford			
Plasterboard	Ecocycle			
Fibro Containing Asbestos	Enviroguard			

ONGOING WASTE MANAGEMENT PLAN

PROPOSED DUAL OCCUPANCY

4 Wollongong Street, Shellharbour

It is proposed that waste generated by the residences of the development will be stored on site in appropriate waste bins.

The location of the bins would be in the basement level, in a designated waste area. The appropriate bins supplied by council would be used for general household waste, recycling and garden waste. It is proposed that the residence would require:

- 2 x General household waste bins
- 2 x recycling bins
- 2 x Garden waste bin

These will be put out once a week on the designated garbage night and brought in the next morning by the residence.



Building Sustainability Index www.basix.nsw.gov.au

Multi Dwelling

Certificate number: 1103768M 02

This certificate confirms that the proposed development will meet the NSW government's requirements for sustainability, if it is built in accordance with the commitments set out below. Terms used in this certificate, or in the commitments, have the meaning given by the document entitled "BASIX Definitions" dated 06/10/2017 published by the Department. This document is available at www.basix.nsw.gov.au

Secretary

Date of issue: Thursday, 04 June 2020

To be valid, this certificate must be lodged within 3 months of the date of issue.



DA No. DA0246/2020

Approval has been granted subject to conditions in the Development Consent accompanying this plan.

These plans may be modified by conditions of consent. Please refer to consent documents for details.



Project summary			
Project name	4 Wollongong St, Shellharbour_02		
Street address	4 Wollongong Street Shellharbour 2529		
Local Government Area	Shellharbour City Council		
Plan type and plan number	deposited 21994		
Lot no.	1		
Section no.	-		
No. of residential flat buildings	0		
No. of units in residential flat buildings	0		
No. of multi-dwelling houses	2		
No. of single dwelling houses	0		
Project score			
Water	√ 45 Target 40		
Thermal Comfort	✓ Pass Target Pass		
Energy	✓ 55 Target 50		

Certificate Prepared by

Name / Company Name: BCA Energy Pty Ltd

ABN (if applicable): 72159518260

BASIX Planning, Industry & Environment www.basix.nsw.gov.au Version: 3.0 / DARWINIA_3_11_6 Certificate No.: 1103768M_02 Thursday, 04 June 2020 page 1/13

Document Set ID: 11451139 Version: 1, Version Date: 09/06/2020

Description of project

Project address		
Project name	4 Wollongong St, Shellharbour_02	
Street address	4 Wollongong Street Shellharbour 2529	
Local Government Area	Shellharbour City Council	
Plan type and plan number	deposited 21994	
Lot no.	1	
Section no.	-	
Project type		
No. of residential flat buildings	0	
No. of units in residential flat buildings	0	
No. of multi-dwelling houses	2	
No. of single dwelling houses	0	
Site details		
Site area (m²)	657	
Roof area (m²)	247	
Non-residential floor area (m²)	0.0	
Residential car spaces	4	
Non-residential car spaces	0	

Common area landscape						
Common area lawn (m²)	100.0					
Common area garden (m²)	100.0					
Area of indigenous or low water use species (m²)	100.0					
Assessor details	Assessor details					
Assessor number	20039					
Certificate number	0004890650					
Climate zone	18					
Project score						
Water	✓ 45 Target 40					
Thermal Comfort	✓ Pass Target Pass					
Energy	✓ 55 Target 50					

BASIX Planning, Industry & Environment www.basix.nsw.gov.au Version: 3.0 / DARWINIA_3_11_6 Certificate No.: 1103768M_02 Thursday, 04 June 2020 page 2/13

Document Set ID: 11451139 Version: 1, Version Date: 09/06/2020

Description of project

The tables below describe the dwellings and common areas within the project

Multi-dwelling houses

Dwelling no.	No. of bedrooms	Conditioned floor area (m²)	Unconditioned floor area (m²)	Area of garden & lawn (m²)	Indigenous species (min area m²)
1	or mo	165.5 ore drooms	0.0	0.0	0.0

Dwelling no.	No. of bedrooms	Conditioned floor area (m²)	Unconditioned floor area (m²)	Area of garden & lawn (m²)	Indigenous species (min area m²)
2	4 or mo	165.5 ore drooms	0.0	0.0	0.0

BASIX Planning, Industry & Environment www.basix.nsw.gov.au Version: 3.0 / DARWINIA_3_11_6 Certificate No.: 1103768M_02 Thursday, 04 June 2020 page 3/13

Description of project

The tables below describe the dwellings and common areas within the project

Common areas of the development (non-building specific)

Common area	Floor area (m²)
Car park area (No. 1)	166.0
Plant or service room (No. 1)	10.5

Common area	Floor area (m²)
Lift car (No.1)	-

Common area	Floor area (m²)
Garbage room (No. 1)	10.6

BASIX Planning, Industry & Environment www.basix.nsw.gov.au Version: 3.0 / DARWINIA_3_11_6 Certificate No.: 1103768M_02 Thursday, 04 June 2020 page 4/13

Document Set ID: 11451139 Version: 1, Version Date: 09/06/2020

Schedule of BASIX commitments

- 1. Commitments for multi-dwelling houses
 - (a) Dwellings
 - (i) Water
 - (ii) Energy
 - (iii) Thermal Comfort
- 2. Commitments for single dwelling houses
- 3. Commitments for common areas and central systems/facilities for the development (non-building specific)
 - (i) Water
 - (ii) Energy

BASIX Planning, Industry & Environment www.basix.nsw.gov.au Version: 3.0 / DARWINIA_3_11_6 Certificate No.: 1103768M_02 Thursday, 04 June 2020 page 5/13

Schedule of BASIX commitments

The commitments set out below regulate how the proposed development is to be carried out. It is a condition of any development consent granted, or complying development certificate issued, for the proposed development, that BASIX commitments be complied with.

1. Commitments for multi-dwelling houses

(a) Dwellings

(i) Water	Show on DA plans	Show on CC/CDC plans & specs	Certifier check
(a) The applicant must comply with the commitments listed below in carrying out the development of a dwelling listed in a table below.			
(b) The applicant must plant indigenous or low water use species of vegetation throughout the area of land specified for the dwelling in the "Indigenous species" column of the table below, as private landscaping for that dwelling. (This area of indigenous vegetation is to be contained within the "Area of garden and lawn" for the dwelling specified in the "Description of Project" table).	~	~	
(c) If a rating is specified in the table below for a fixture or appliance to be installed in the dwelling, the applicant must ensure that each such fixture and appliance meets the rating specified for it.		~	V
(d) The applicant must install an on demand hot water recirculation system which regulates all hot water use throughout the dwelling, where indicated for a dwelling in the "HW recirculation or diversion" column of the table below.		~	V
(e) The applicant must install:			
(aa) a hot water diversion system to all showers, kitchen sinks and all basins in the dwelling, where indicated for a dwelling in the "HW recirculation or diversion" column of the table below; and		•	V
(bb) a separate diversion tank (or tanks) connected to the hot water diversion systems of at least 100 litres. The applicant must connect the hot water diversion tank to all toilets in the dwelling.		✓	~
(e) The applicant must not install a private swimming pool or spa for the dwelling, with a volume exceeding that specified for it in the table below.	V	~	
(f) If specified in the table, that pool or spa (or both) must have a pool cover or shading (or both).		~	
(g) The pool or spa must be located as specified in the table.	V	✓	
(h) The applicant must install, for the dwelling, each alternative water supply system, with the specified size, listed for that dwelling in the table below. Each system must be configured to collect run-off from the areas specified (excluding any area which supplies any other alternative water supply system), and to divert overflow as specified. Each system must be connected as specified.	~	~	~

BASIX Planning, Industry & Environment www.basix.nsw.gov.au Version: 3.0 / DARWINIA_3_11_6 Certificate No.: 1103768M_02 Thursday, 04 June 2020 page 6/13

Document Set ID: 11451139 Version: 1, Version Date: 09/06/2020

	Fixtures			Appli	Appliances Individual pool				Individual spa					
Dwelling no.	All shower- heads	All toilet flushing systems	All kitchen taps	All bathroom taps	HW recirculation or diversion	All clothes washers	All dish- washers	Volume (max volume)	Pool cover	Pool location	Pool shaded	Volume (max volume)	Spa cover	Spa shaded
All dwellings	3 star (> 4.5 but <= 6 L/min)	4 star	5 star	5 star	no	-	-	-	-	-	-	-	-	-

		Alternative water source							
Dwelling no.	Alternative water supply systems	Size	Configuration	Landscape connection	Toilet connection (s)	Laundry connection	Pool top-up	Spa top-up	
All dwellings	central water tank (no. 1)	See central systems	See central systems	-	yes	-	-	-	
None	-	-	-	-	-	-	-	-	

(ii) Energy	Show on DA plans	Show on CC/CDC plans & specs	Certifier check
(a) The applicant must comply with the commitments listed below in carrying out the development of a dwelling listed in a table below.			
(b) The applicant must install each hot water system specified for the dwelling in the table below, so that the dwelling's hot water is supplied by that system. If the table specifies a central hot water system for the dwelling, then the applicant must connect that central system to the dwelling, so that the dwelling's hot water is supplied by that central system.	~	~	~
(c) The applicant must install, in each bathroom, kitchen and laundry of the dwelling, the ventilation system specified for that room in the table below. Each such ventilation system must have the operation control specified for it in the table.		~	V
(d) The applicant must install the cooling and heating system/s specified for the dwelling under the "Living areas" and "Bedroom areas" headings of the "Cooling" and "Heating" columns in the table below, in/for at least 1 living/bedroom area of the dwelling. If no cooling or heating system is specified in the table for "Living areas" or "Bedroom areas", then no systems may be installed in any such areas. If the term "zoned" is specified beside an air conditioning system, then the system must provide for day/night zoning between living areas and bedrooms.		~	~
(e) This commitment applies to each room or area of the dwelling which is referred to in a heading to the "Artificial lighting" column of the table below (but only to the extent specified for that room or area). The applicant must ensure that the "primary type of artificial lighting" for each such room in the dwelling is fluorescent lighting or light emitting diode (LED) lighting. If the term "dedicated" is specified for a particular room or area, then the light fittings in that room or area must only be capable of being used for fluorescent lighting or light emitting diode (LED) lighting.		~	~

BASIX

Document Set ID: 11451139 Version: 1, Version Date: 09/06/2020

Planning, Industry & Environment www.basix.nsw.gov.au

(ii) Energy	Show on DA plans	Show on CC/CDC plans & specs	Certifier check
(f) This commitment applies to each room or area of the dwelling which is referred to in a heading to the "Natural lighting" column of the table below (but only to the extent specified for that room or area). The applicant must ensure that each such room or area is fitted with a window and/or skylight.	~	~	~
(g) This commitment applies if the applicant installs a water heating system for the dwelling's pool or spa. The applicant must:			
(aa) install the system specified for the pool in the "Individual Pool" column of the table below (or alternatively must not install any system for the pool). If specified, the applicant must install a timer, to control the pool's pump; and		✓	
(bb) install the system specified for the spa in the "Individual Spa" column of the table below (or alternatively must not install any system for the spa). If specified, the applicant must install a timer to control the spa's pump.		✓	
(h) The applicant must install in the dwelling:			
(aa) the kitchen cook-top and oven specified for that dwelling in the "Appliances & other efficiency measures" column of the table below;		✓	
(bb) each appliance for which a rating is specified for that dwelling in the "Appliances & other efficiency measures" column of the table, and ensure that the appliance has that minimum rating; and		✓	V
(cc) any clothes drying line specified for the dwelling in the "Appliances & other efficiency measures" column of the table.		~	
(i) If specified in the table, the applicant must carry out the development so that each refrigerator space in the dwelling is "well ventilated".		~	
(j) The applicant must install the photovoltaic system specified for the dwelling under the "Photovoltaic system" heading of the "Alternative energy" column of the table below, and connect the system to that dwelling's electrical system.	V	~	V

	Hot water	Bathroom ventilation system		Kitchen venti	lation system	Laundry ventilation system		
Dwelling no.	Hot water system	Each bathroom	Operation control	Each kitchen	Operation control	Each laundry	Operation control	
All dwellings	gas instantaneous 6 star	individual fan, ducted to façade or roof	manual switch on/off	individual fan, ducted to façade or roof	manual switch on/off	individual fan, ducted to façade or roof	manual switch on/off	

BASIX Planning, Industry & Environment www.basix.nsw.gov.au Version: 3.0 / DARWINIA_3_11_6 Certificate No.: 1103768M_02 Thursday, 04 June 2020 page 8/13

	Coo	ling	Hea	ting			Artificial	lighting			Natural lig	ghting
Dwelling no.	living areas	bedroom areas	living areas	bedroom areas	No. of bedrooms &/or study	No. of living &/or dining rooms	Each kitchen	All bathrooms/ toilets	Each laundry	All hallways	No. of bathrooms &/or toilets	Main kitche
All dwellings	1-phase airconditioning 3.5 Star (old label)	1-phase airconditioning 3.5 Star (old label)	1-phase airconditioning 3.5 Star (old label)	1-phase airconditioning 3.5 Star (old label)	4 (dedicated)	1 (dedicated)	yes (dedicated)	yes (dedicated)	yes (dedicated)	yes (dedicated)	1	yes

	Individual pool		Individual spa		Appliances & other efficiency measures			Appliances & other efficiency measures				
Dwelling no.	Pool heating system	Timer	Spa heating system	Timer	Kitchen cooktop/oven	Refrigerator	Well ventilated fridge space	Dishwasher	Clothes washer	Clothes dryer	Indoor or sheltered clothes drying line	Private outdoor or unsheltered clothes drying line
All dwellings	-	-	-	-	gas cooktop & electric oven	-	yes	-	-	-	no	no

	Alternative energy
Dwelling no.	Photovoltaic system (min rated electrical output in peak kW)
All dwellings	5.0

(iii) Thermal Comfort	Show on DA plans	Show on CC/CDC plans & specs	Certifier check
(a) The applicant must attach the certificate referred to under "Assessor details" on the front page of this BASIX certificate (the "Assessor Certificate") to the development application and construction certificate application for the proposed development (or, if the applicant is applying for a complying development certificate for the proposed development, to that application). The applicant must also attach the Assessor Certificate to the application for a final occupation certificate for the proposed development.			
(b) The Assessor Certificate must have been issued by an Accredited Assessor in accordance with the Thermal Comfort Protocol.			
(c) The details of the proposed development on the Assessor Certificate must be consistent with the details shown in this BASIX Certificate, including the details shown in the "Thermal Loads" table below.			

BASIX

Document Set ID: 11451139 Version: 1, Version Date: 09/06/2020

Planning, Industry & Environment www.basix.nsw.gov.au

(iii) Thermal Comfort	Show on DA plans	Show on CC/CDC plans & specs	Certifier check
(d) The applicant must show on the plans accompanying the development application for the proposed development, all matters which the Thermal Comfort Protocol requires to be shown on those plans. Those plans must bear a stamp of endorsement from the Accredited Assessor, to certify that this is the case.	~		
(e) The applicant must show on the plans accompanying the application for a construction certificate (or complying development certificate, if applicable), all thermal performance specifications set out in the Assessor Certificate, and all aspects of the proposed development which were used to calculate those specifications.		~	
(f) The applicant must construct the development in accordance with all thermal performance specifications set out in the Assessor Certificate, and in accordance with those aspects of the development application or application for a complying development certificate which were used to calculate those specifications.		~	~
(g) Where there is an in-slab heating or cooling system, the applicant must:	V	~	V
(aa) Install insulation with an R-value of not less than 1.0 around the vertical edges of the perimeter of the slab; or			
(bb) On a suspended floor, install insulation with an R-value of not less than 1.0 underneath the slab and around the vertical edges of the perimeter of the slab.			
(h) The applicant must construct the floors and walls of the development in accordance with the specifications listed in the table below.	•	•	V

	Thermal loads					
Dwelling no.	Area adjusted heating load (in mJ/m²/yr)	Area adjusted cooling load (in mJ/m²/yr)				
1	72.5	27.6				
All other dwellings	69.4	29.4				

	Construction of floors and walls				
Dwelling no.	Concrete slab on ground(m²)	Suspended floor with open subfloor (m²)	Suspended floor with endclosed subfloor (m²)	Suspended floor above garage (m²)	Primarily rammed earth or mudbrick walls
1	-	-	-	165	No
All other dwellings	165	-	-	-	No

page 10/13

BASIX Planning, Industry & Environment www.basix.nsw.gov.au Version: 3.0 / DARWINIA_3_11_6 Certificate No.: 1103768M_02 Thursday, 04 June 2020

Document Set ID: 11451139 Version: 1, Version Date: 09/06/2020

3. Commitments for common areas and central systems/facilities for the development (non-building specific)

(b) Common areas and central systems/facilities

(i) Water	Show on DA plans	Show on CC/CDC plans & specs	Certifier check
(a) If, in carrying out the development, the applicant installs a showerhead, toilet, tap or clothes washer into a common area, then that item must meet the specifications listed for it in the table.		~	V
(b) The applicant must install (or ensure that the development is serviced by) the alternative water supply system(s) specified in the "Central systems" column of the table below. In each case, the system must be sized, be configured, and be connected, as specified in the table.	~	~	~
(c) A swimming pool or spa listed in the table must not have a volume (in kLs) greater than that specified for the pool or spa in the table.	V	~	
(d) A pool or spa listed in the table must have a cover or shading if specified for the pool or spa in the table.		~	
(e) The applicant must install each fire sprinkler system listed in the table so that the system is configured as specified in the table.		~	V
(f) The applicant must ensure that the central cooling system for a cooling tower is configured as specified in the table.		V	V

Common area	Showerheads rating	Toilets rating	Taps rating	Clothes washers rating
All common areas	3 star (> 4.5 but <= 6 L/min)	4 star	5 star	no common laundry facility

Central systems	Size	Configuration	Connection (to allow for)
Central water tank - rainwater or stormwater (No. 1)	4000.0	To collect run-off from at least: - 200.0 square metres of roof area of buildings in the development	- irrigation of 200.0 square metres of common landscaped area on the site
Pool (No. 1)	Volume: 42.0 kLs	Location: Other Pool shaded: no	-
Spa (No. 1)	Volume: 6.0 kLs	Location: Other Spa shaded: no Spa cover: yes	-

Certificate No.: 1103768M_02

BASIX

Planning, Industry & Environment www.basix.nsw.gov.au

Document Set ID: 11451139 Version: 1, Version Date: 09/06/2020

(ii) Energy	Show on DA plans	Show on CC/CDC plans & specs	Certifier check
(a) If, in carrying out the development, the applicant installs a ventilation system to service a common area specified in the table below, then that ventilation system must be of the type specified for that common area, and must meet the efficiency measure specified.		~	~
(b) In carrying out the development, the applicant must install, as the "primary type of artificial lighting" for each common area specified in the table below, the lighting specified for that common area. This lighting must meet the efficiency measure specified. The applicant must also install a centralised lighting control system or Building Management System (BMS) for the common area, where specified.		~	~
(c) The applicant must install the systems and fixtures specified in the "Central energy systems" column of the table below. In each case, the system or fixture must be of the type, and meet the specifications, listed for it in the table.	V	~	V

	Common area ventilation system		Common area lighting		
Common area	Ventilation system type	Ventilation efficiency measure	Primary type of artificial lighting	Lighting efficiency measure	Lighting control system/BMS
Car park area (No. 1)	no mechanical ventilation	-	fluorescent	motion sensors	No
Lift car (No.1)	-	-	light-emitting diode	connected to lift call button	No
Garbage room (No. 1)	ventilation exhaust only	-	fluorescent	motion sensors	No
Plant or service room (No. 1)	no mechanical ventilation	-	fluorescent	motion sensors	No

Central energy systems	Туре	Specification
Lift (No. 1)	gearless traction with V V V F motor	Number of levels (including basement): 3
Pool (No. 1)	Heating source: no heating	Pump controlled by timer: yes
Spa (No. 1)	Heating system: gas	Pump controlled by timer: yes

BASIX Planning, Industry & Environment www.basix.nsw.gov.au Version: 3.0 / DARWINIA_3_11_6 Certificate No.: 1103768M_02 Thursday, 04 June 2020 page 12/13

Notes

- 1. In these commitments, "applicant" means the person carrying out the development.
- 2. The applicant must identify each dwelling, building and common area listed in this certificate, on the plans accompanying any development application, and on the plans and specifications accompanying the application for a construction certificate / complying development certificate, for the proposed development, using the same identifying letter or reference as is given to that dwelling, building or common area in this certificate.
- 3. This note applies if the proposed development involves the erection of a building for both residential and non-residential purposes (or the change of use of a building for both residential and non-residential purposes). Commitments in this certificate which are specified to apply to a "common area" of a building or the development, apply only to that part of the building or development to be used for residential purposes.
- 4. If this certificate lists a central system as a commitment for a dwelling or building, and that system will also service any other dwelling or building within the development, then that system need only be installed once (even if it is separately listed as a commitment for that other dwelling or building).
- 5. If a star or other rating is specified in a commitment, this is a minimum rating.
- 6. All alternative water systems to be installed under these commitments (if any), must be installed in accordance with the requirements of all applicable regulatory authorities. NOTE: NSW Health does not recommend that stormwater, recycled water or private dam water be used to irrigate edible plants which are consumed raw, or that rainwater be used for human consumption in areas with potable water supply.

Legend

- 1. Commitments identified with a " in the "Show on DA plans" column must be shown on the plans accompanying the development application for the proposed development (if a development application is to be lodged for the proposed development).
- 2. Commitments identified with a " in the "Show on CC/CDC plans and specs" column must be shown in the plans and specifications accompanying the application for a construction certificate / complying development certificate for the proposed development.
- 3. Commitments identified with a " in the "Certifier check" column must be certified by a certifying authority as having been fulfilled. (Note: a certifying authority must not issue an occupation certificate (either interim or final) for a building listed in this certificate, or for any part of such a building, unless it is satisfied that each of the commitments whose fulfilment it is required to monitor in relation to the building or part, has been fulfilled).

BASIX Planning, Industry & Environment www.basix.nsw.gov.au Version: 3.0 / DARWINIA_3_11_6 Certificate No.: 1103768M_02 Thursday, 04 June 2020 page 13/13

Document Set ID: 11451139 Version: 1, Version Date: 09/06/2020